April 2020 Checked by:

117013

Job Number: Sheet

ABBREVIATIONS

AC	AIR CONDITIONING	LAV	LAVATORY
ACT	ACOUSITICAL CEILING TILE	LF	LINEAL FOOT
ADJ	ADJUSTABLE	LKR	LOCKER
AFF	ABOVE FINISH FLOOR	LVR	LOUVER
ALT	ALTERNATE	LVT	LUXURY VINYL TILE
ALUM	ALUMINUM	MATL	MATERIAL
APC	ACOUSITICAL PANEL CEILING	MAX	MAXIMUM
APPROX	APPROXIMATE	MDF	MEDIUM DENSITY BOARD
ARCH	ARCHITURAL	МЕСН	MECHANICAL
AV	AUDIO VISUAL	MEZZ	MEZZANINE
В	BASE	MFR	MANUFACTURER
BLK	BLOCKING	MIN	MINIMUM
BKR	BACKER	MIR	MIRROR
BLDG	BUILDING	MISC	MISCELLANEOUS
ВМ	BEAM	MTD	MOUNTED
BOD	BASIS OF DESIGN	MTL	METAL
ВОТ	ВОТТОМ	MU	MULLION
C	CARPET	MW	MICROWAVE
CAB	CABINET	NIC	NOT IN CONTRACT

NOT TO SCALE

POLISHED CONCRETE

PLASTIC LAMINATE

ON CENTER

OVERHEAD

PERFORATED

PAINT

PAIR

POLISHED

PLYWOOD

QUANTITY

RELOCATED

RUBBER BASE

RECESSED REFERENCE

REFLECTED CEILING PLAN

REVISION OR REVISED

ROUGH OPENING

SEALED CONCRETE

SOAP DISPENSER SQUARE FEET/FOOT

SAFETY GLASS

STAINLESS STEEL

SOLID SURFACE MATERIAL

SHEET

SIMILAR

SPRINKLE

SHEET VINY STANDARD

TO BE DETERMINED

TIME AND MATERIAL

UNLESS OTHERWISE NOTED

VINYL COMPOSITION TILE

UNINTERUPTED POWER SUPPLY

SPEAKER

STONE

STEEL

SUSP SUSPENDED

THICKNESS

TOP OF SLAB

TYPICAL

VERIFY

WOOD

WITHOUT

WATER CLOSET

WALL HUNG

WATER HEATER

UNFINISHED

TOP OF

SPKR

RCP

POWER POLE

CLRCOL**COLUMN** CORRIDOR CONCCONCRETE **CASEWORK** DEMOLITION DRINKING FOUNTAIN

CORNER GUARD

CENTER LINE

DIAMETER DIMENSION DISHWASHER DWG DRAWING DRAWER ELECTRICAL ELEVATOR

EQ **EQUIPMENT** EXTERIOR FIRE ALARM FLOOR DRAIN FIRE EXTINGUISHER FIRE EXTINGUISHER CABINET

FACTORY FINISH FIN FIXT FLOORING FACE OF FURNISHED BY OWNER, INSTALLED BY CONTRACTOR

FUNISHED BY TENANT, INSTALLED BY CONSTRACTOR *FURR*

FIRE RATED

GENERAL CONTRACTOR GYPSUM WALLBOARD

HANDICAPPED *HARDWARE* HOLLOW METAL (STEEL FRAME) INCLUDED OR INCLUDING

INSULATION **JANITOR** JANKD KNOCK DOWN FRAME **QUARTZ**

PROJECT TEAM

Owner

POWIN DEVELOPMENT 11325 SW TUALATIN-SHERWOOD RD TUALATIN. OREGON 97062

Architect

MILDREN DESIGN GROUP, P.C. 7650 SW BEVELAND STREET, SUITE 120 TIGARD, OREGON 97223 VOICE: 503-244-0552 FAX: 503-244-0417 CONTACT PERSON: Curt Trolan EMAIL: curt@mdgpc.om

Structural Engineer

TM RIPPEY CONSULTING ENGINEERS 7650 SW BEVELAND STREET, SUITE 100 TIGARD, OREGON 97223 VOICE: 503-443-3900 CONTACT PERSON: Ralph Turnbaugh EMAIL: rturnbaugh@tmrippey.com

TM RIPPEY CONSULTING ENGINEERS 7650 SW BEVELAND STREET, SUITE 100 TIGARD, OREGON 97223 VOICE: 503-443-3900 CONTACT PERSON: Karl Koroch

AAI ENGINEERING, INC BEAVERTON, OREGON 97005 VOICE: 503-352-7685 CONTACT PERSON: Teresa Long EMAIL: Teresal@aaieng.com

Landscape Architect

Civil Engineer

EMAIL: kkoroch@tmrippey.com

4875 S.W. GRIFFITH DRIVE, SUITE 300

DRAWING INDEX-ARCHITECTURAL

A1.1 SITE PLAN GENERAL NOTES AND LEGEND EXISTING CONDITIONS PLAN SOUTHWEST EXISTING CONDITIONS PLAN SOUTHEAST EXISTING CONDITIONS PLAN NORTHEAST EXISTING CONDITIONS PLAN NORTHWEST GRADING PLAN SOUTHWEST GRADING PLAN SOUTHEAST C2.2 GRADING PLAN NORTHEAST GRADING PLAN NORTHWEST C2.3 UTILITY PLAN SOUTHWEST UTILITY PLAN SOUTHEAST UTILITY PLAN NORTHEAST UTILITY PLAN NORTHWEST DETAILS

COVER SHEET

TREE REMOVAL AND PROTECTION PLAN LANDSCAPE PLAN LANDSCAPE PLAN LANDSCAPE PLAN LANDSCAPE DETAILS AND PLANTING NOTES LANDSCAPE AND IR SPECS L3.0

ECL2.00 LIGHT FIXTURE CUT SHEETS BUILDING 1 FLOOR PLAN BUILDING 1 ROOF PLAN BUILDING 1 ELEVATIONS BUILDING 1 ELEVATIONS BUILDING 1 ELEVATIONS 1A3.4 BUILDING 1 ELEVATIONS

ECL1.00 SITE LIGHTING PHOTOMETRIC

LEGAL DESCRIPTION

AREA: SITE	AREA: 370,726 S.F. (8.51 AC)	% COVERAGE:
IMPERVIOUS AREA:	0, 0,, 20 0 (0.0. , 1.0)	
BUILDING 1 (FOOTPRINT): BUILDING 2 (FOOTPRINT):	104,254 SF 27,325 SF	28.12% 7.37%
PAVING AREA: TOTAL IMPERVIOUS AREA:	<u>179,754 SF</u> 311,360 SF	<u>48.49%</u> 83.98%
LANDSCAPE AREA: LANDSCAPING:	59,393 SF	16.02%
PARKING: STANDARD: ACCESSIBLE:	# SPACES PROVIDED: 195 7	# SPACES REQUIRED: WAREHOUSE/DIST .3/1000 SF = 40 7

202

TAX LOT 901, 2S 1 23B, WASHINGTON COUNTY, OREGON

ZONE: ALLOWABLE USE TYPE:

ZONE ANALYSIS

BUILDING 2 FLOOR PLAN

BUILDING 2 ROOF PLAN

BUILDING 2 ELEVATIONS

BUILDING 2 ELEVATIONS

SITE DETAILS

SITE DETAILS

2A2.2

2A3.1 2A3.2

A5.1

GENERAL COMMERCIAL MISC. INDUSTRIAL USES MANUFACTURING

LI — LIGHT INDUSTRIAL

OFFICE/WAREHOUSE

Tualatin, OR 97062

Sheet Title:

Cover Sheet

Revisions:

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Drawn by: TQL

VICINITY MAP


N.T.S.


TOTAL SPACES PROVIDED:

SITE DATA

Regal Bridgeport Vi ScreenX & IM Cook Park Bridgeport Village Tualatin Country Club (99W) Durk **191 Tuellatin Rd** SW TUALATIN RD Veris Industries Cabela's (41) Tualatin SW Sagert St. Vicinity Plan -Building Site

KEY PLAN

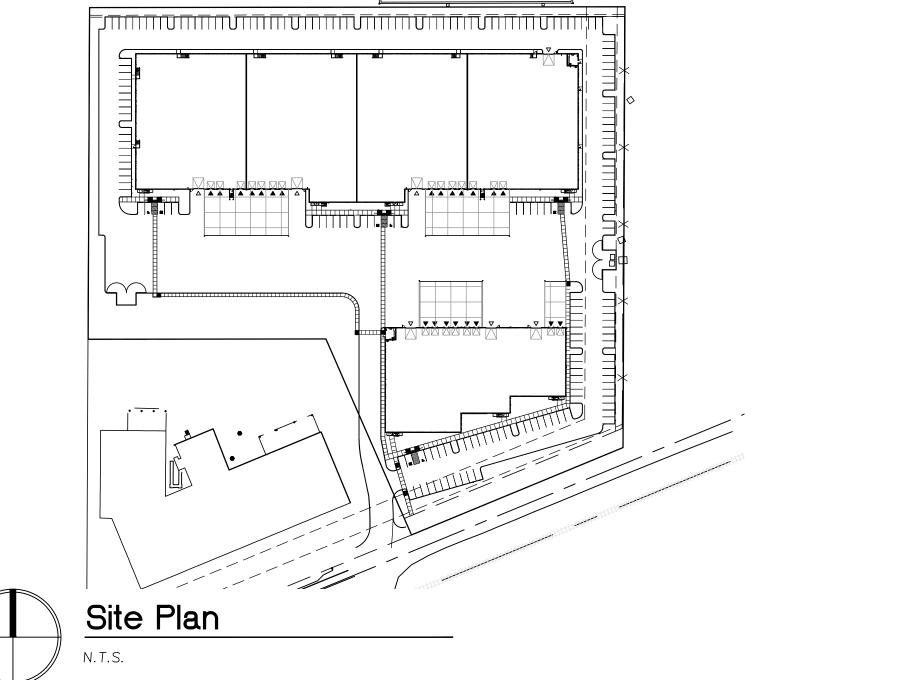

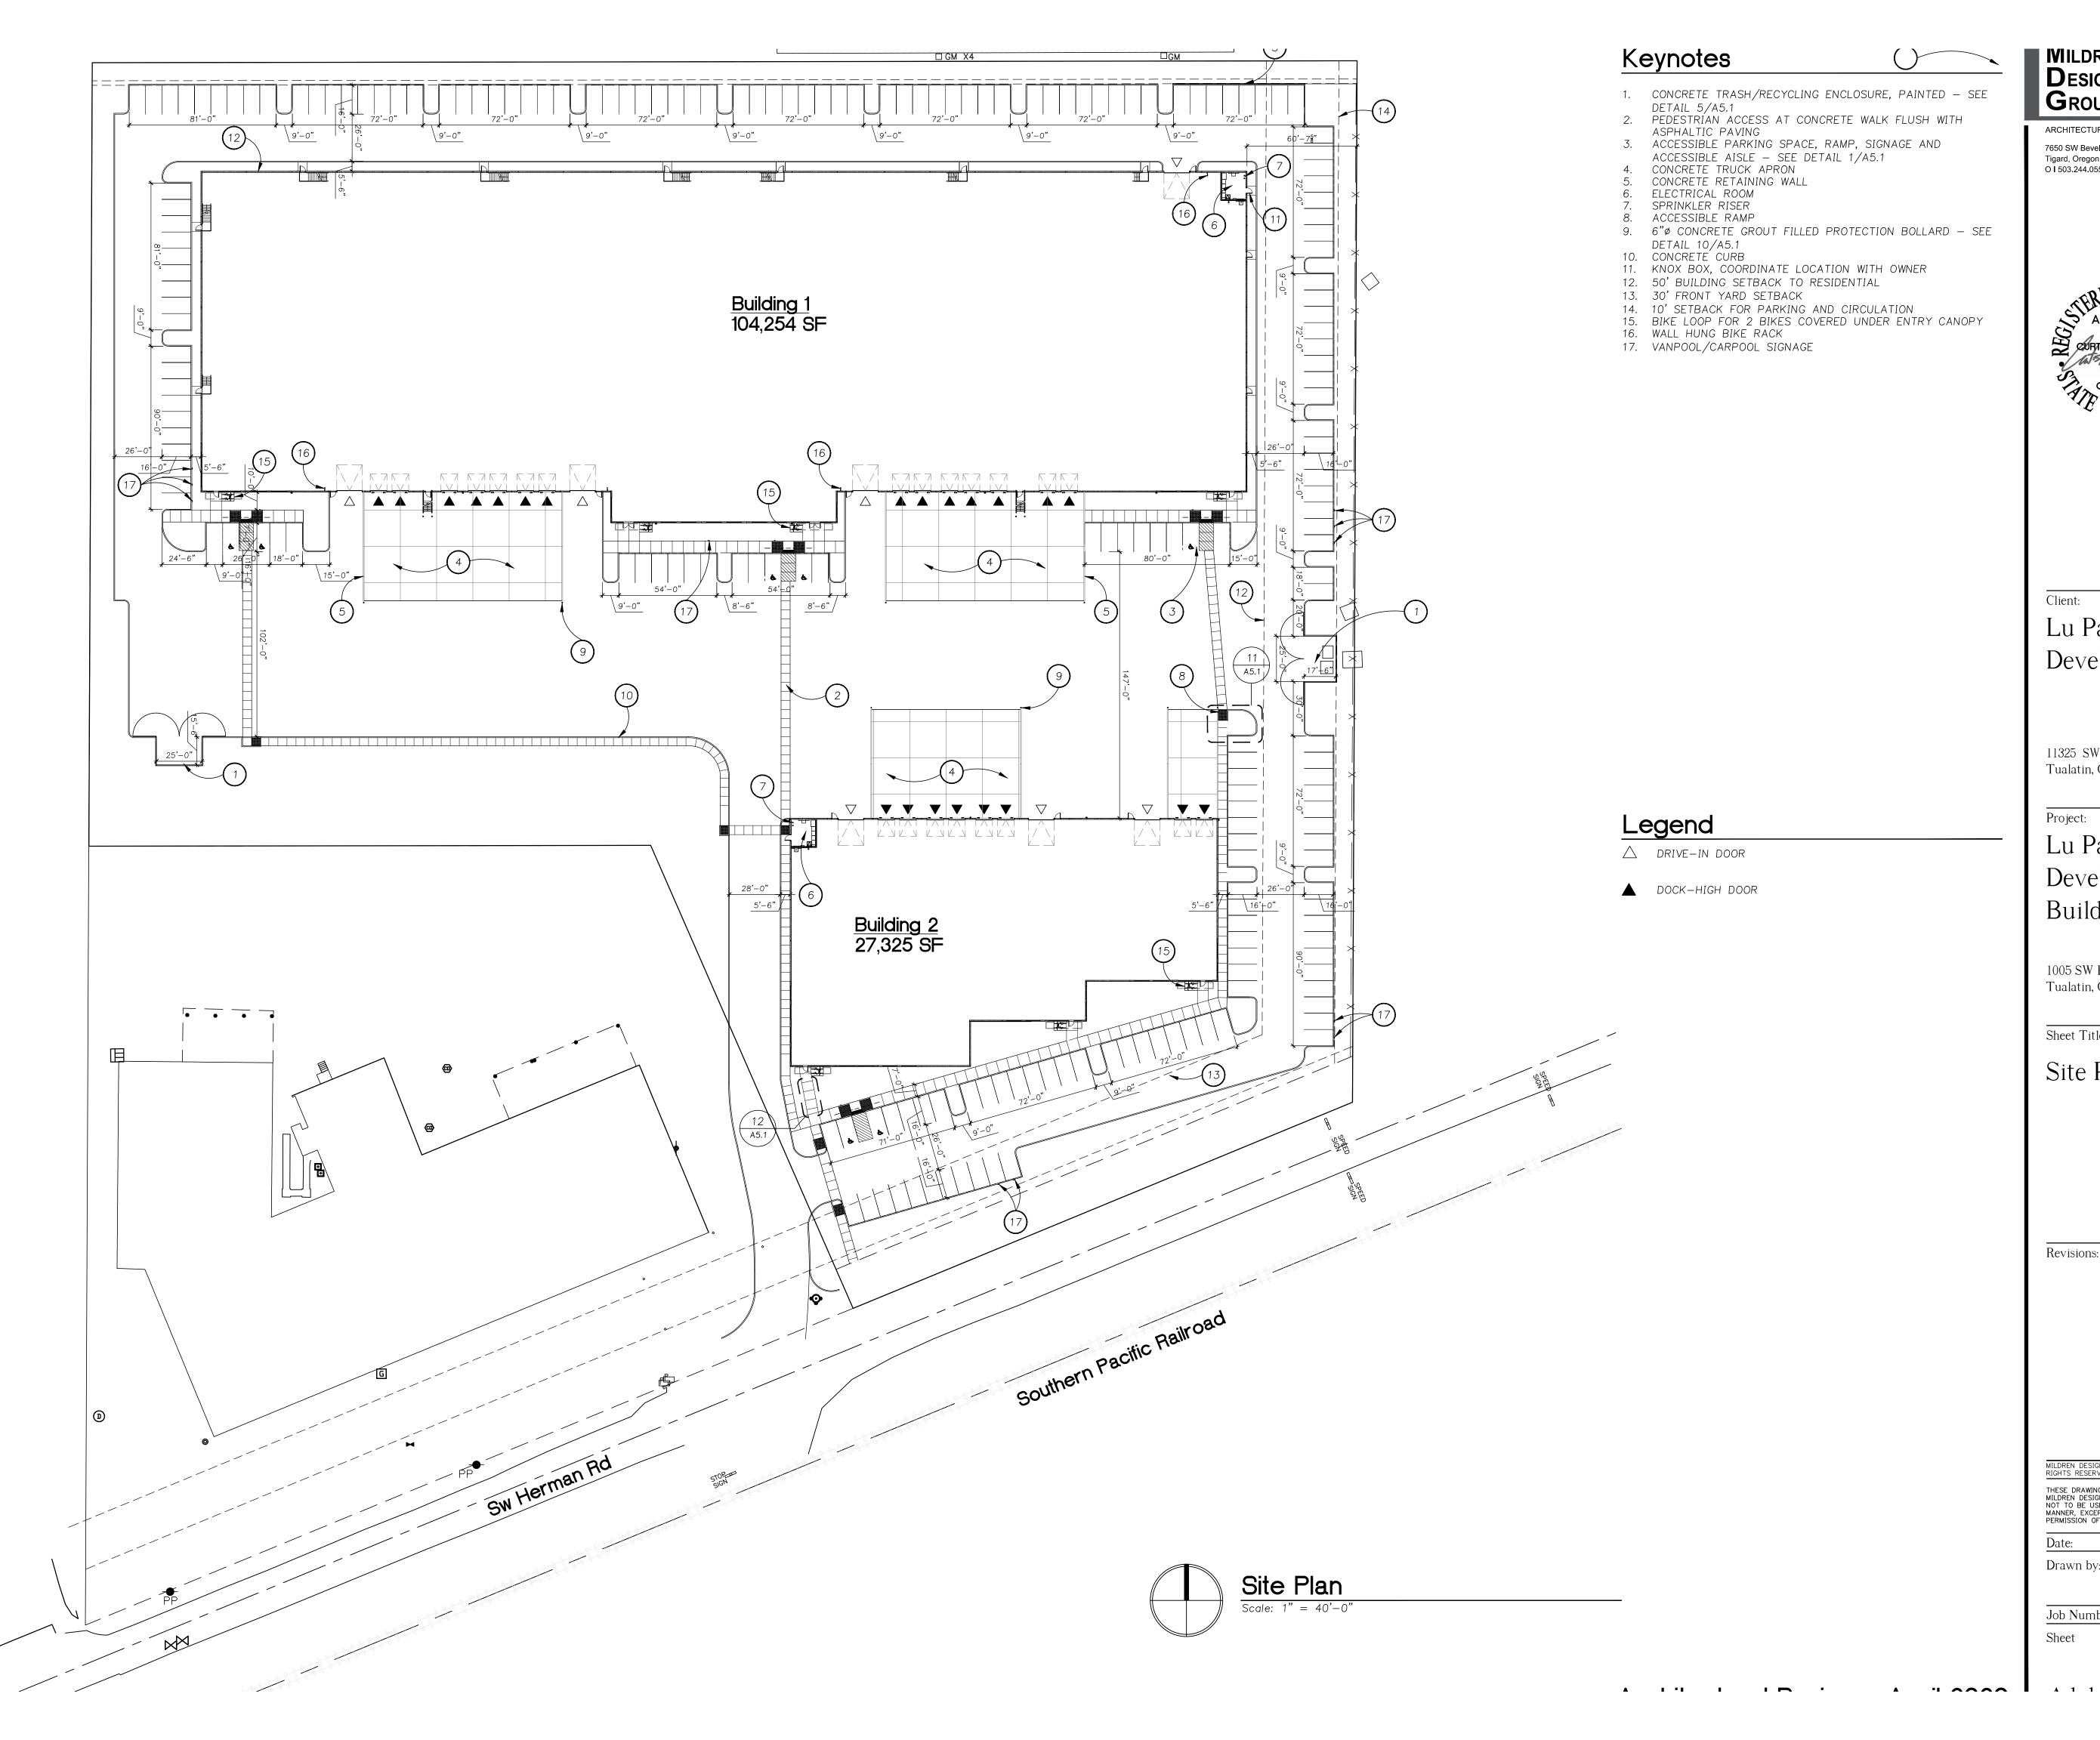

| **IVI**ILDREN **D**ESIGN GROUP

ARCHITECTURE | INTERIORS

7650 SW Beveland Street, Suite 120 Tigard, Oregon 97223 - 8692 O I 503.244.0552



Lu Pacific Development

11325 SW Tualatin-Sherwood Rd Tualatin, OR 97062

Project:

Lu Pacific Development Building

1005 SW Herman Road Tualatin, OR 97062

Sheet Title:

Site Plan

Revisions:

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Checked by: TQL

117013

Job Number:

Sheet

GENERAL GRADING NOTES (GGN)

- 1. ALL WORK SHALL CONFORM TO THE REQUIREMENTS OF THE JURISDICTION AND THE PROJECT GEOTECHNICAL INVESTIGATION.
- 2. THE CONTRACTOR SHALL HAVE A FULL SET OF THE CURRENT APPROVED CONSTRUCTION DOCUMENTS, INCLUDING ADDENDA ON THE PROJECT SITE AT ALL TIMES.
- 3. THE CONTRACTOR SHALL NOTIFY THE OREGON UTILITY NOTIFICATION CENTER (800 332 2344) THREE BUSINESS DAYS PRIOR TO ANY EXCAVATION.
- 4. THE CONTRACTOR IS RESPONSIBLE FOR COORDINATION OF PRIVATE UTILITIES SUCH AS GAS, TELEPHONE, POWER, DATA, ETC. CONFIRM VAULT LOCATIONS WITH THE ARCHITECT.
- 5. THE CONTRACTOR SHALL KEEP THE ARCHITECT AND JURISDICTION INFORMED OF CONSTRUCTION PROGRESS TO FACILITATE SITE OBSERVATIONS AT REQUIRED INTERVALS. 48—HOUR NOTICE IS REQUIRED.
- 6. EXISTING CONDITIONS BASED ON TOPOGRAPHIC, BOUNDARY, AND UTILITY SURVEY PREPARED BY WEDDLE AND ASSOCIATES, JULY 2019.
- 7. FINISHED GRADES ARE TO BE BROUGHT TO WITHIN 0.08 FT. IN 10 FT. OF THE GRADES SHOWN AT SUBGRADE AND TO WITHIN 0.03 FT. IN 10 FT. AT FINISH GRADE. CONTRACTOR TO ALLOW FOR PLACEMENT OF REQUIRED TOPSOIL AND PLANTINGS IN ROUGH GRADING.

 8. CRADING ELEVATIONS AS SHOWN ON PLANS ARE FINISHED CRADE. WHICH INCLUDES BAYING.
- 8. GRADING ELEVATIONS AS SHOWN ON PLANS ARE FINISHED GRADE, WHICH INCLUDES PAVING, BASE ROCK, AND SUBGRADE SOIL. GENERAL CONTRACTOR IS RESPONSIBLE TO COORDINATE GRADING WITH BOTH EXCAVATOR AND PAVING CONTRACTOR.
- 9. SEE PROJECT GEOTECHNICAL ANALYSIS FOR PAVING AND BASE ROCK THICKNESS AND FOR EXCAVATION, FILL, AND COMPACTION REQUIREMENTS.
- 10. IF DEWATERING IS REQUIRED DURING CONSTRUCTION, THE CONTRACTOR SHALL PREPARE A DEWATERING PLAN CONSISTENT WITH CITY OF TUALATIN AND CLEAN WATER SERVICES (CWS) REQUIREMENTS, AND OBTAIN APPROVAL OF THE PLAN FROM BOTH JURISDICTIONS PRIOR TO PROCEEDING WITH DEWATERING.
- 11. THE CONTRACTOR SHALL CLEAN ALL CATCH BASINS AND STORM LINES IMPACTED BY SITE DEVELOPMENT FOLLOWING COMPLETION OF CONSTRUCTION OR AS DIRECTED BY THE CITY OF TIGARD AND CWS. NO SEDIMENT SHALL BE ALLOWED TO ENTER NEW OR EXISTING INLETS.

GENERAL UTILITY NOTES (GUN)

- 1. ALL WORK SHALL CONFORM TO THE REQUIREMENTS OF THE JURISDICTION.
- 2. ALL WORK SHALL CONFORM TO THE REQUIREMENTS OF THE CURRENT EDITION OF THE PLUMBING CODE, BUILDING CODE, AND THE FIRE CODE.
- 3. THE CONTRACTOR SHALL HAVE A FULL SET OF THE CURRENT APPROVED CONSTRUCTION DOCUMENTS INCLUDING ADDENDA ON THE PROJECT SITE AT ALL TIMES.
- 4. THE CONTRACTOR SHALL NOTIFY THE OREGON UTILITY NOTIFICATION CENTER (800 332 2344) THREE BUSINESS DAYS PRIOR TO ANY EXCAVATION.
- 5. EXISTING CONDITIONS BASED ON TOPOGRAPHIC, BOUNDARY, AND UTILITY SURVEY PREPARED BY WEDDLE AND ASSOCIATES, JULY 2019.
- WEDDLE AND ASSOCIATES, JULY 2019.

 6. THE CONTRACTOR IS RESPONSIBLE FOR COORDINATION OF PRIVATE UTILITIES SUCH AS GAS.
- TELEPHONE, POWER, CABLE TELEVISION, ETC. CONFIRM VAULT LOCATIONS WITH ARCHITECT.

 7. THE CONTRACTOR SHALL KEEP THE ARCHITECT AND JURISDICTION INFORMED OF CONSTRUCTION
- 7. THE CONTRACTOR SHALL KEEP THE ARCHITECT AND JURISDICTION INFORMED OF CONSTRUCTION PROGRESS TO FACILITATE SITE OBSERVATIONS AT REQUIRED INTERVALS. 48—HOUR NOTICE IS REQUIRED.
- 8. THE CONTRACTOR SHALL VERIFY AND CONFIRM EXISTING CONDITIONS. EXISTING UTILITIES AND POINTS OF CONNECTION TO EXISTING UTILITIES AND LOCATIONS WHERE NEW UTILITIES WILL CROSS EXISTING UTILITIES SHALL BE VERIFIED BY THE CONTRACTOR BY POTHOLING PRIOR TO CONSTRUCTION OR ORDERING MATERIALS. IT IS THE CONTRACTOR'S RESPONSIBILITY TO SCHEDULE POTHOLING SUCH THAT IF CONFLICTS ARE ENCOUNTERED, SUFFICIENT TIME EXISTS TO PREPARE MODIFIED DESIGNS AND HAVE THE MODIFICATIONS APPROVED BY THE JURISDICTION WITHOUT IMPACTING THE PROJECT SCHEDULE.
- THIS PLAN IS GENERALLY DIAGRAMMATIC. IT DOES NOT SHOW EVERY JOINT, BEND, FITTING, OR ACCESSORY REQUIRED FOR CONSTRUCTION.
- 10. INSTALL CLEANOUTS AT 100' MAX. AND AT ALL LATERALS PER CODE. PROVIDE CLEANOUTS AS REQUIRED BY THE CURRENT OREGON PLUMBING SPECIALTY CODE. NOT ALL REQUIRED CLEANOUTS ARE SHOWN.
- 11. UTILITIES WITHIN TWO FEET OF A BUILDING SHALL BE CONSTRUCTED OF MATERIALS APPROVED FOR INTERIOR USE AS DESCRIBED IN THE CURRENT EDITION OF THE PLUMBING CODE.
- 12. CHANGES IN DIRECTION OF DRAINAGE AND SEWER PIPING SHALL BE MADE BY THE APPROPRIATE USE OF APPROVED FITTINGS AND SHALL BE OF THE ANGLES PRESENTED BY ONE—SIXTEENTH BEND, ONE—EIGHTH BEND, ONE—SIXTH BEND OR OTHER APPROVED FITTINGS OF EQUIVALENT SWEEP.
- 13. IF DEWATERING IS REQUIRED DURING CONSTRUCTION, THE CONTRACTOR SHALL PREPARE A DEWATERING PLAN CONSISTENT WITH CITY OF TUALATIN AND CLEAN WATER SERVICES (CWS) REQUIREMENTS, AND OBTAIN APPROVAL OF THE PLAN FROM BOTH JURISDICTIONS PRIOR TO PROCEEDING WITH DEWATERING.
- 14. THE CONTRACTOR SHALL CLEAN ALL CATCH BASINS AND STORM LINES IMPACTED BY SITE DEVELOPMENT FOLLOWING COMPLETION OF CONSTRUCTION OR AS DIRECTED BY THE CITY OF TUALATIN AND CWS. NO SEDIMENT SHALL BE ALLOWED TO ENTER THE STORM SYSTEM.
- 15. COORDINATE WITH CITY OF TUALATIN FOR PROVISION OF NEW FIRE TAP AND SERVICE AND NEW DOMESTIC WATER SERVICE AND METERS AT SW HERMAN ROAD FRONTAGE. CONTRACTOR TO INSTALL 2—INCH SERVICE PIPE FROM METER TO EACH BUILDING RISER ROOM AND INSTALL CITY OF TUALATIN APPROVED DOMESTIC BACKFLOW PREVENTERS IN VAULTS ADJACENT TO THE METERS. SIZE OF DOMESTIC SERVICE, CAPACITY OF METER, BUILDING DOMESTIC WATER DEMAND AND SIZE OF PIPING TO BUILDING IS ASSUMED AND TO BE CONFIRMED BY BUILDING PLUMBING DESIGNER PRIOR TO CONSTRUCTION OR ORDERING MATERIAL. CONTRACTOR TO DETERMINE REQUIRED BACKFLOW PREVENTER TYPE PRIOR TO CONSTRUCTION OR ORDERING MATERIALS; COORDINATE WITH BUILDING PLUMBING DESIGNER. CONTRACTOR TO DETERMINE IF REMOTE METER READER IS REQUIRED AND PROVIDE AS DIRECTED BY CITY OF TUALATIN. IRRIGATION CONNECTION IS TO BE DOWNSTREAM OF BUILDING WATER METERS AND TO BE OF CITY OF TUALATIN APPROVED TYPE. SEE LANDSCAPE PLANS FOR DISCUSSION OF IRRIGATION BACKFLOW PREVENTER AND CONTINUATION TO IRRIGATION SYSTEM. NO CONNECTIONS MAY OCCUR BETWEEN DOMESTIC METER AND BACKFLOW PREVENTERS INSIDE BUILDING.
- 16. FIRE DCDA TO SERVE BOTH NEW BUILDINGS WILL BE AT RIGHT OF WAY WITH SIZE TO BE CONFIRMED BY CONTRACTOR IN CONSULTATION WITH BUILDING FIRE SYSTEM DESIGNER. FIRE LINE PIPE SIZE IS ASSUMED AND TO BE CONFIRMED BY BUILDING FIRE SYSTEM DESIGNER BASED ON THEIR FLOW TESTING. ALL SITE FIRE PIPING AND HYDRANT PIPING TO BE FULLY MECHANICALLY RESTRAINED WITH PRODUCTS APPROVED BY THE CITY OF TUALATIN.
- 17. INSTALL AUTOMATIC DRAIN VALVE IN VAULT AT LOW POINT OF EACH FDC LINE. PROVIDE DRAINAGE FROM VAULTS TO CITY OF TUALATIN APPROVED LOCATIONS. SIZE OF FDC PIPES IS ASSUMED AND TO BE CONFIRMED BY BUILDING FIRE SYSTEM DESIGNER. FDC TO CONFORM TO REQUIREMENTS OF TUALATIN VALLEY FIRE AND RESCUE (TVF&R).
- 18. WATER LINE, FITTINGS, VALVES, HYDRANTS, AND COMPONENTS TO CONFORM TO THE REQUIREMENTS OF CITY OF TUALATIN AND BE FULLY MECHANICALLY RESTRAINED. HYDRANTS TO ALSO CONFORM TO REQUIREMENTS OF TVF&R. CONNECTIONS TO EXISTING ON SITE WATER MAIN TO CONFORM TO CITY OF TUALATIN REQUIREMENTS.
- 19. BUILDING SANITARY PIPE SIZE IS ASSUMED AND TO BE CONFIRMED BY BUILDING PLUMBING DESIGNER BASED ON THEIR CALCULATION OF DESIGN FIXTURE DISCHARGE. SEE BUILDING PLUMBING PLANS FOR SANITARY CONTINUATION WITHIN BUILDING.
- 20. CORE EXISTING PUBLIC SANITARY MANHOLE FOR NORTH BUILDING SERVICE CONNECTION. MODIFY CHANNEL AND RELOCATE STEPS AS REQUIRED. REMOVE LID AND ROTATE AS REQUIRED TO MATCH INTERNAL STEPS. SEPARATE PUBLIC WORKS PERMIT REQUIRED FOR CONNECTION TO AND WORK ON THIS MANHOLE.

LEGEND

	PROPOSED	EXISTING
PROJECT BOUNDARY		
PROPERTY LINE		
EASEMENT LINE		
FENCE		— x — x
CURB		
EDGE OF PAVEMENT		
1' CONTOUR	121	121
5' CONTOUR	<u>120</u>	<u> </u>
STORM SEWER LINE	SD	STM
WATER LINE	w	WAT
FIRE DEPT. CONNECTION LINE	——— FDC ———	
FIRE WATER LINE	FW	
DOMESTIC WATER LINE	DW	
SANITARY SEWER LINE	SS	SAN
GAS LINE		——— GAS ——
OVERHEAD UTILITY WIRE		——————————————————————————————————————
UNDERGROUND POWER LINE		
COMMUNICATION LINE		COM
EXISTING FEATURE OR CONDITION		(E)
CATCH BASIN	СВ	(L)
TOP OF CURB	TC	
GUTTER	G	
TOP OF STEP	TS	
BOTTOM OF STEP	BS	
TOP OF WALL	TW	
BOTTOM OF WALL AT FINISHED GRADE	BW	
	FG	
FINISHED GRADE		
FOOTING PERFORATED PIPE	FTG PERF	
DUCTILE IRON		
	D.I.	
BACKFLOW PREVENTER	BFP	
ВОТТОМ	ВОТ	
CITY OF TUALATIN	СОТ	
CLEAN WATER SERVICES	CWS	
GENERAL GRADING NOTES	GGN	
GENERAL UTILITY NOTES	GUN	~59 Mz
		E/1 /2
DECIDUOUS TREE		233

CONIFEROUS TREE



ARCHITECTURE | INTERIORS

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O I 503.244.0552



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71:---

Lu Pacific
Development

11325 SW Tualatin-Sherwood Rd Tualatin, OR 97062

Project:

Lu Pacific
Developmer
Building

1005 SW Herman Road Tualatin, OR 97062

Sheet Title:

General Notes & Legend

Revisions:

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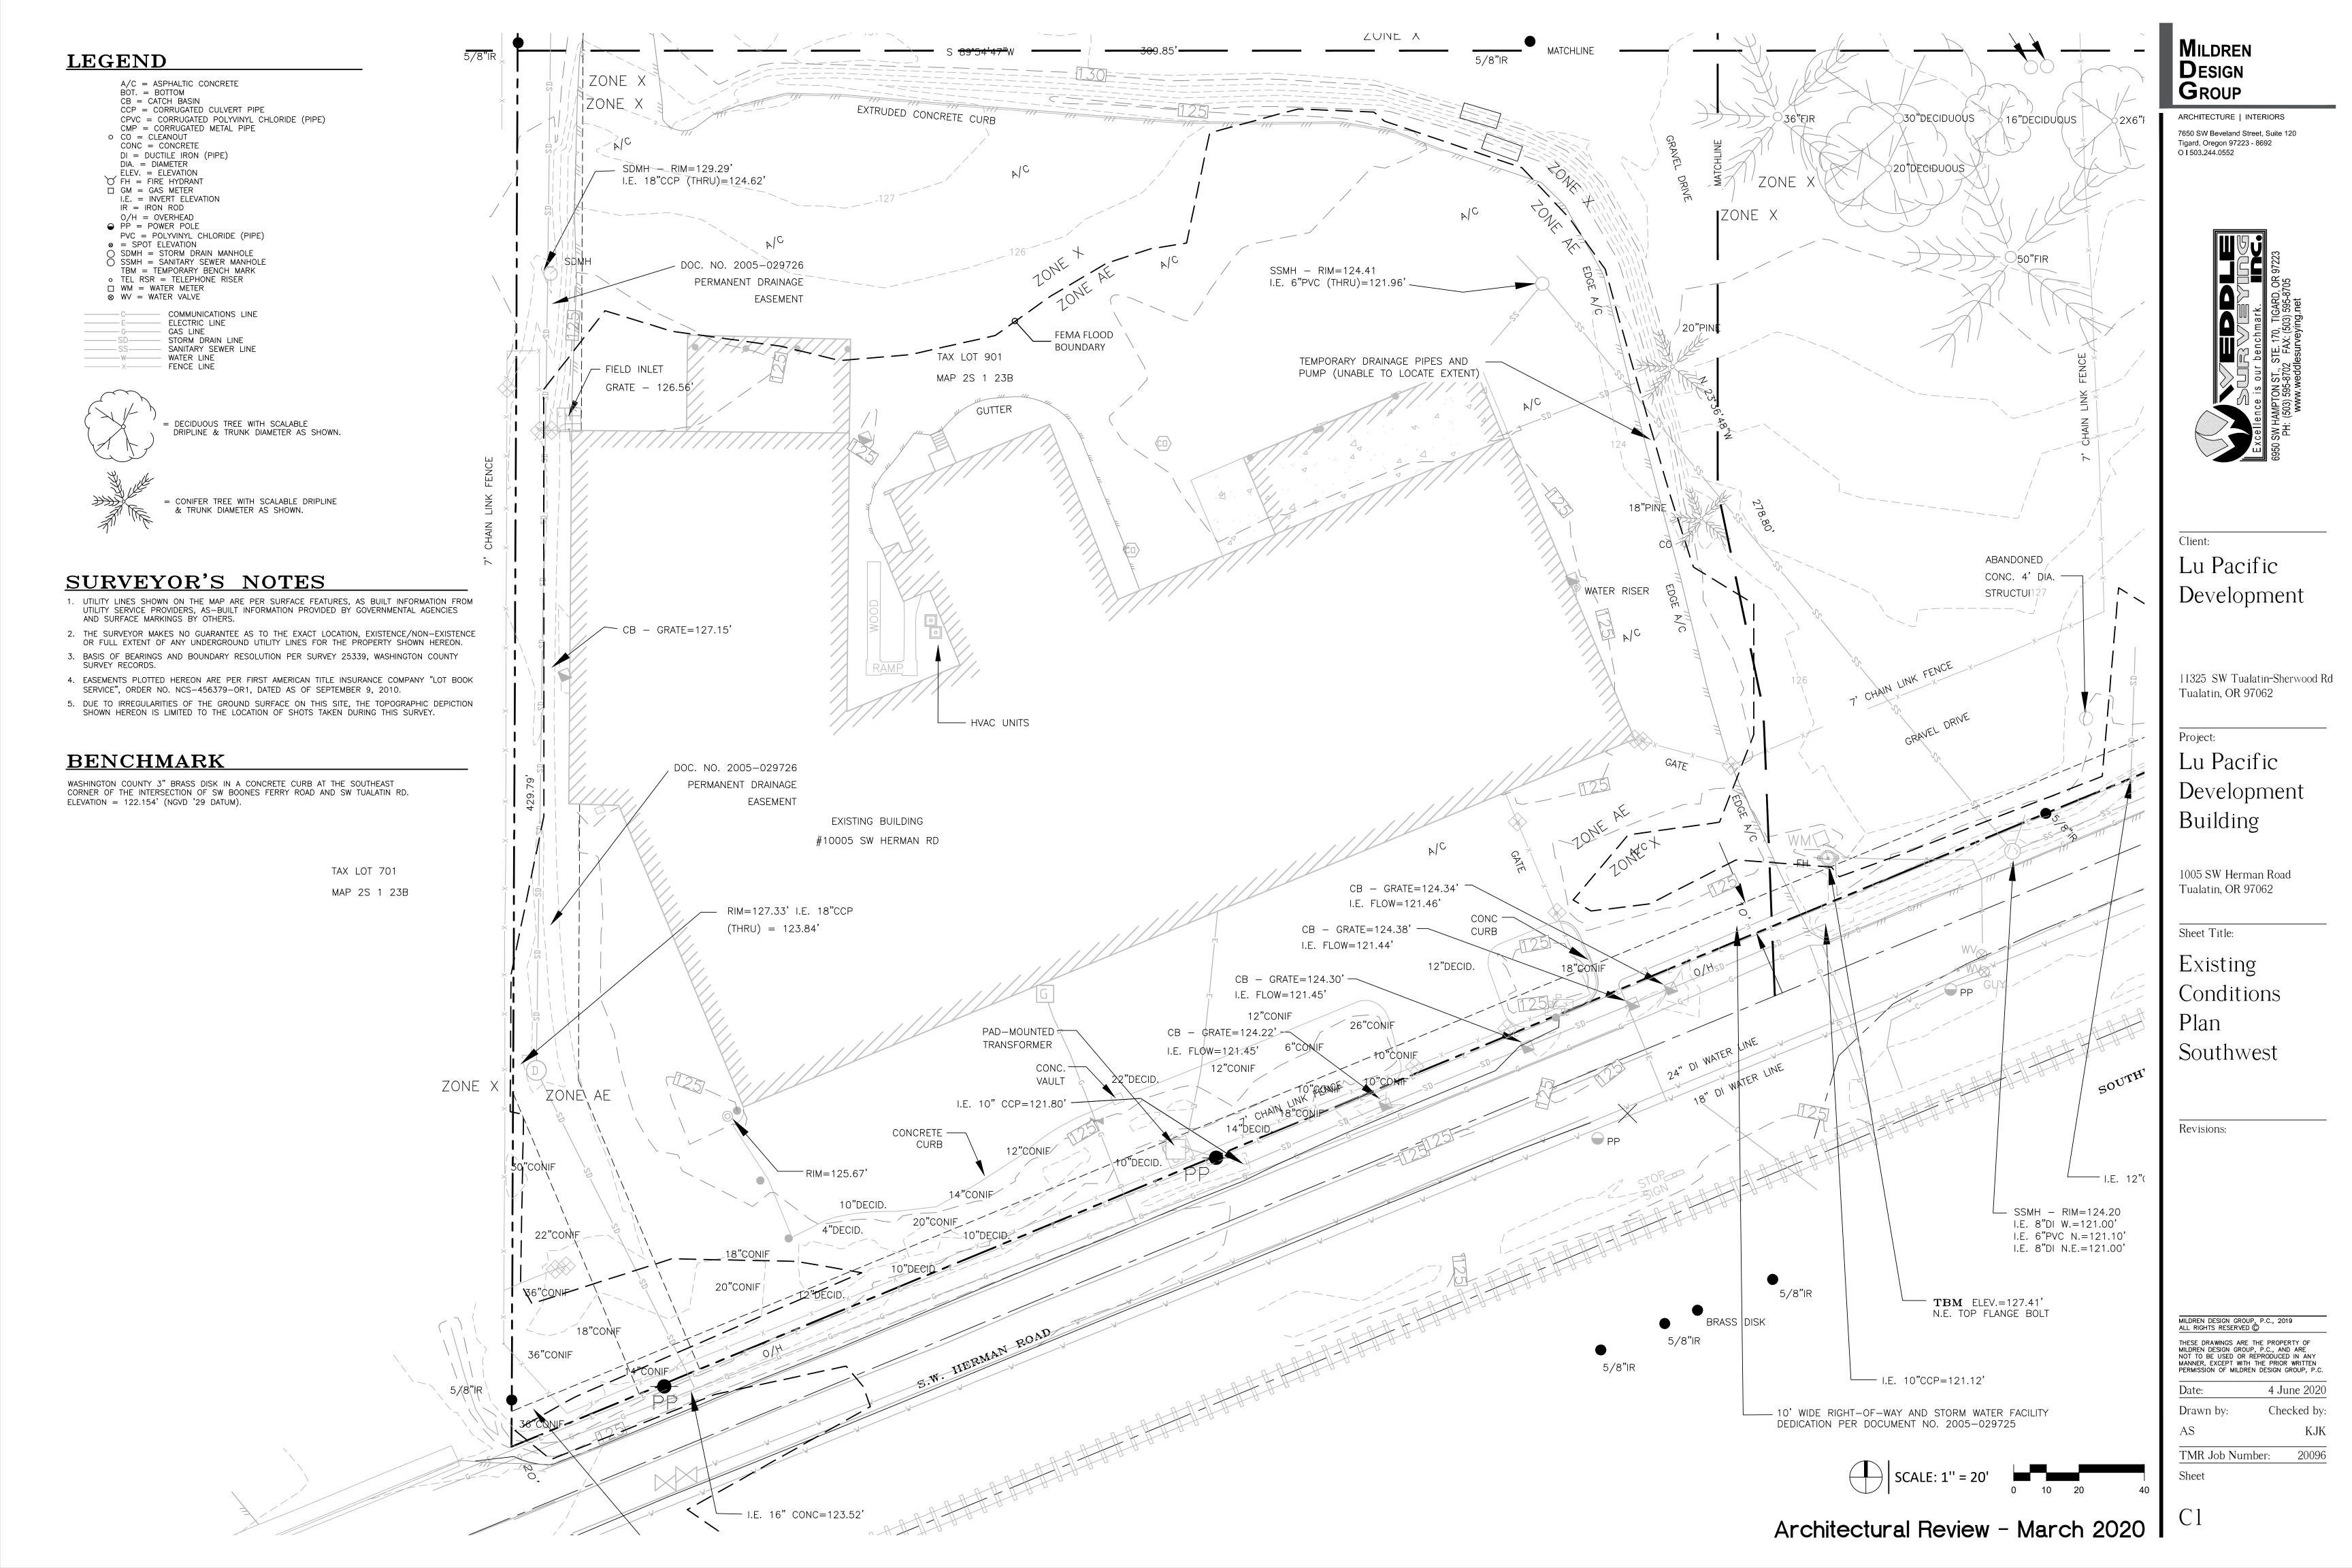
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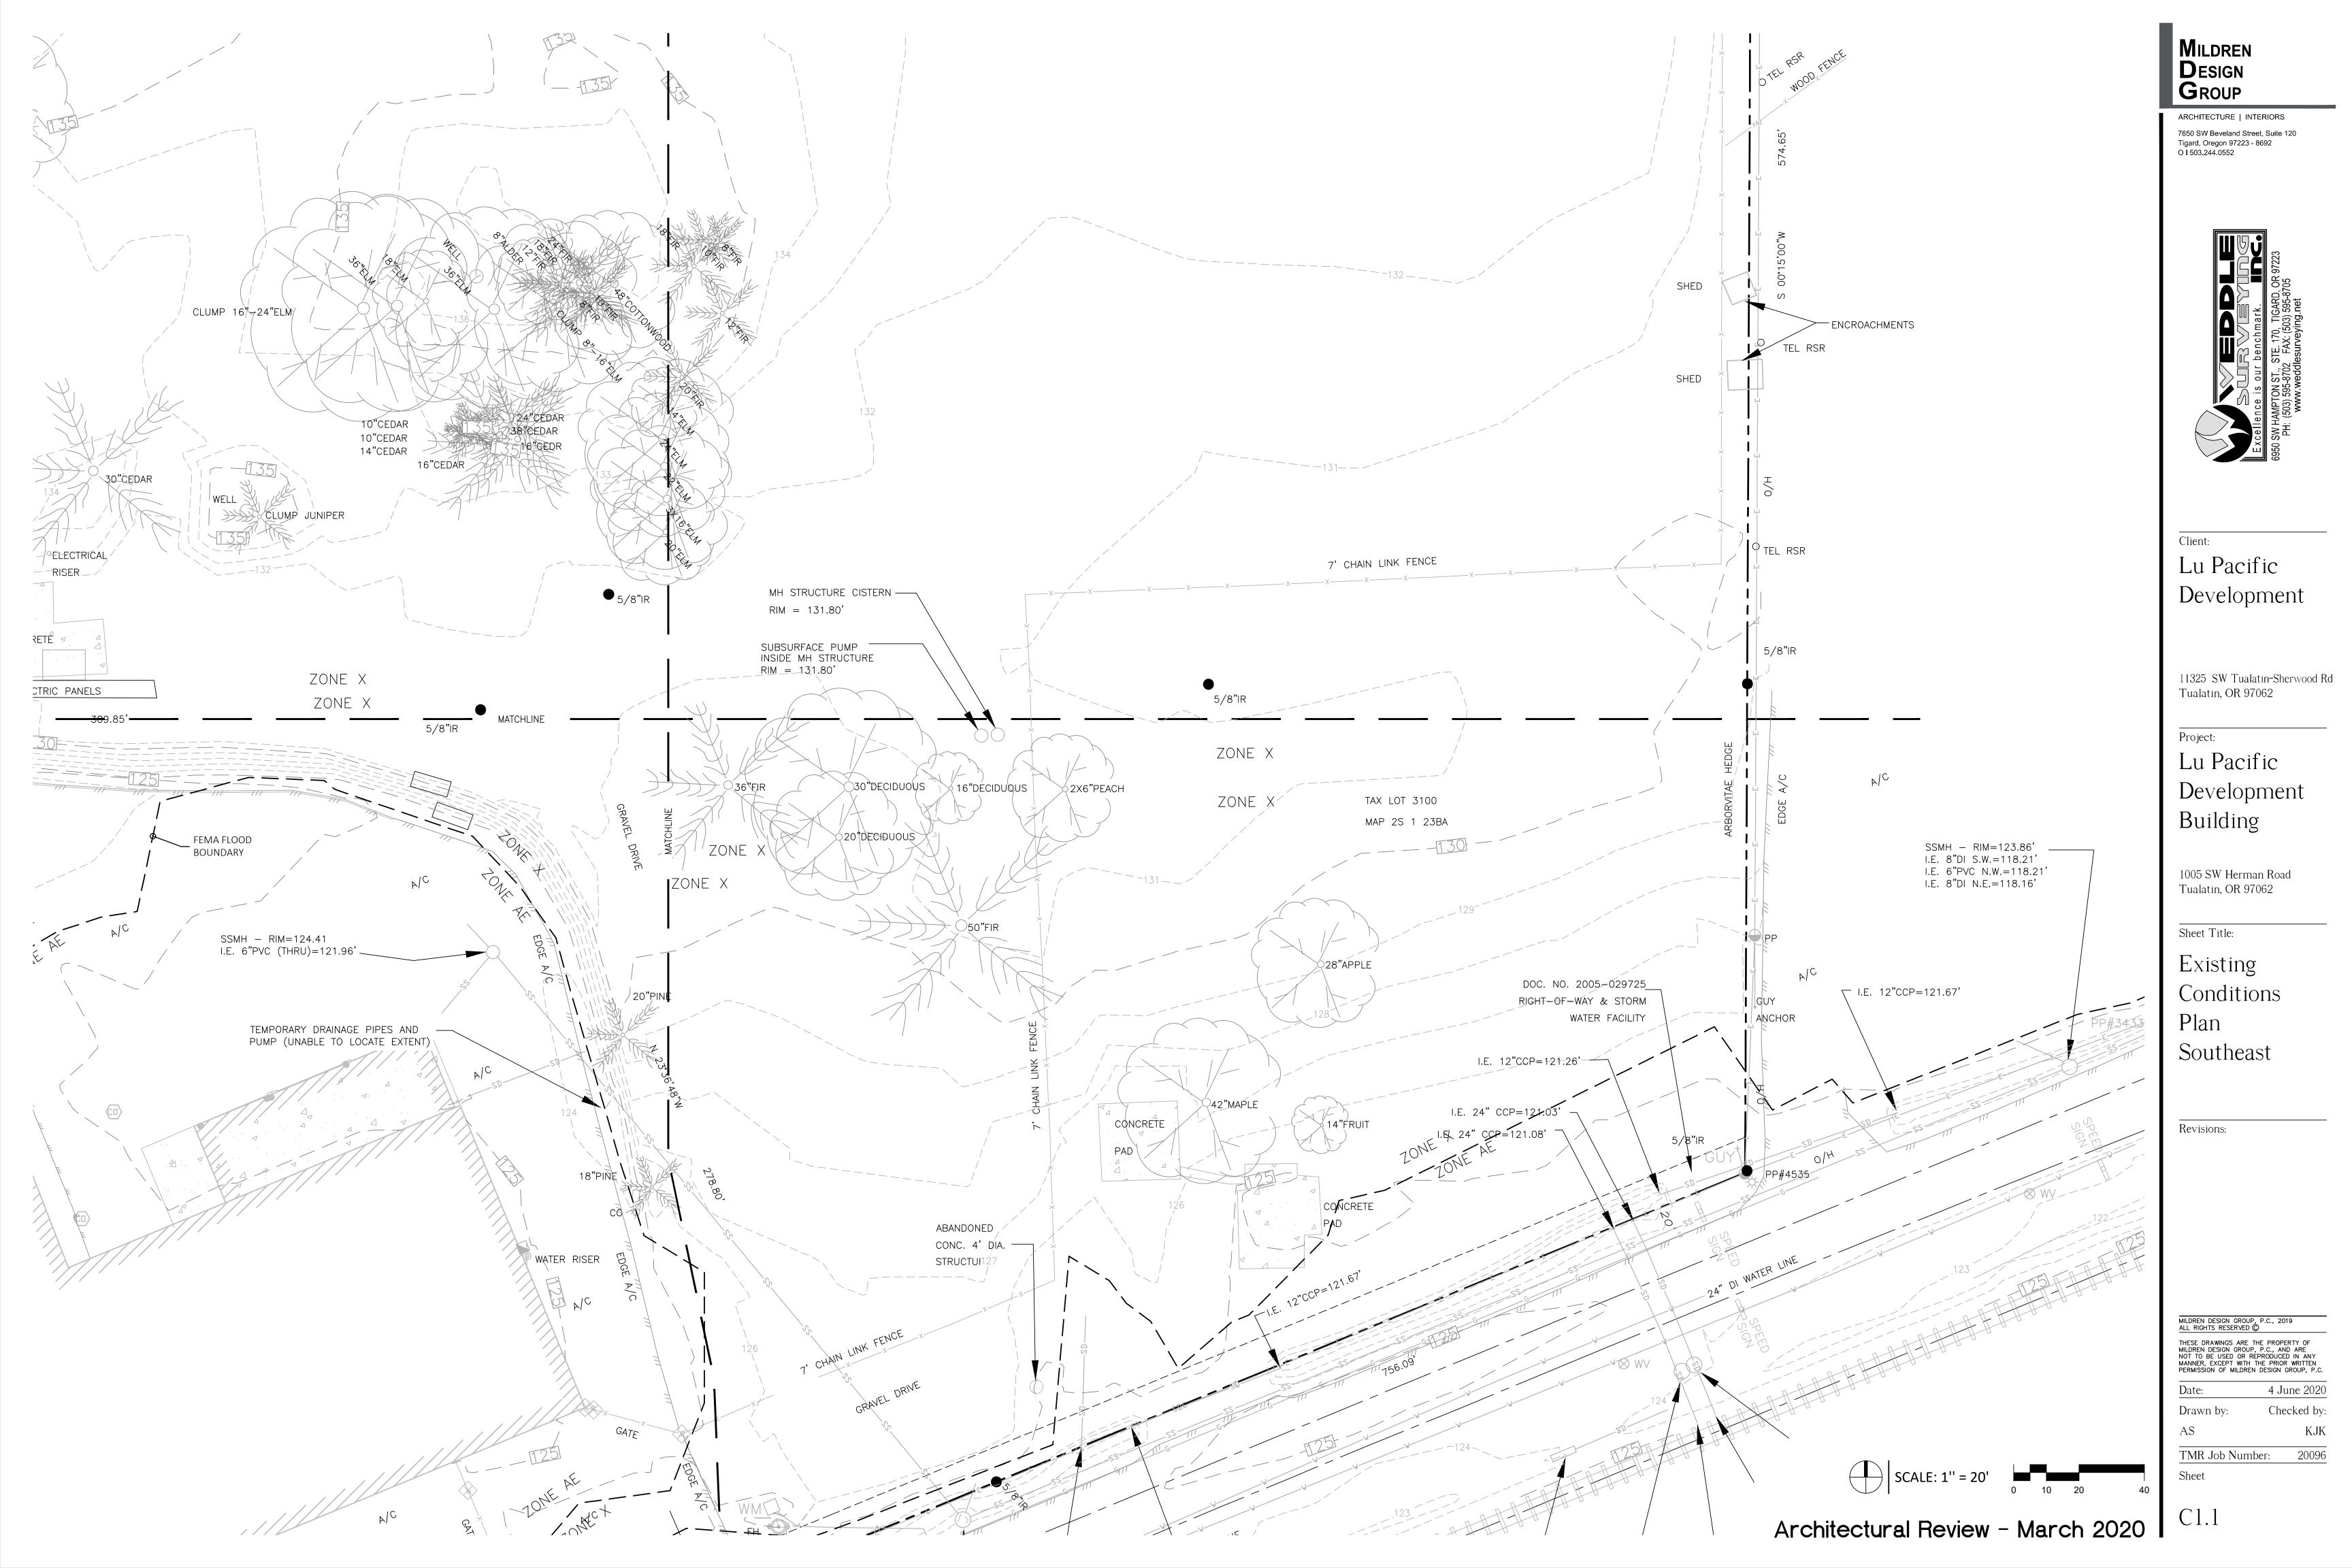
Drawn by: Checked by:
AS KJK


TMR Job Number: 20096


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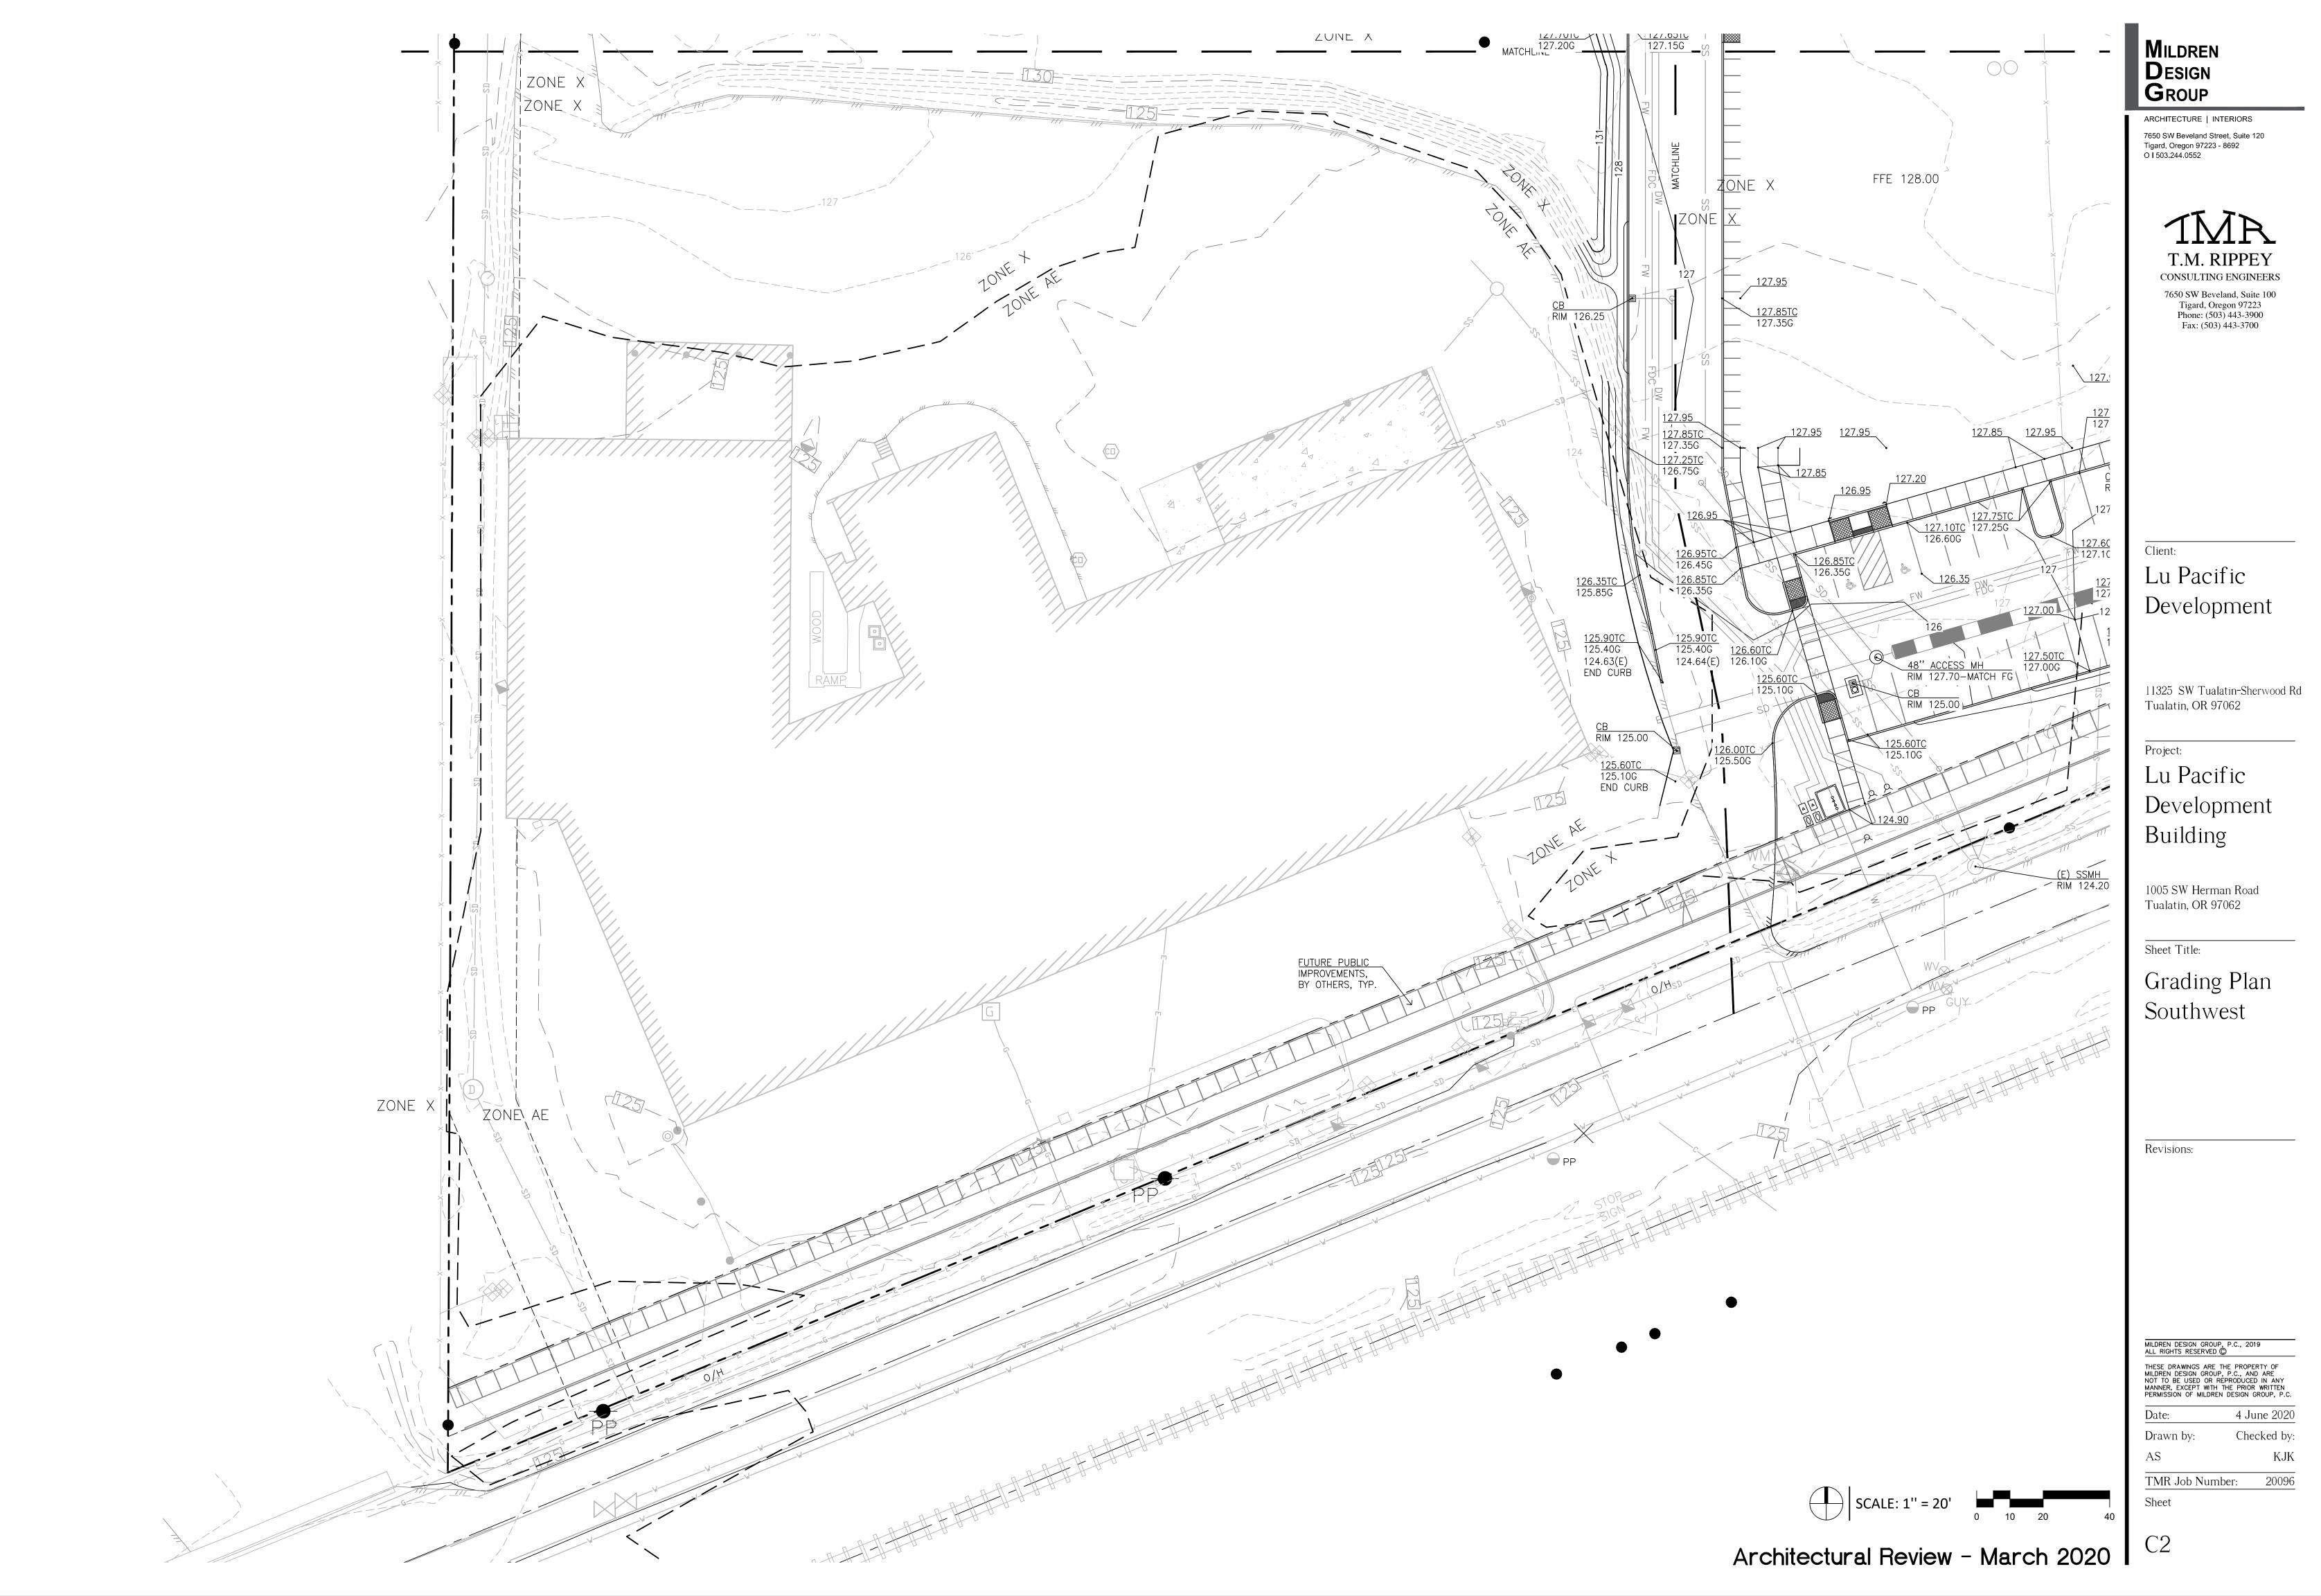
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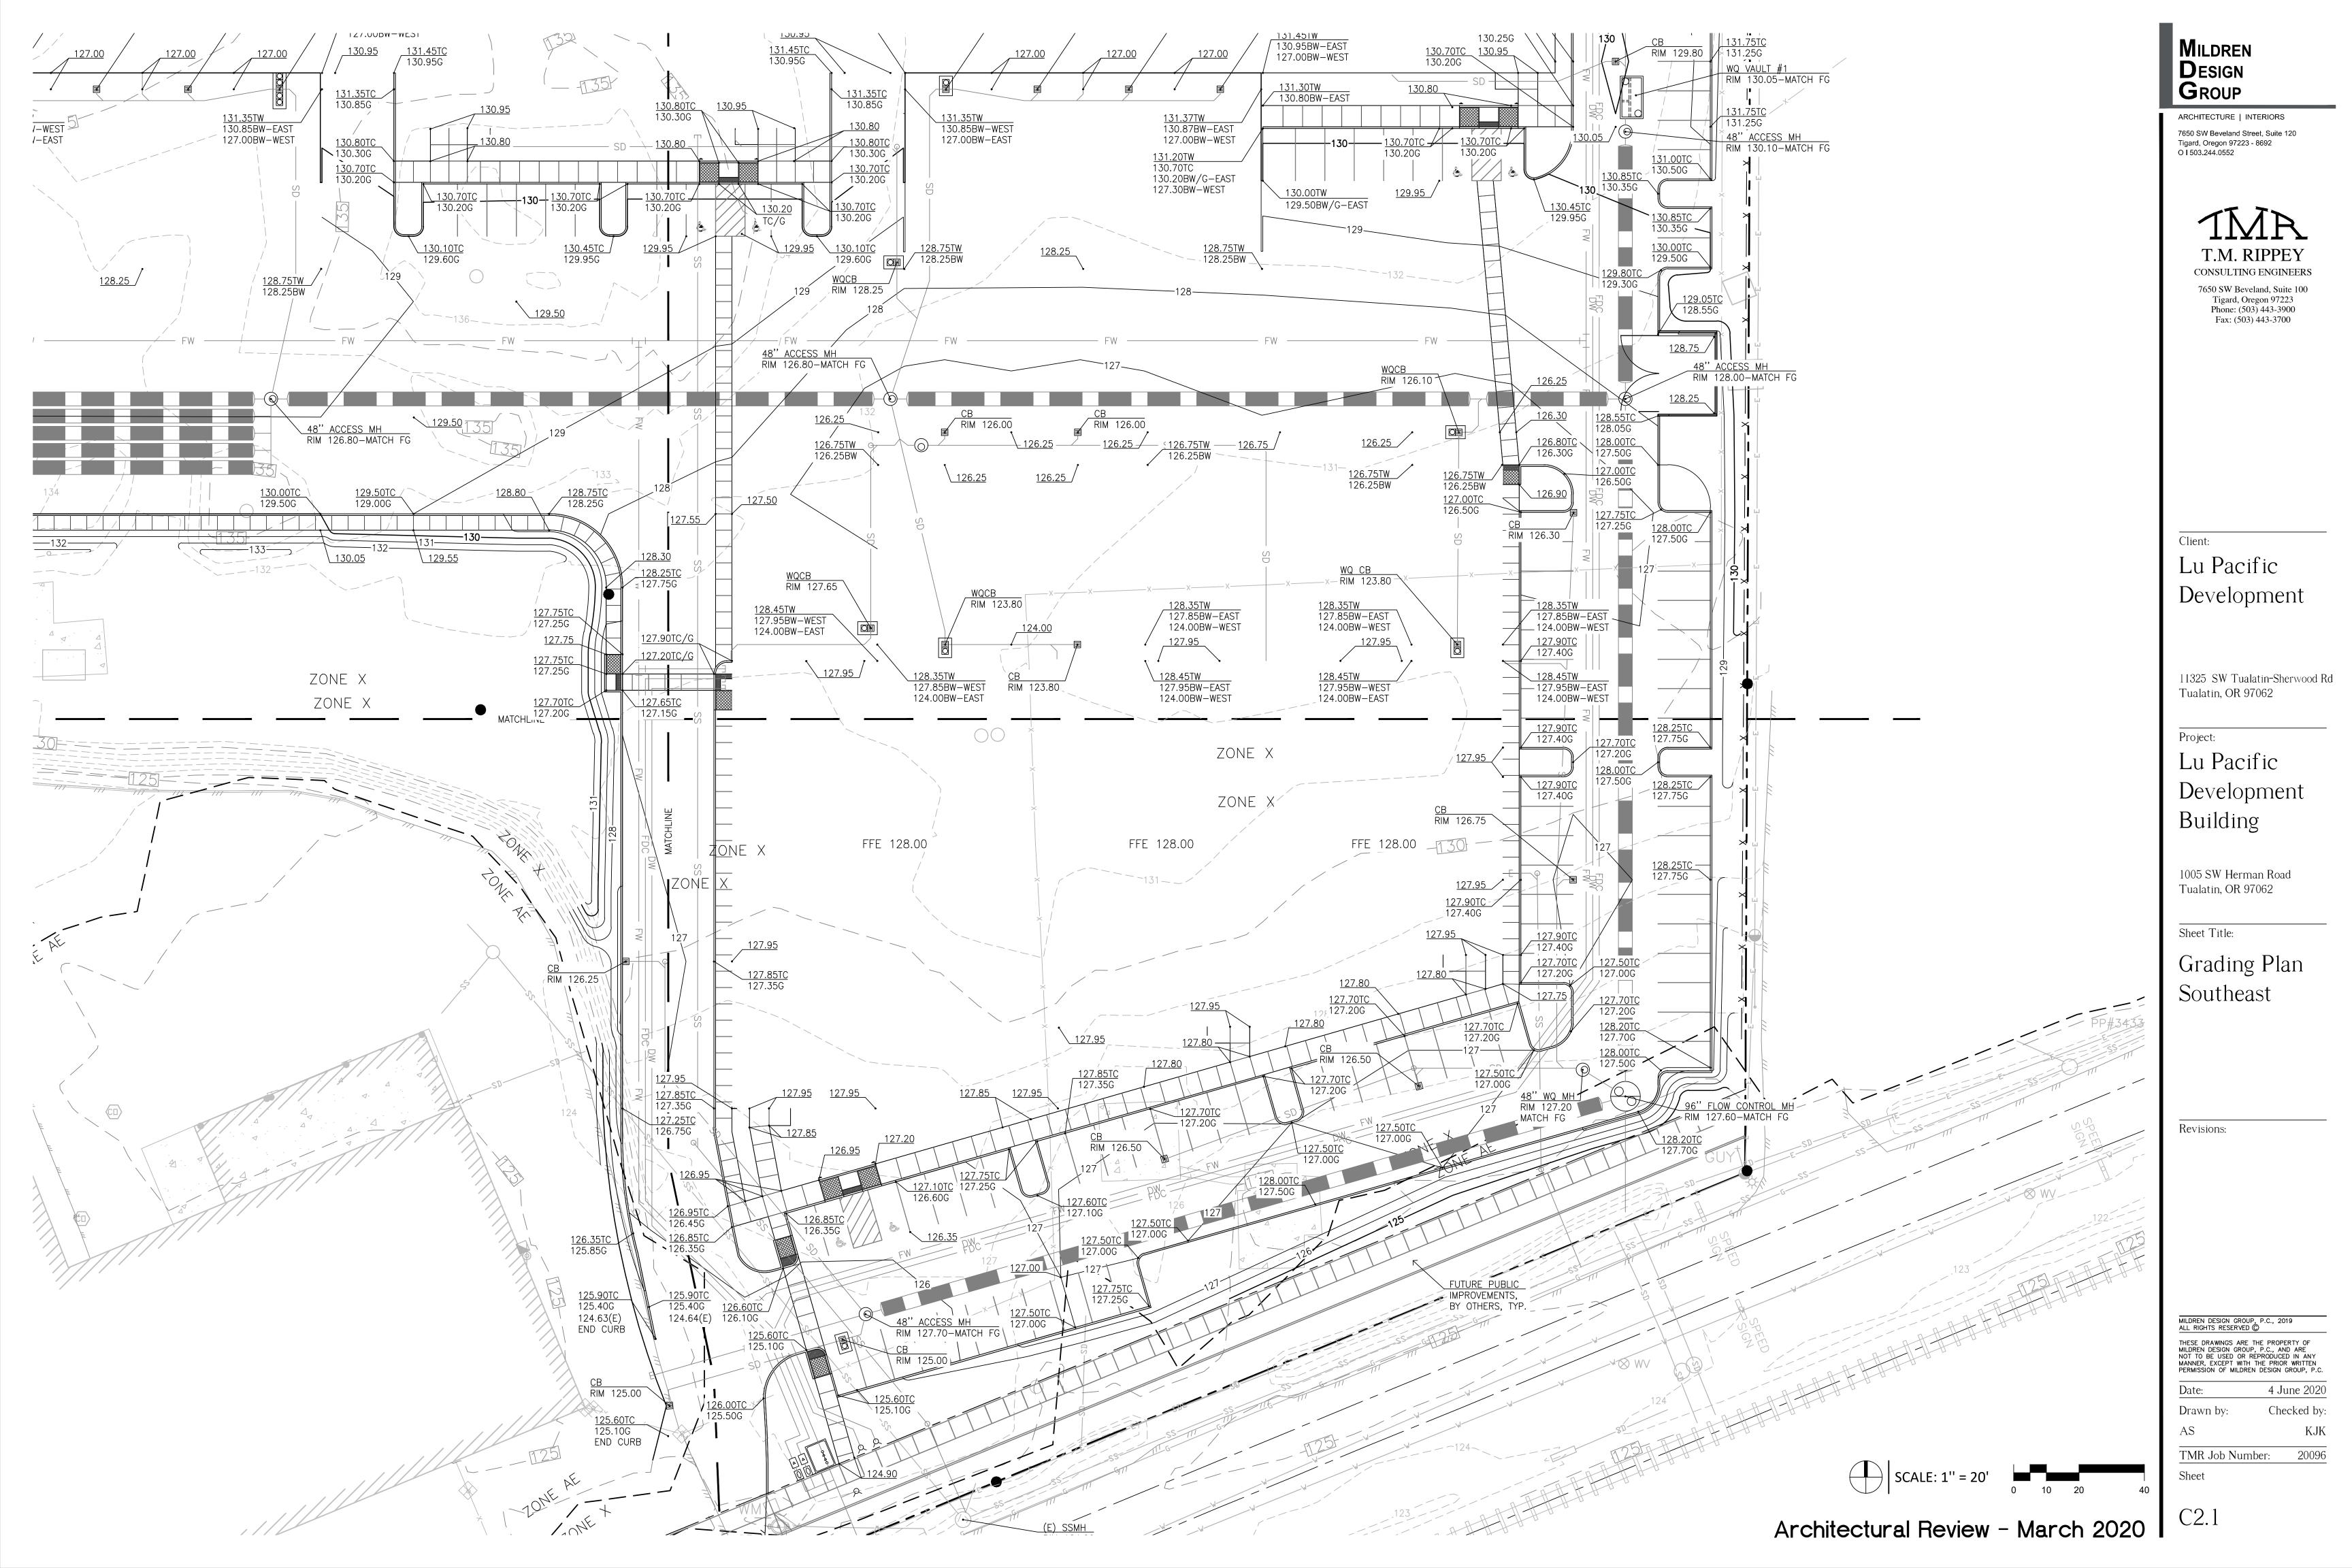











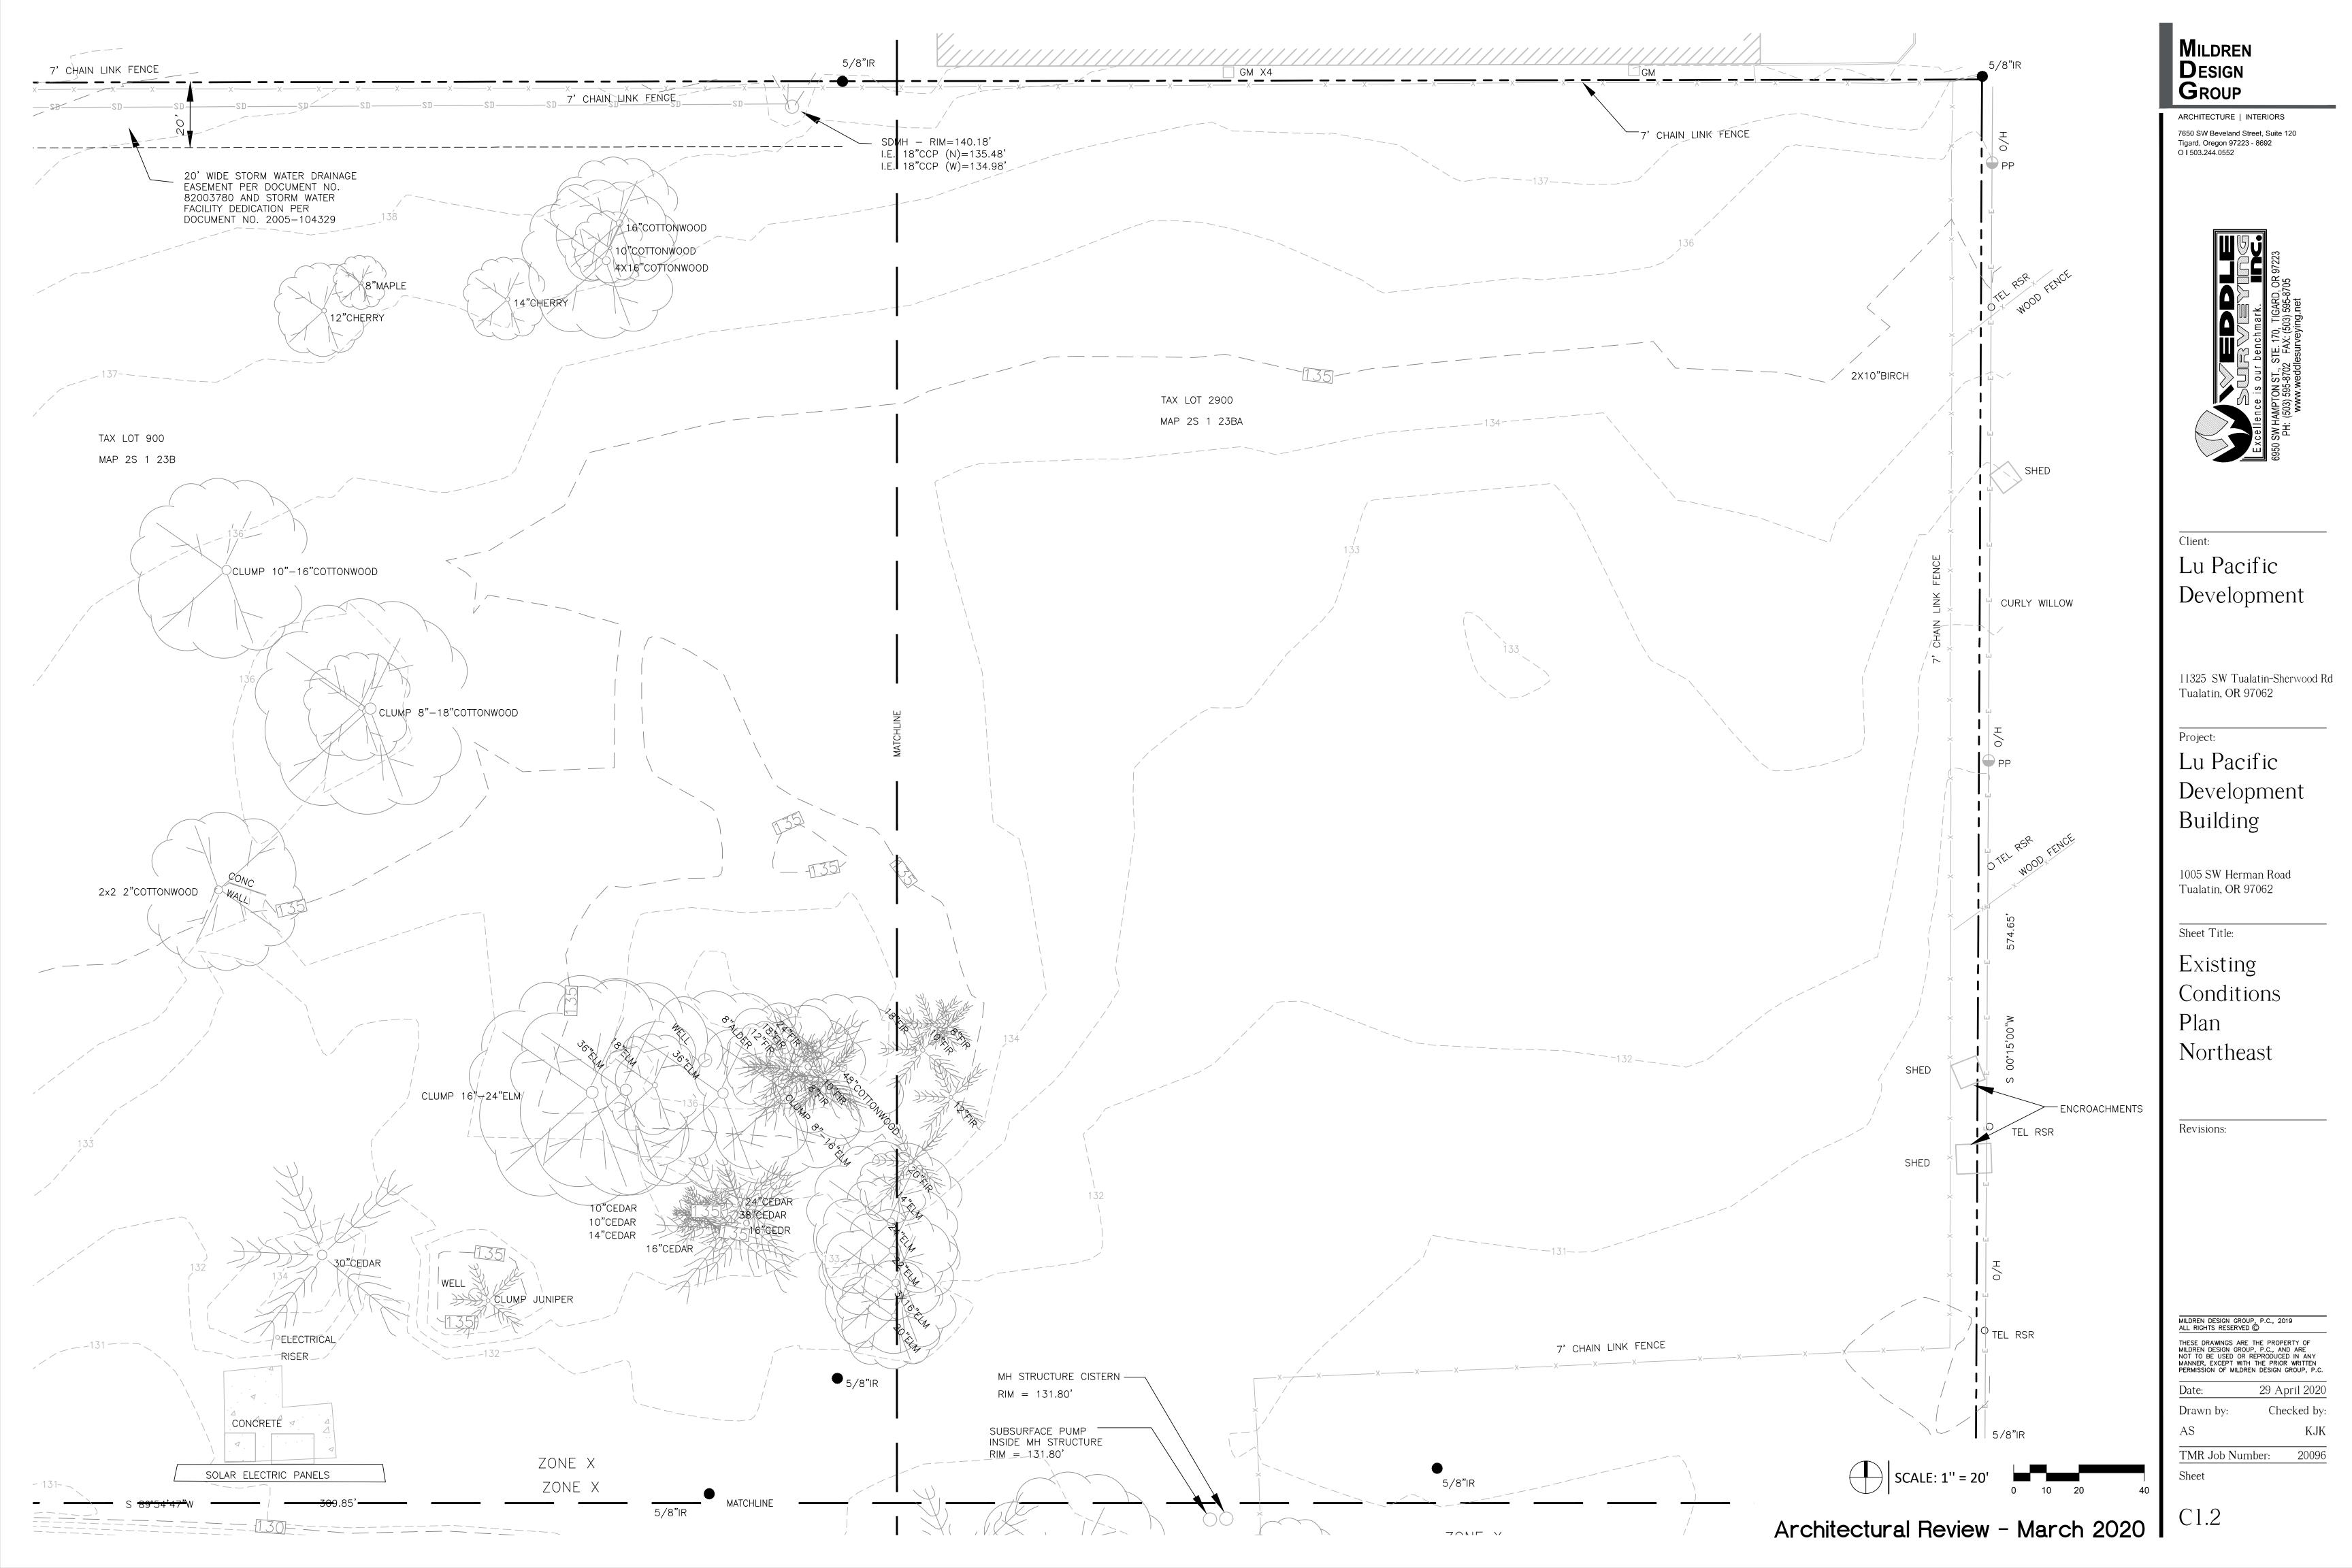


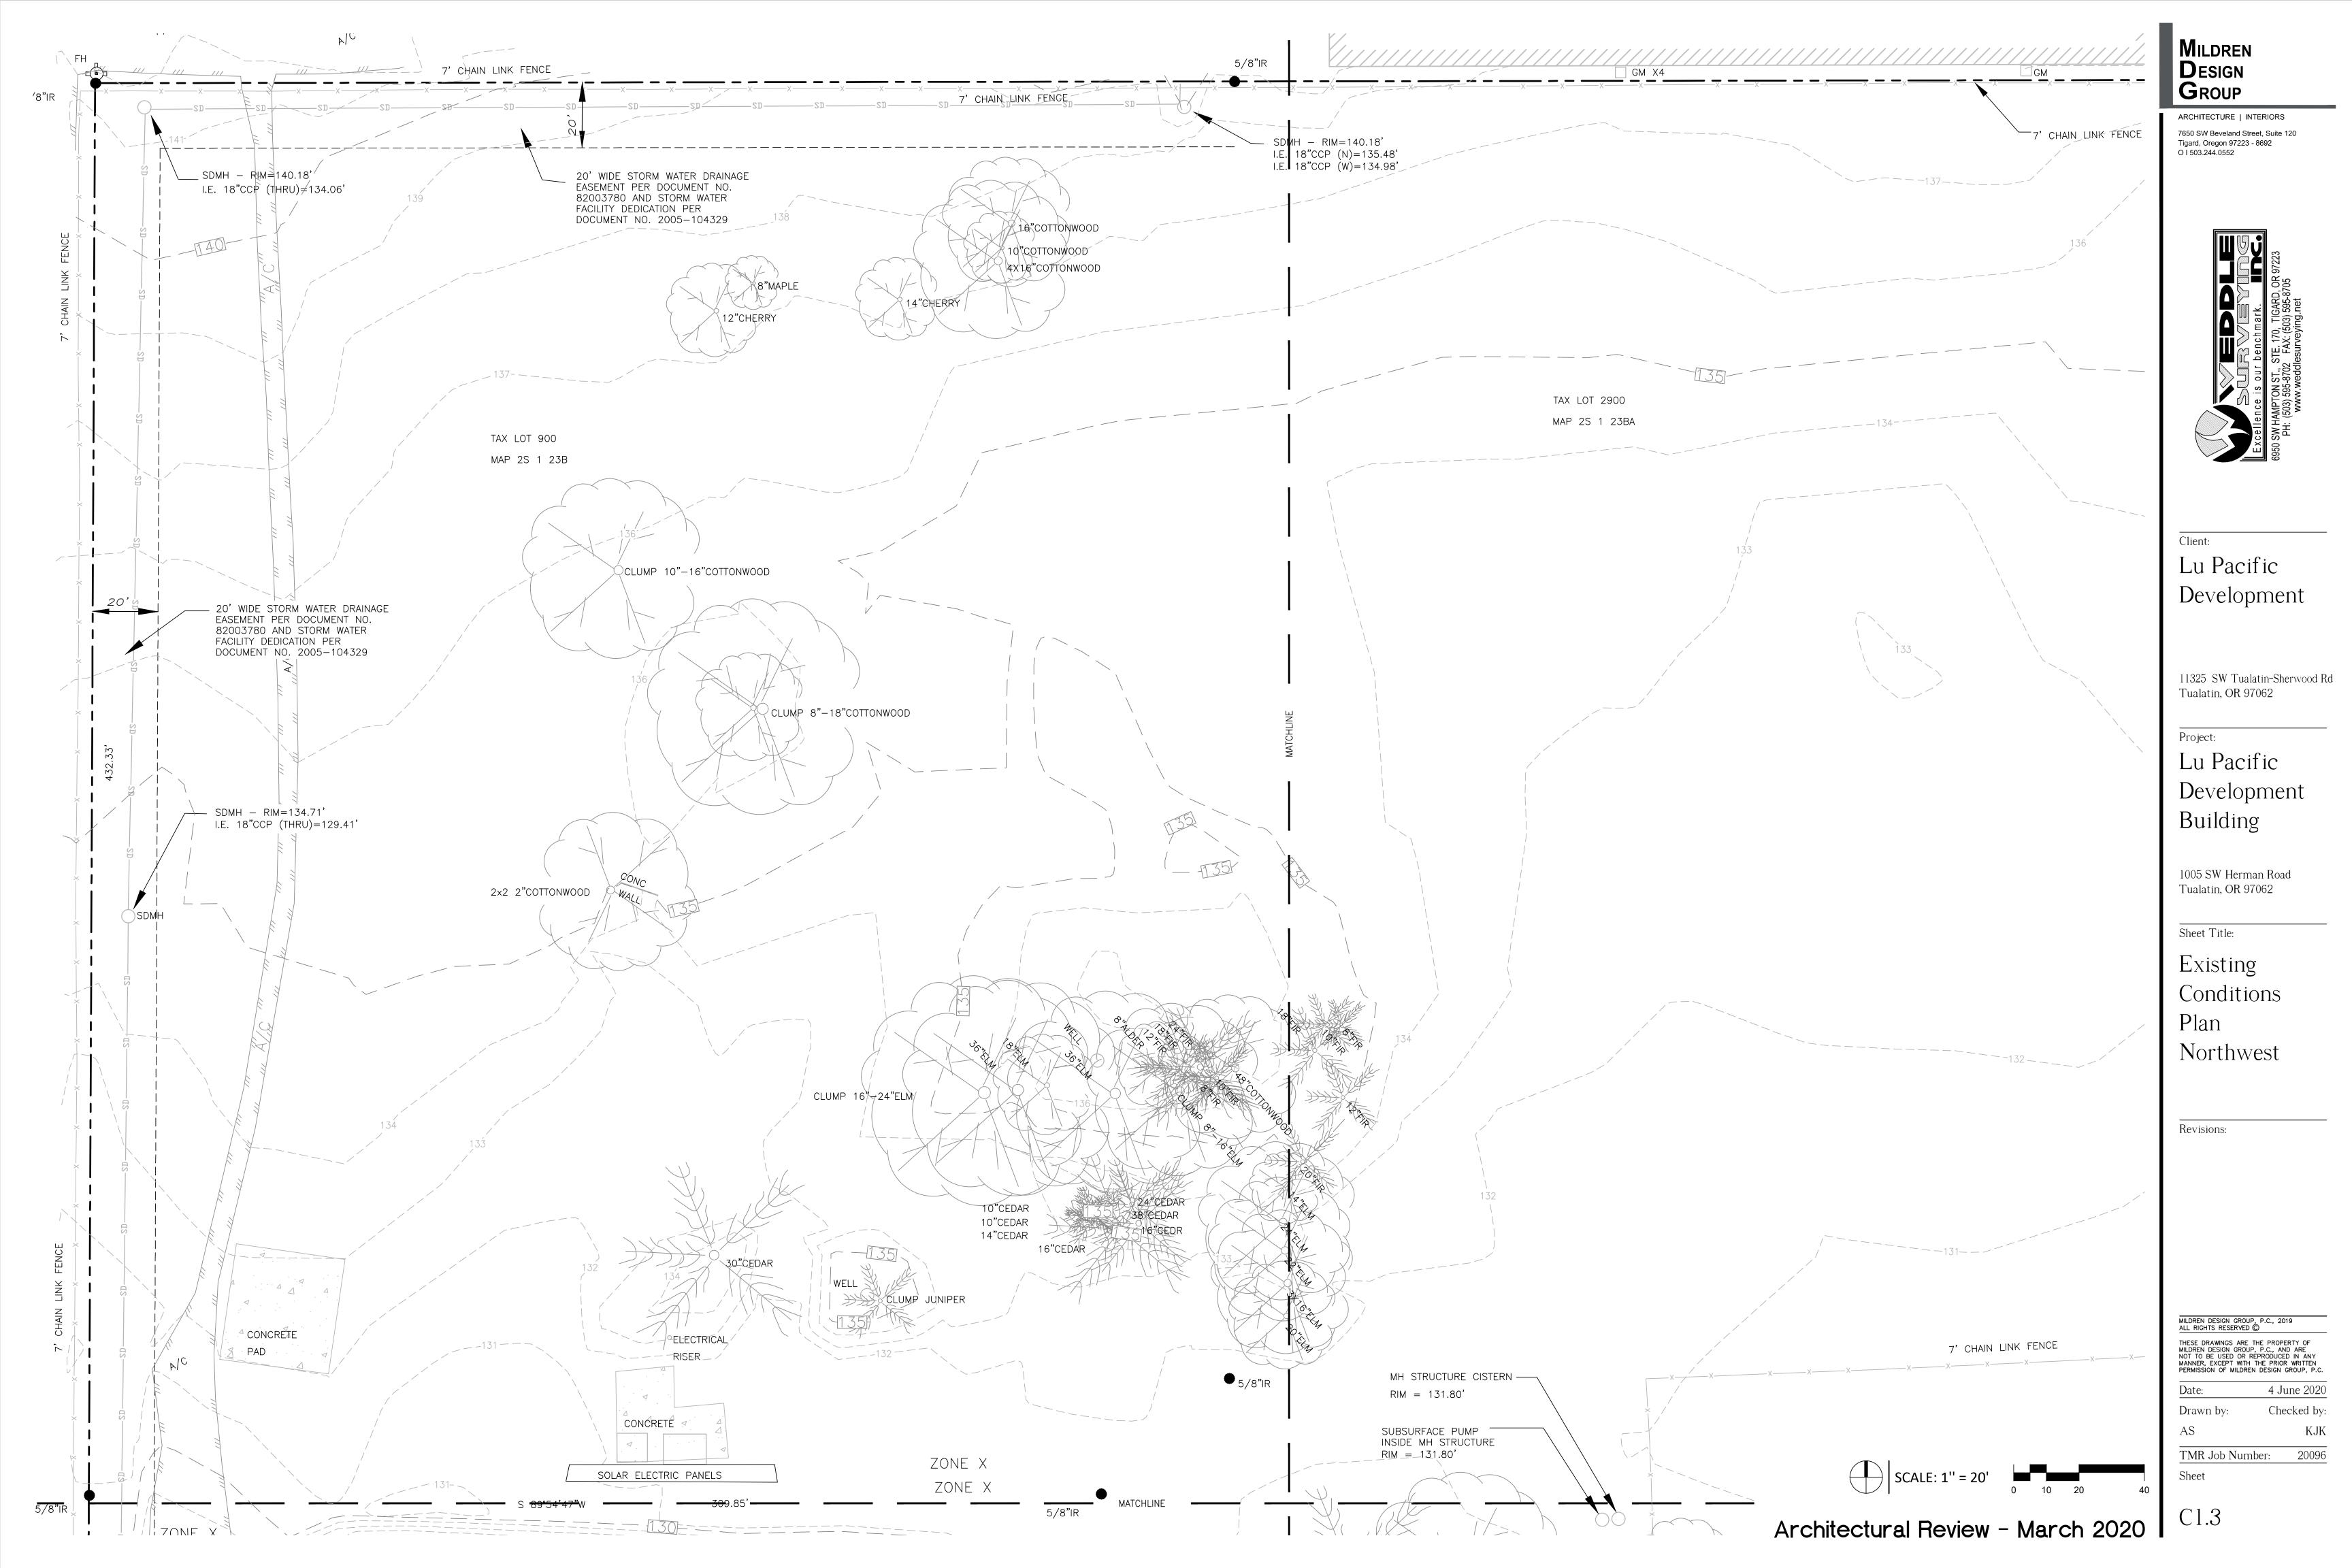


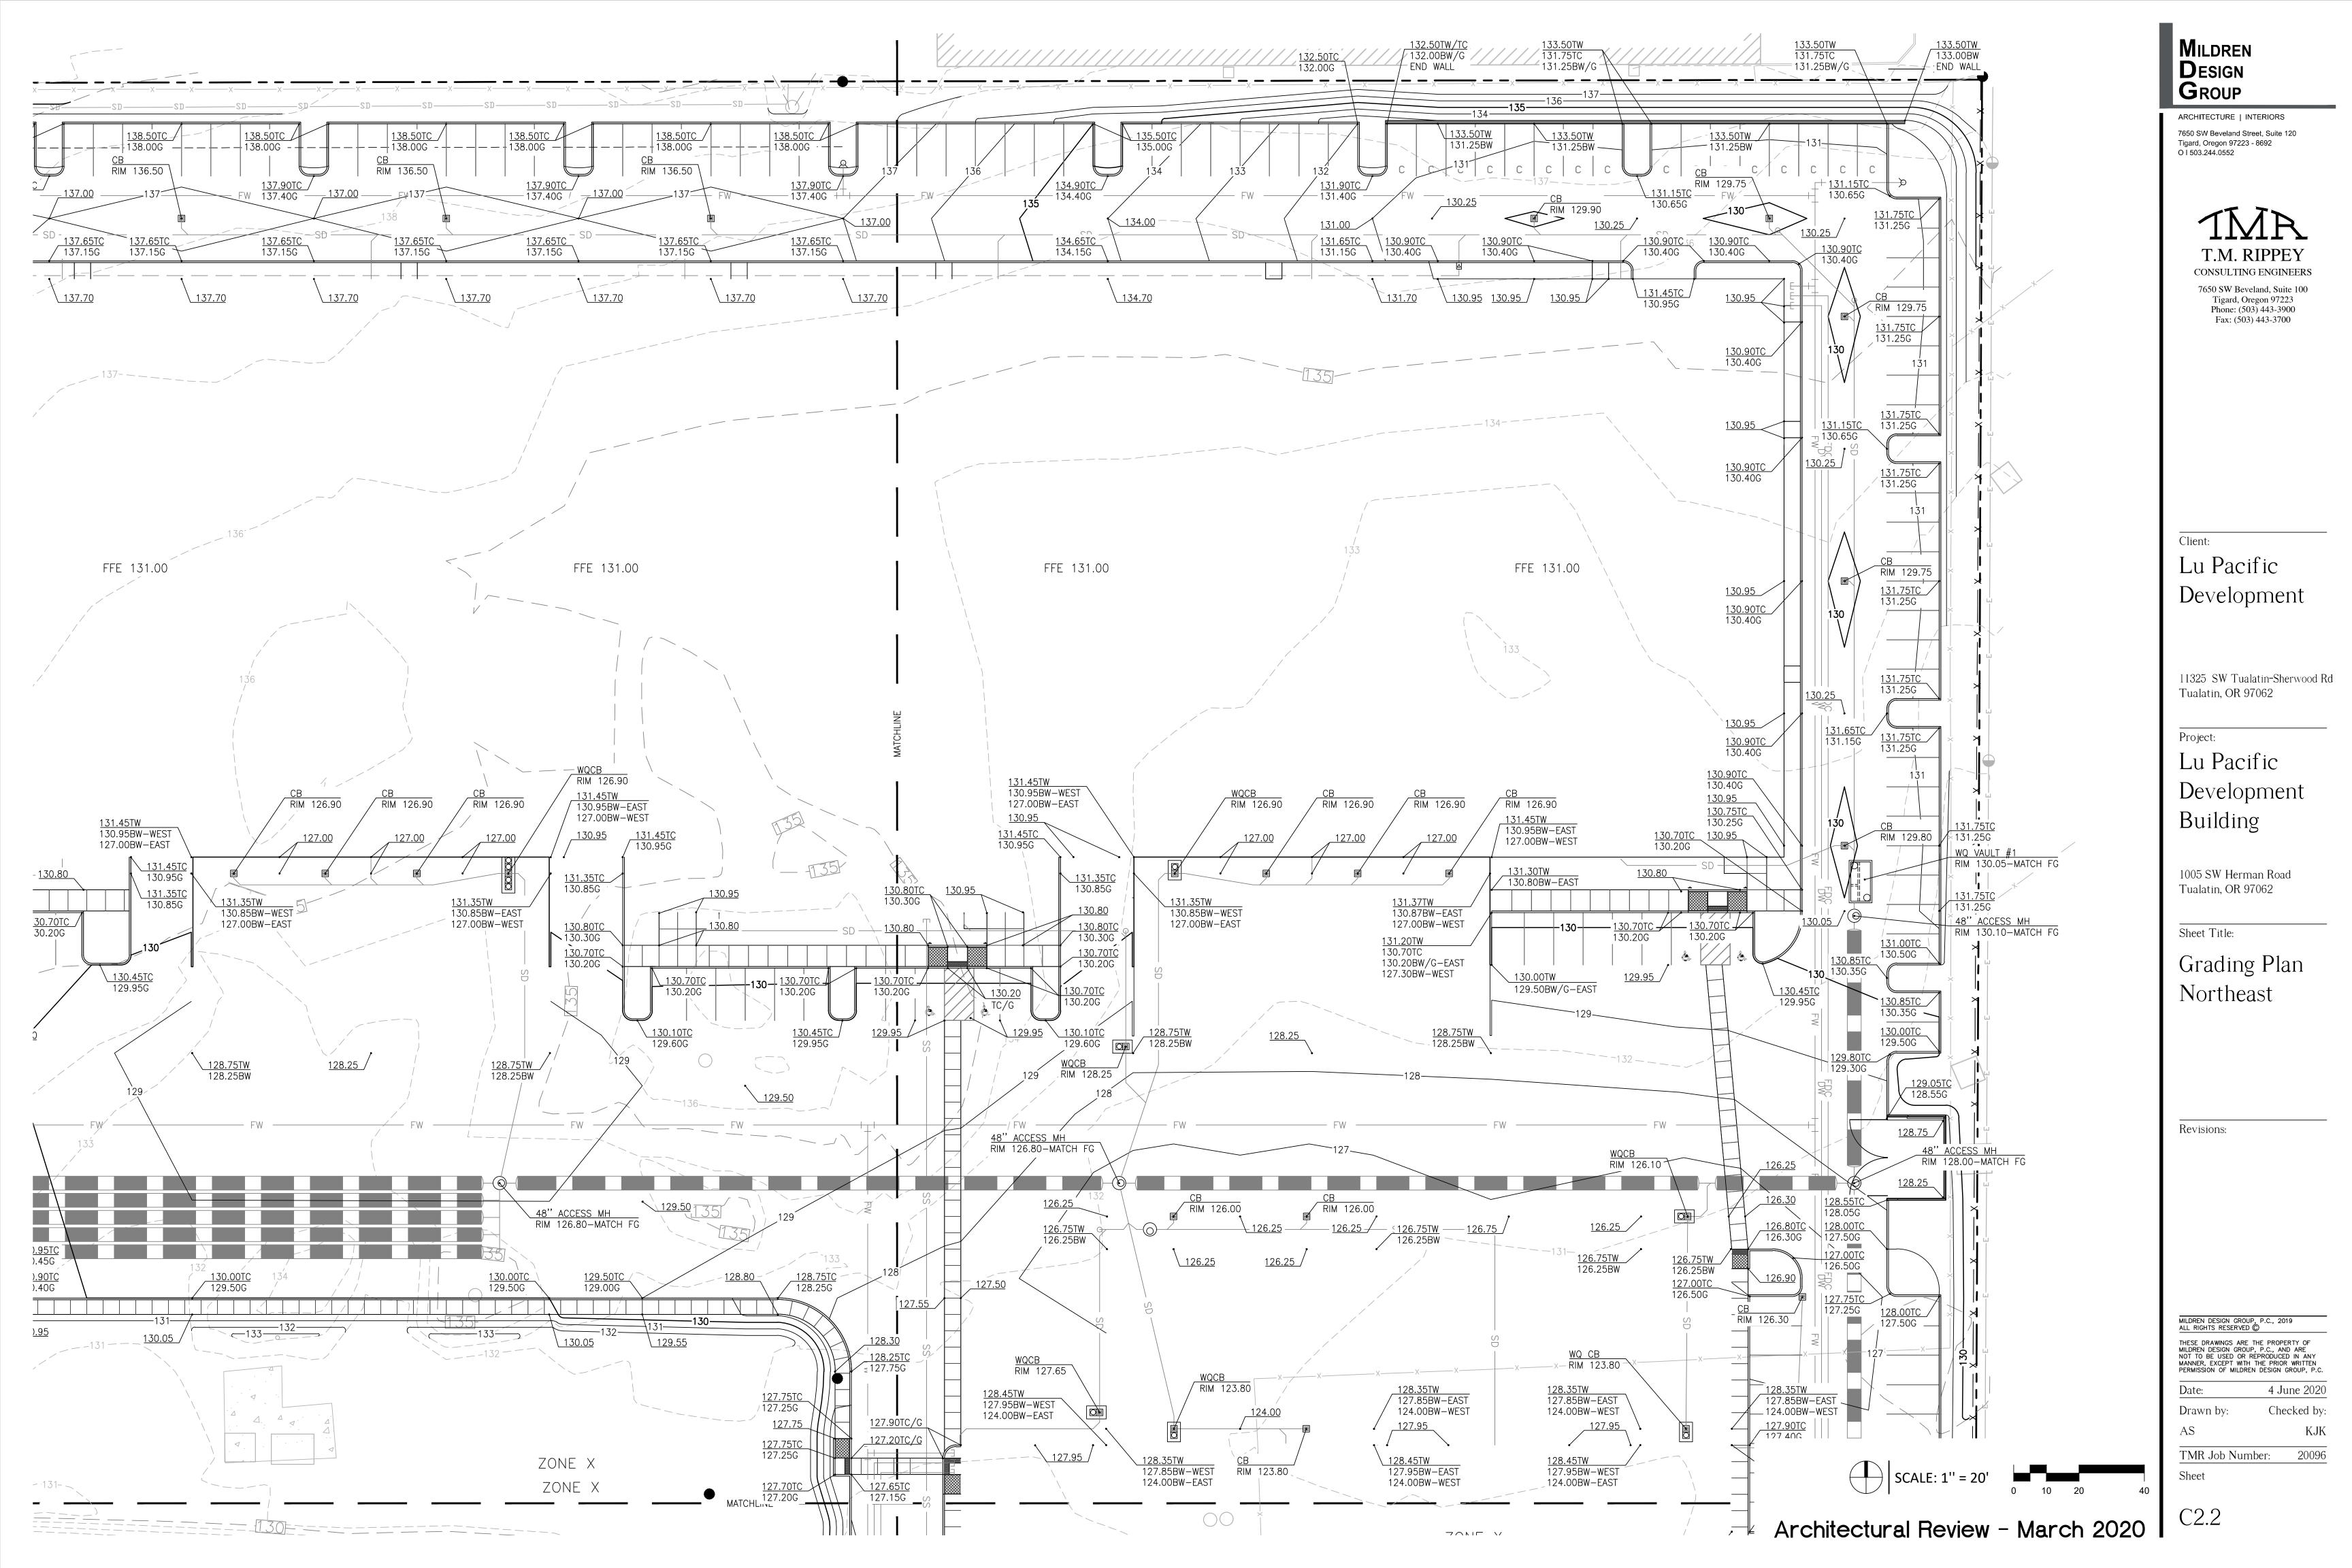


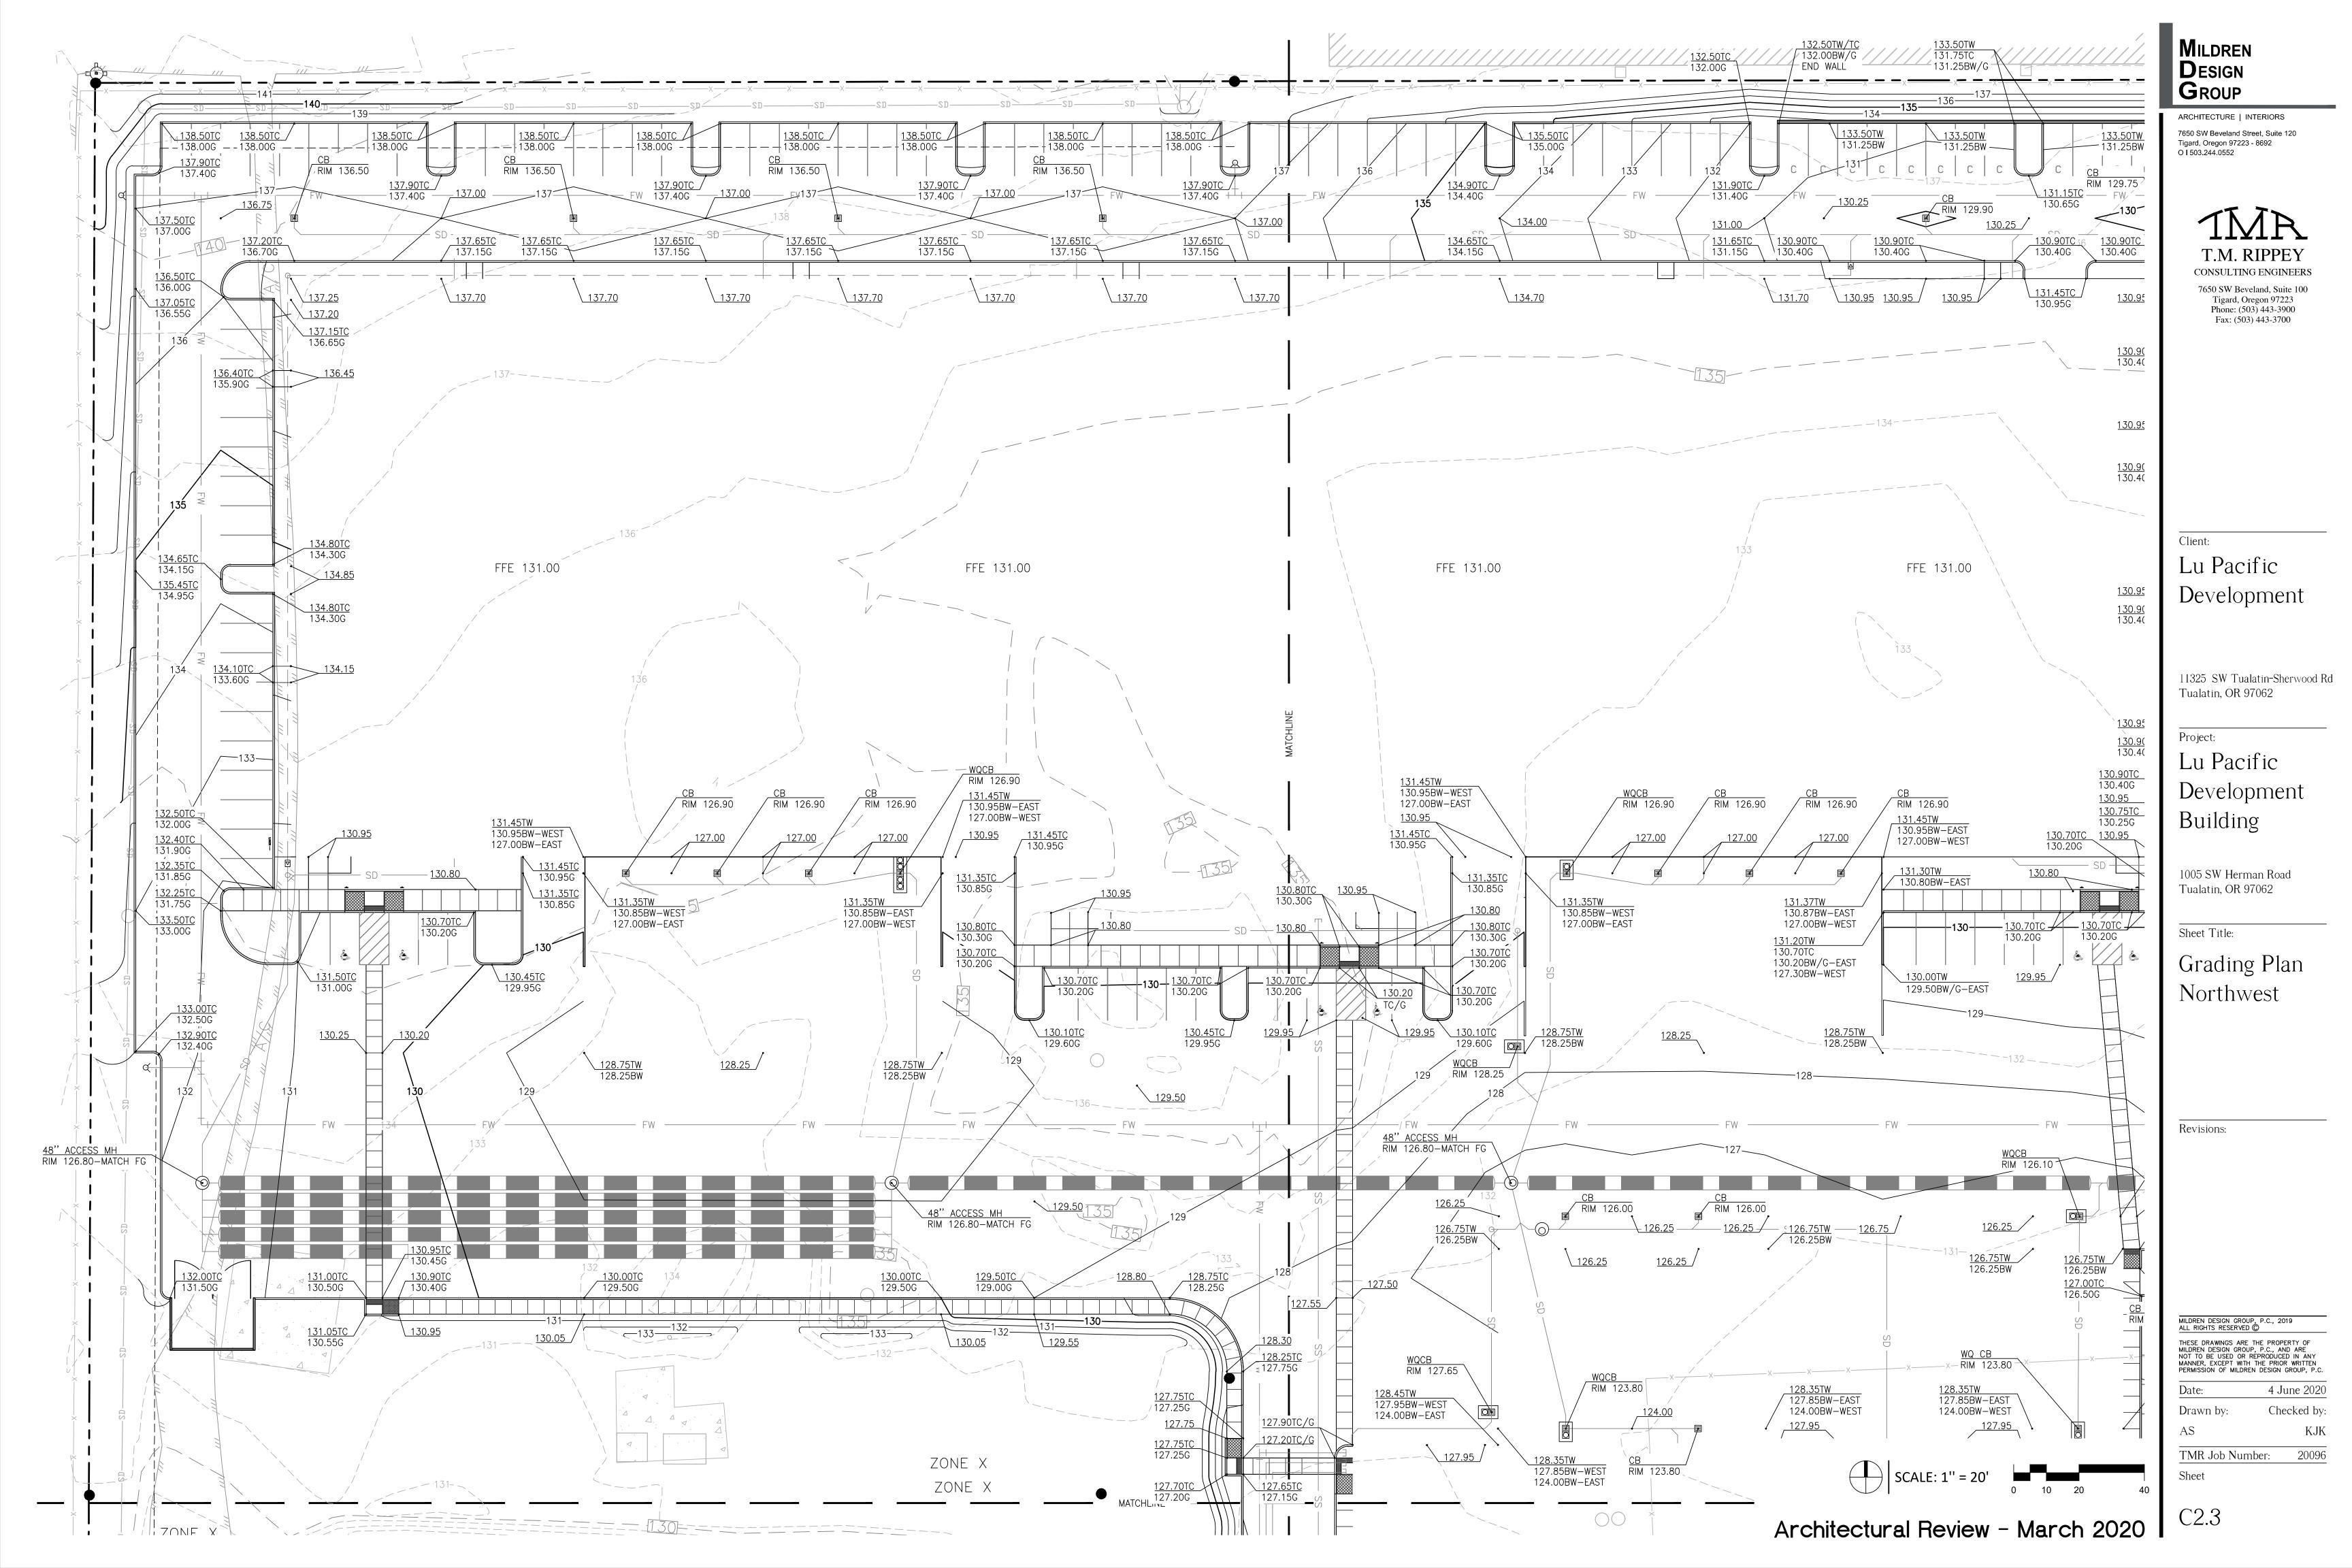


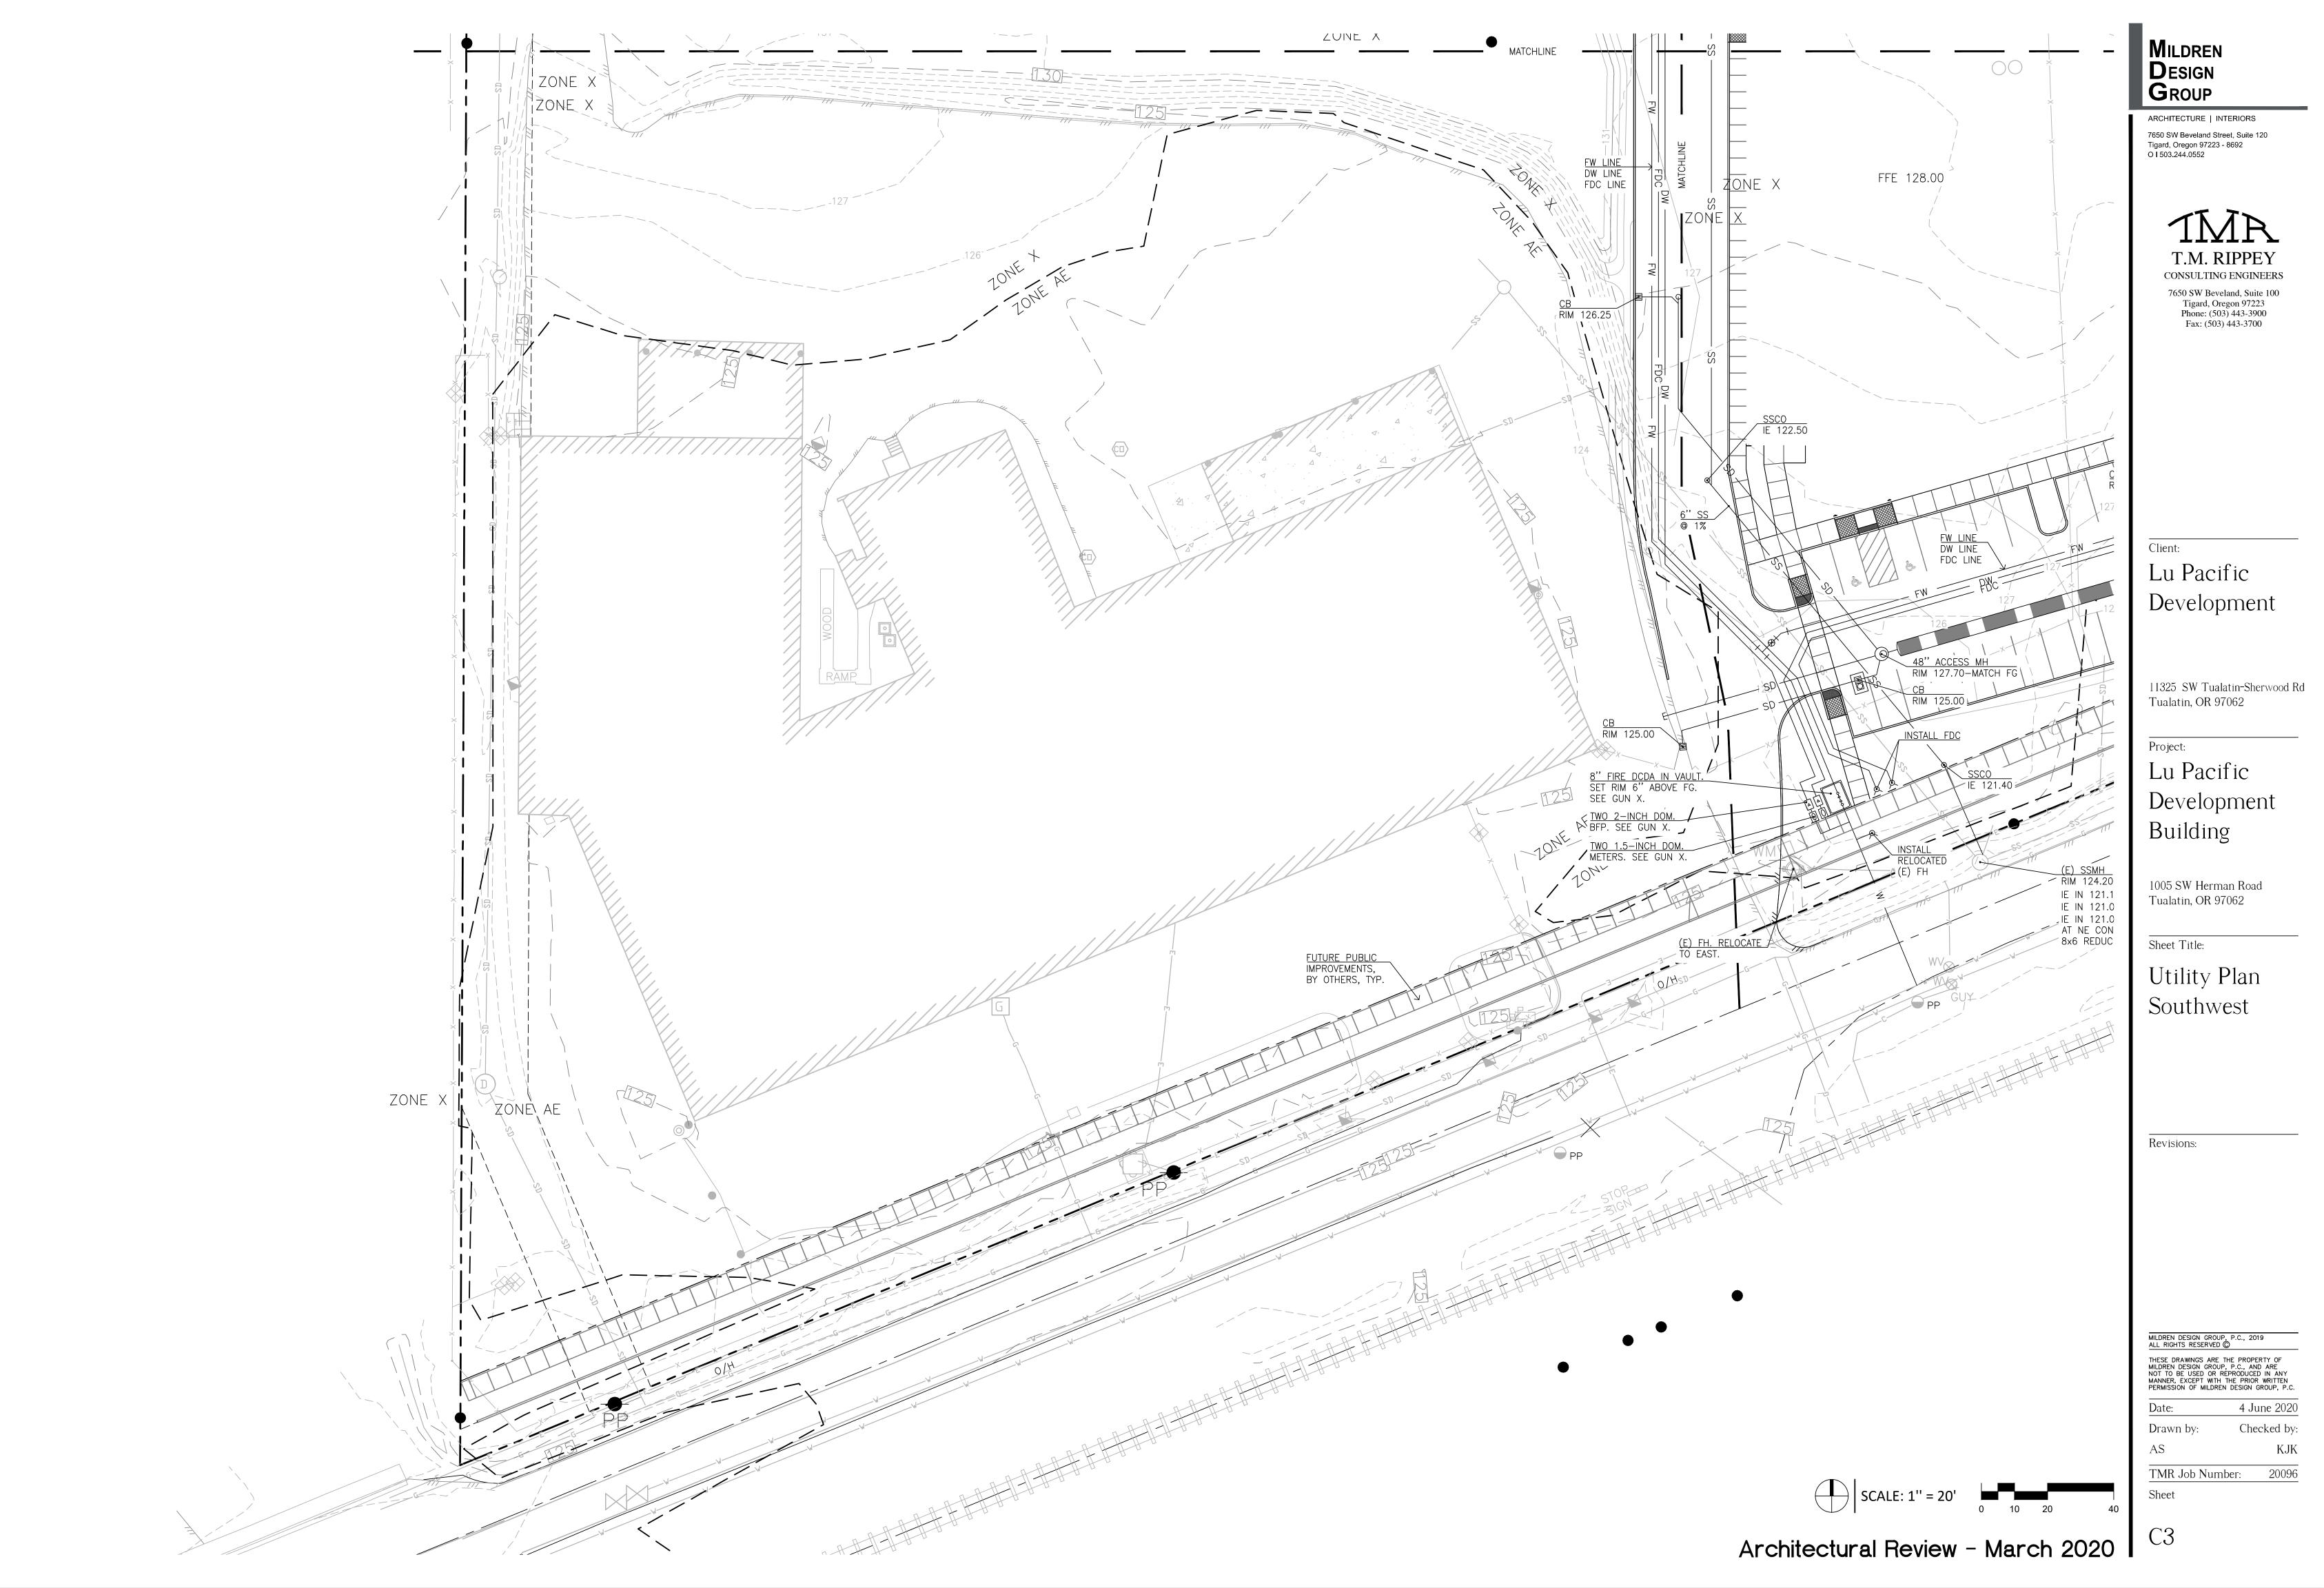

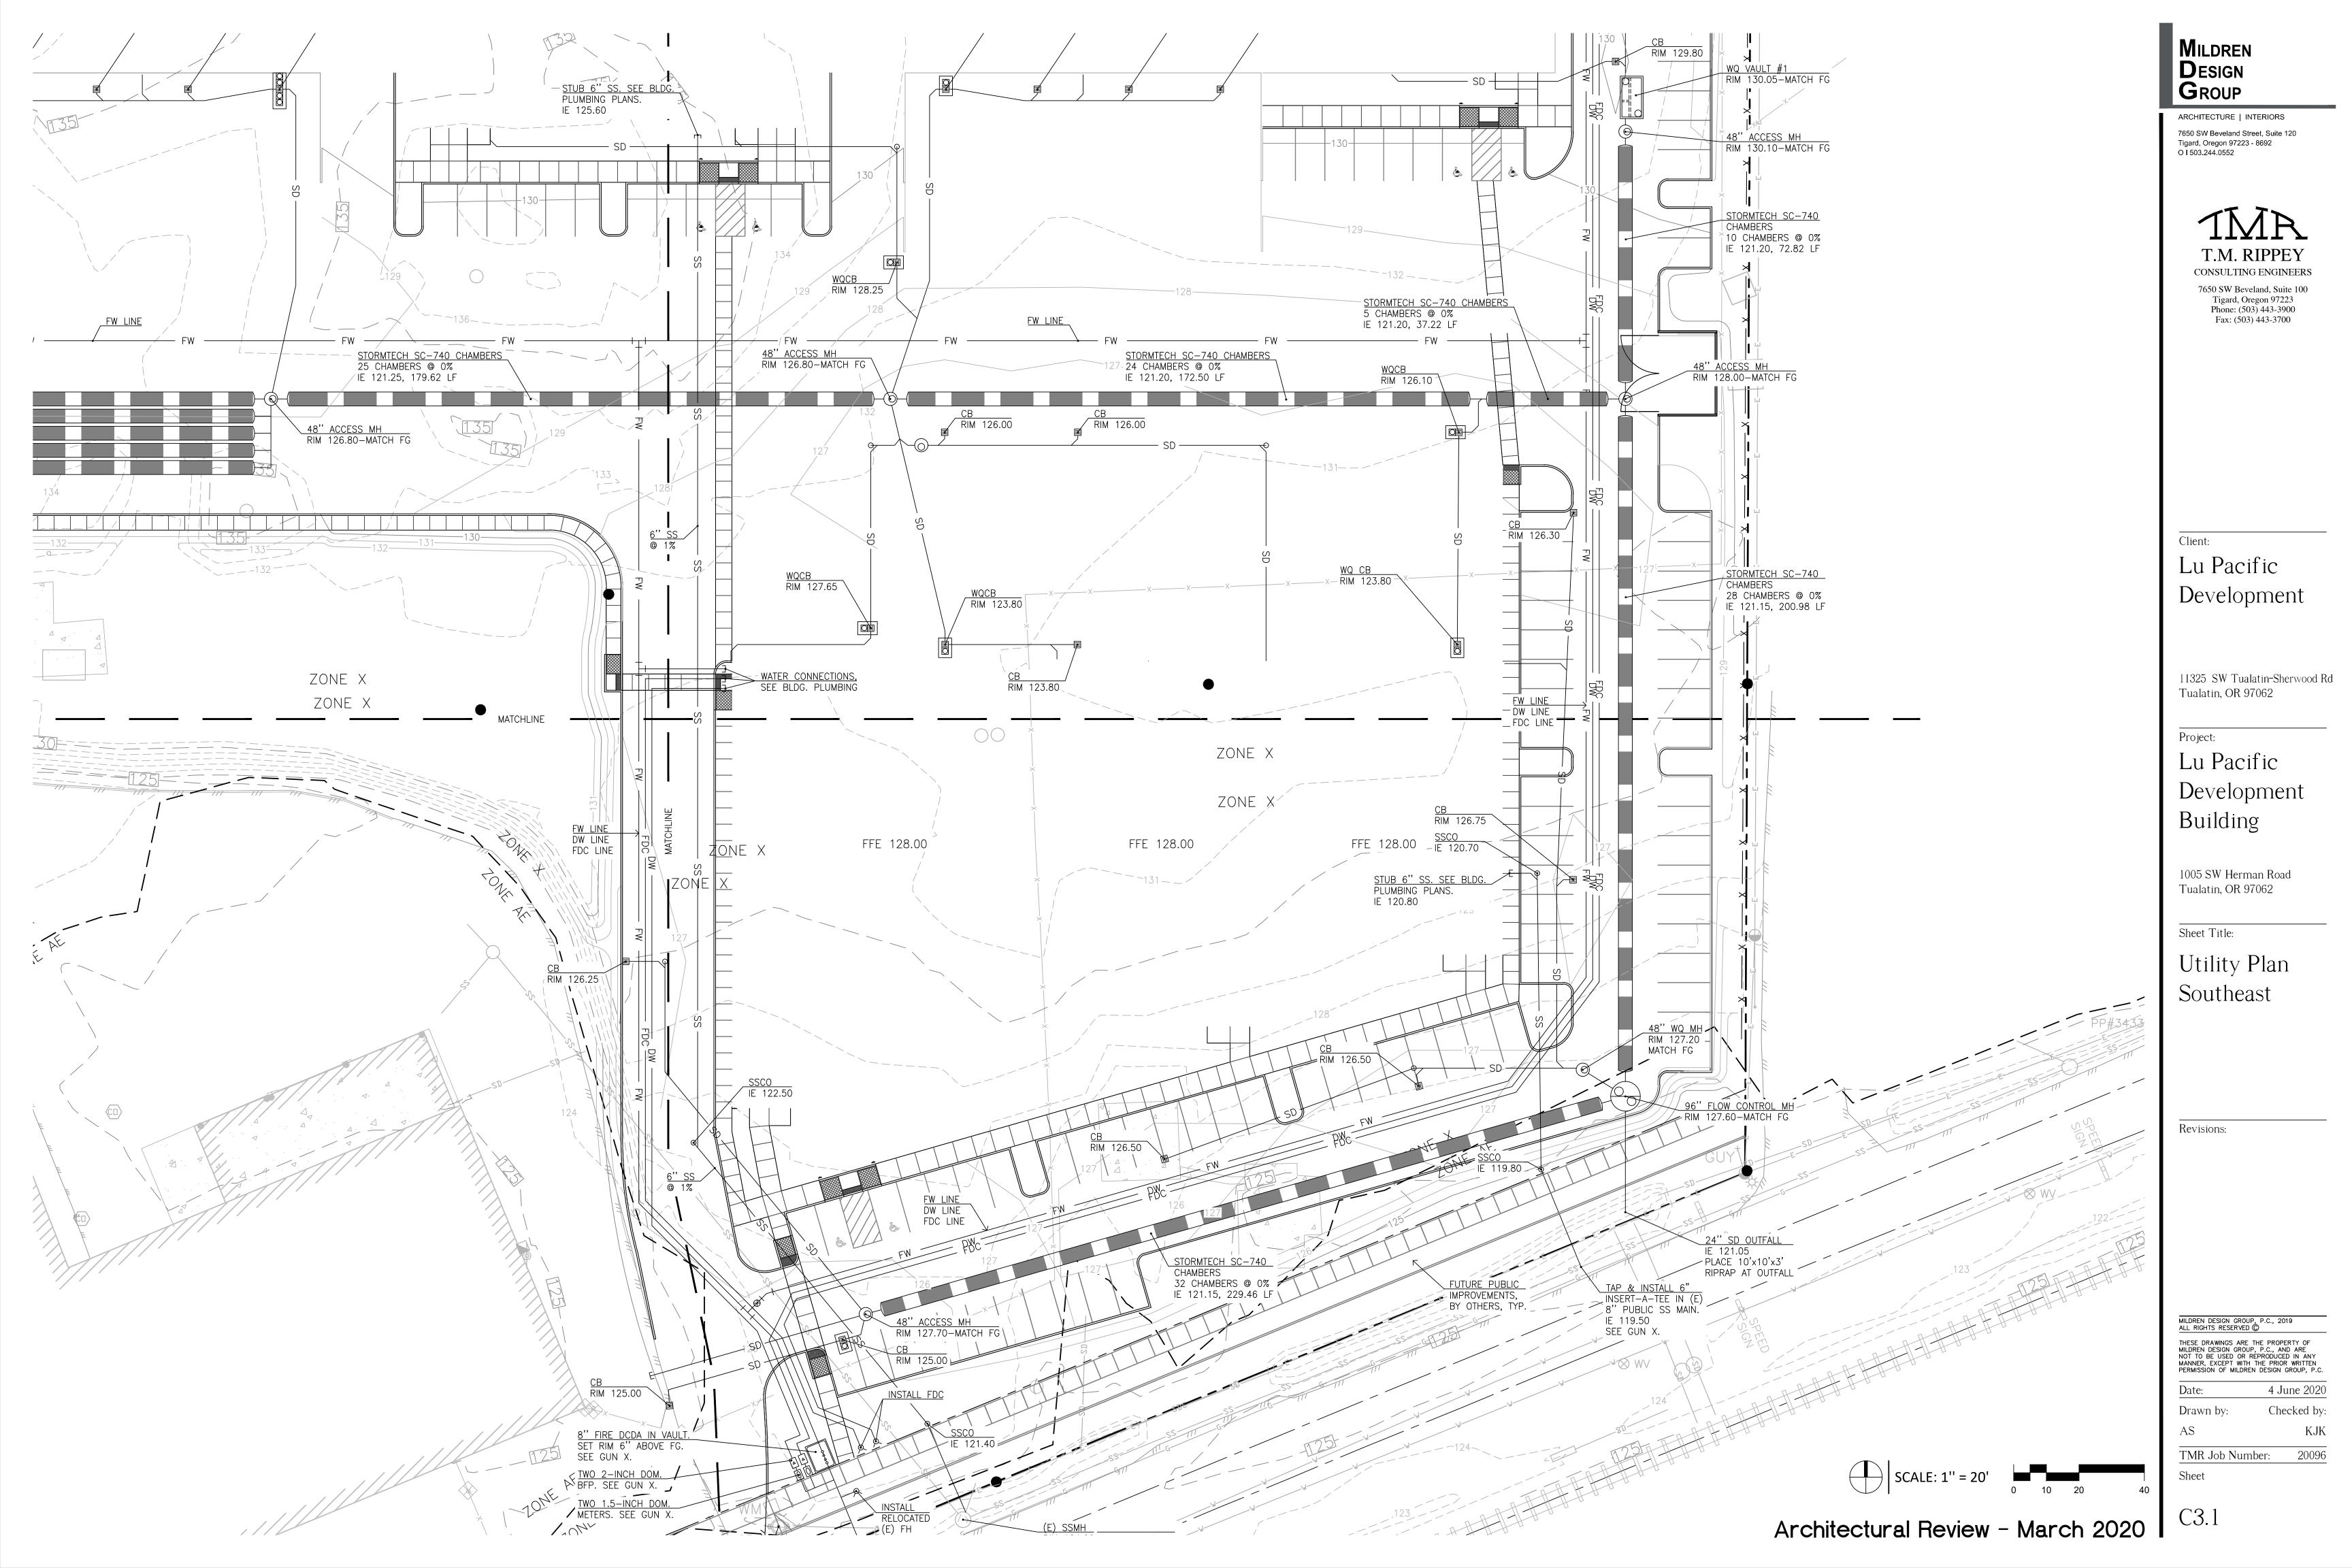

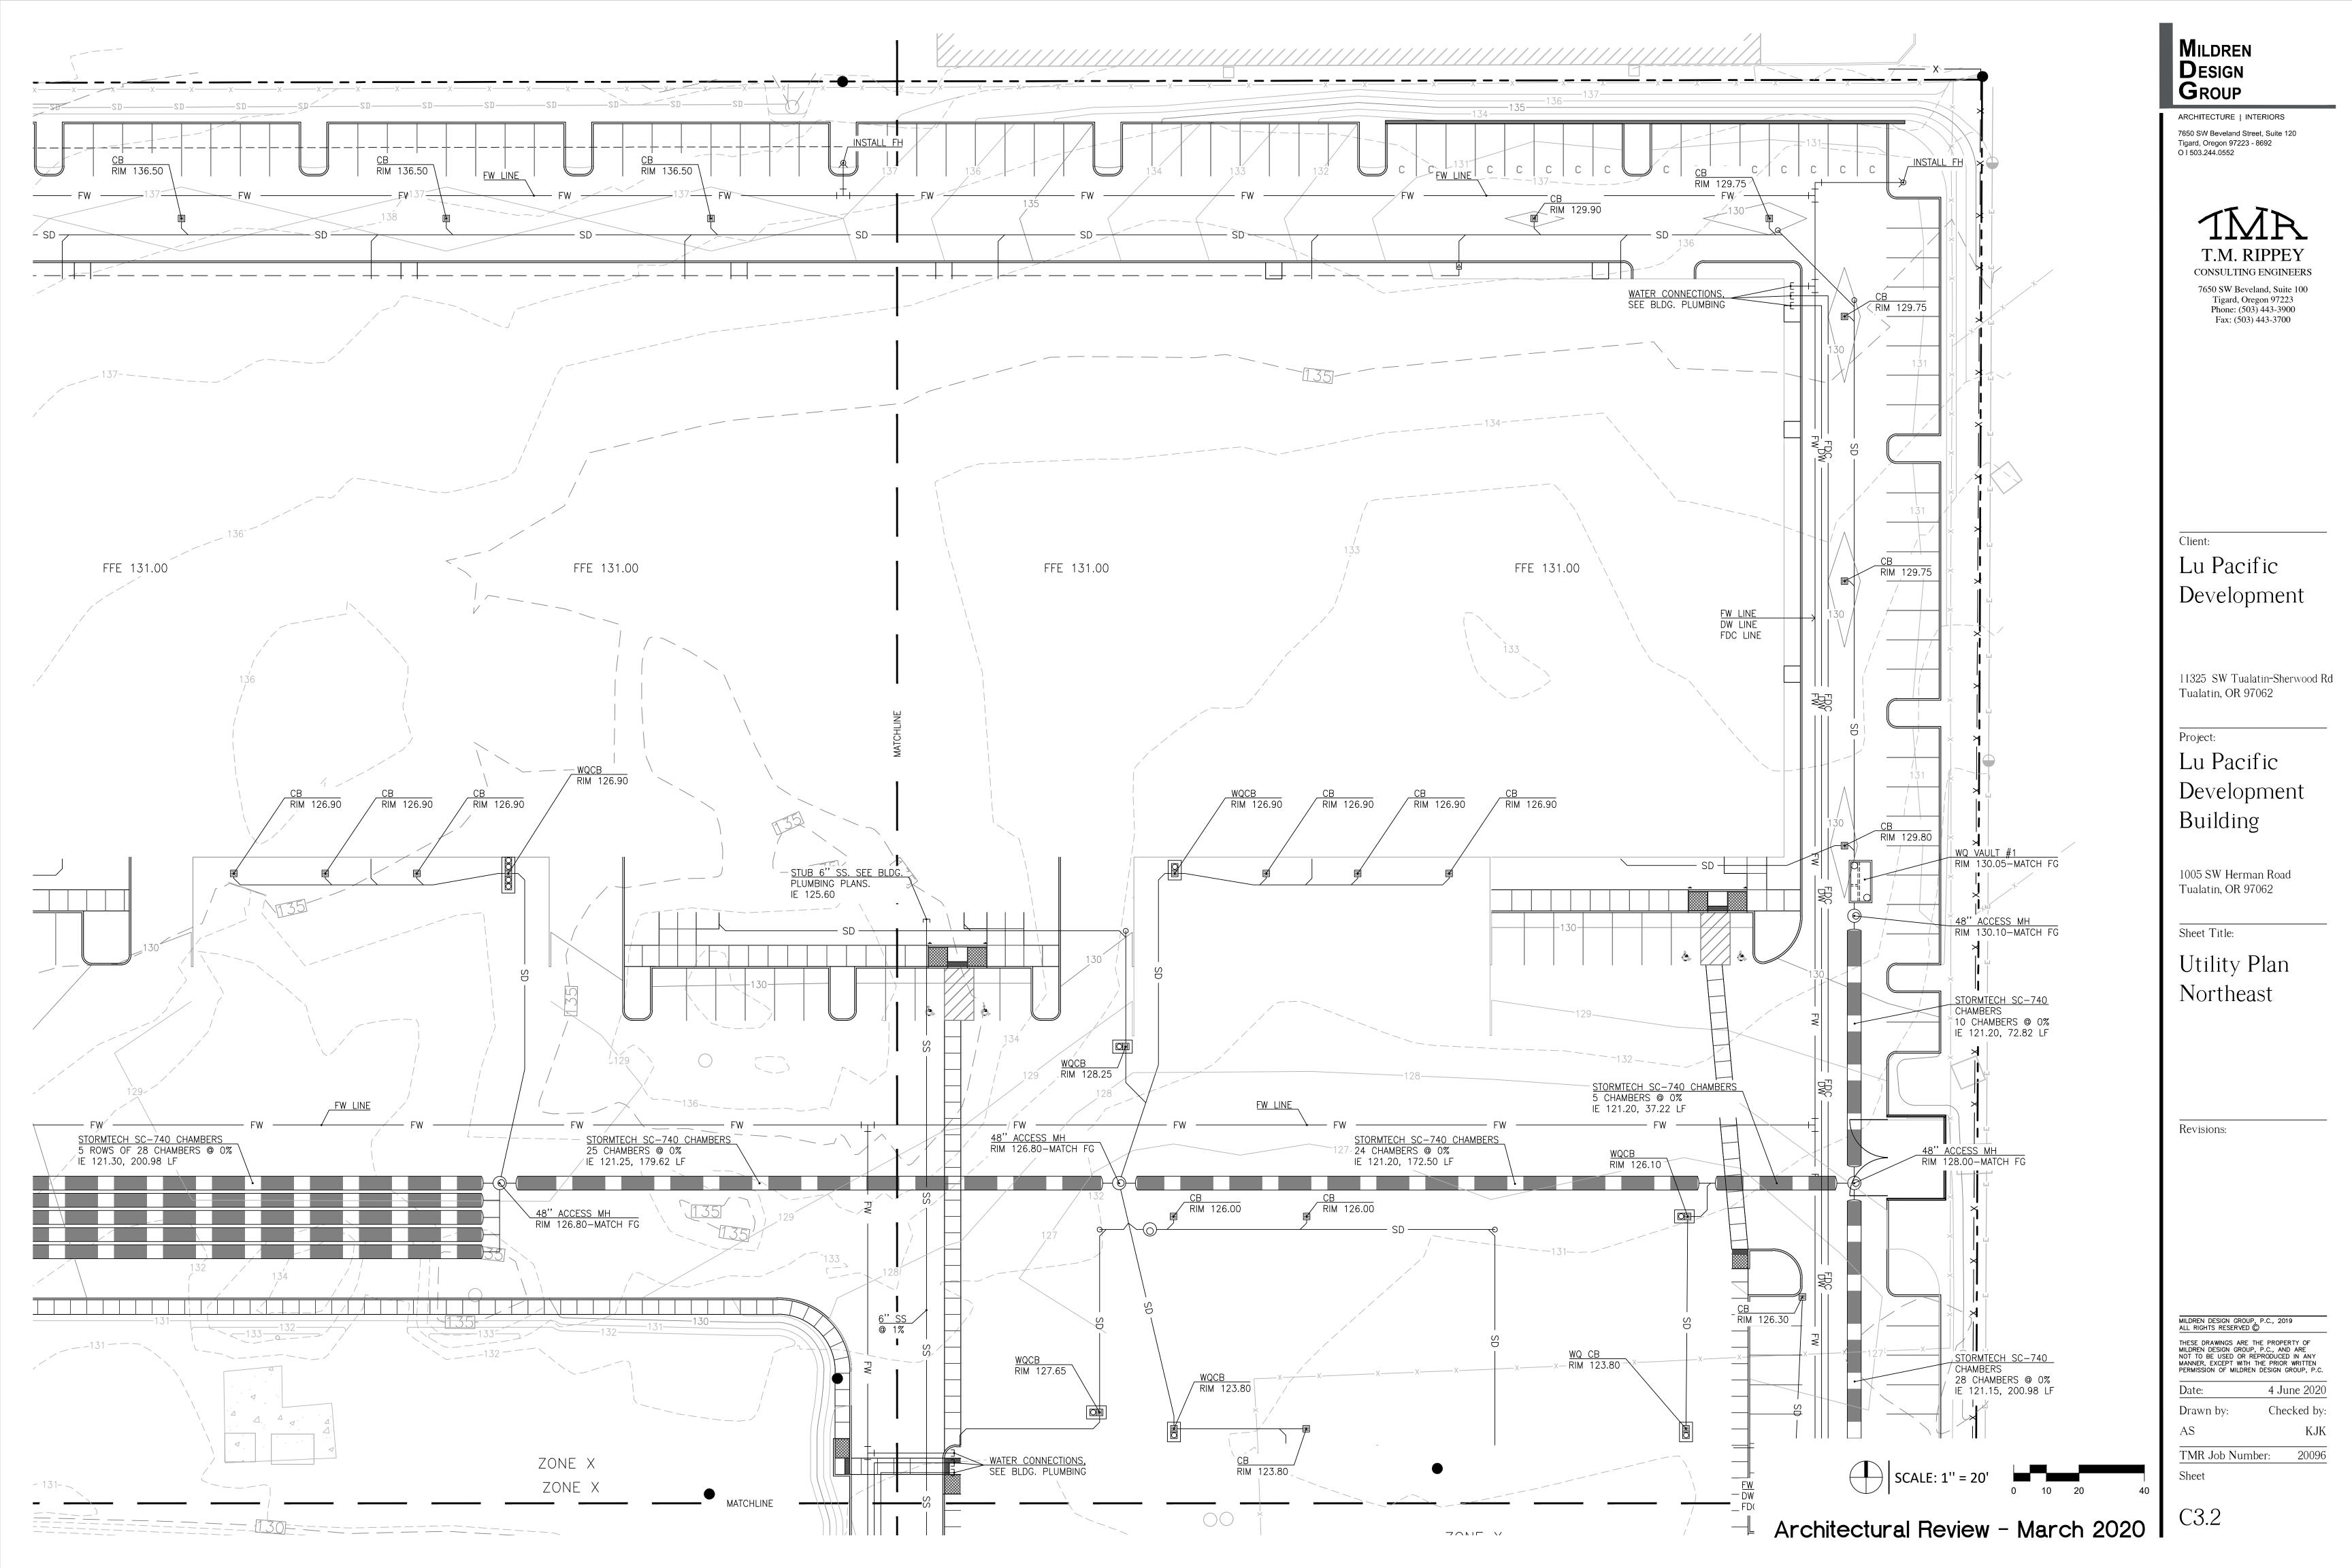

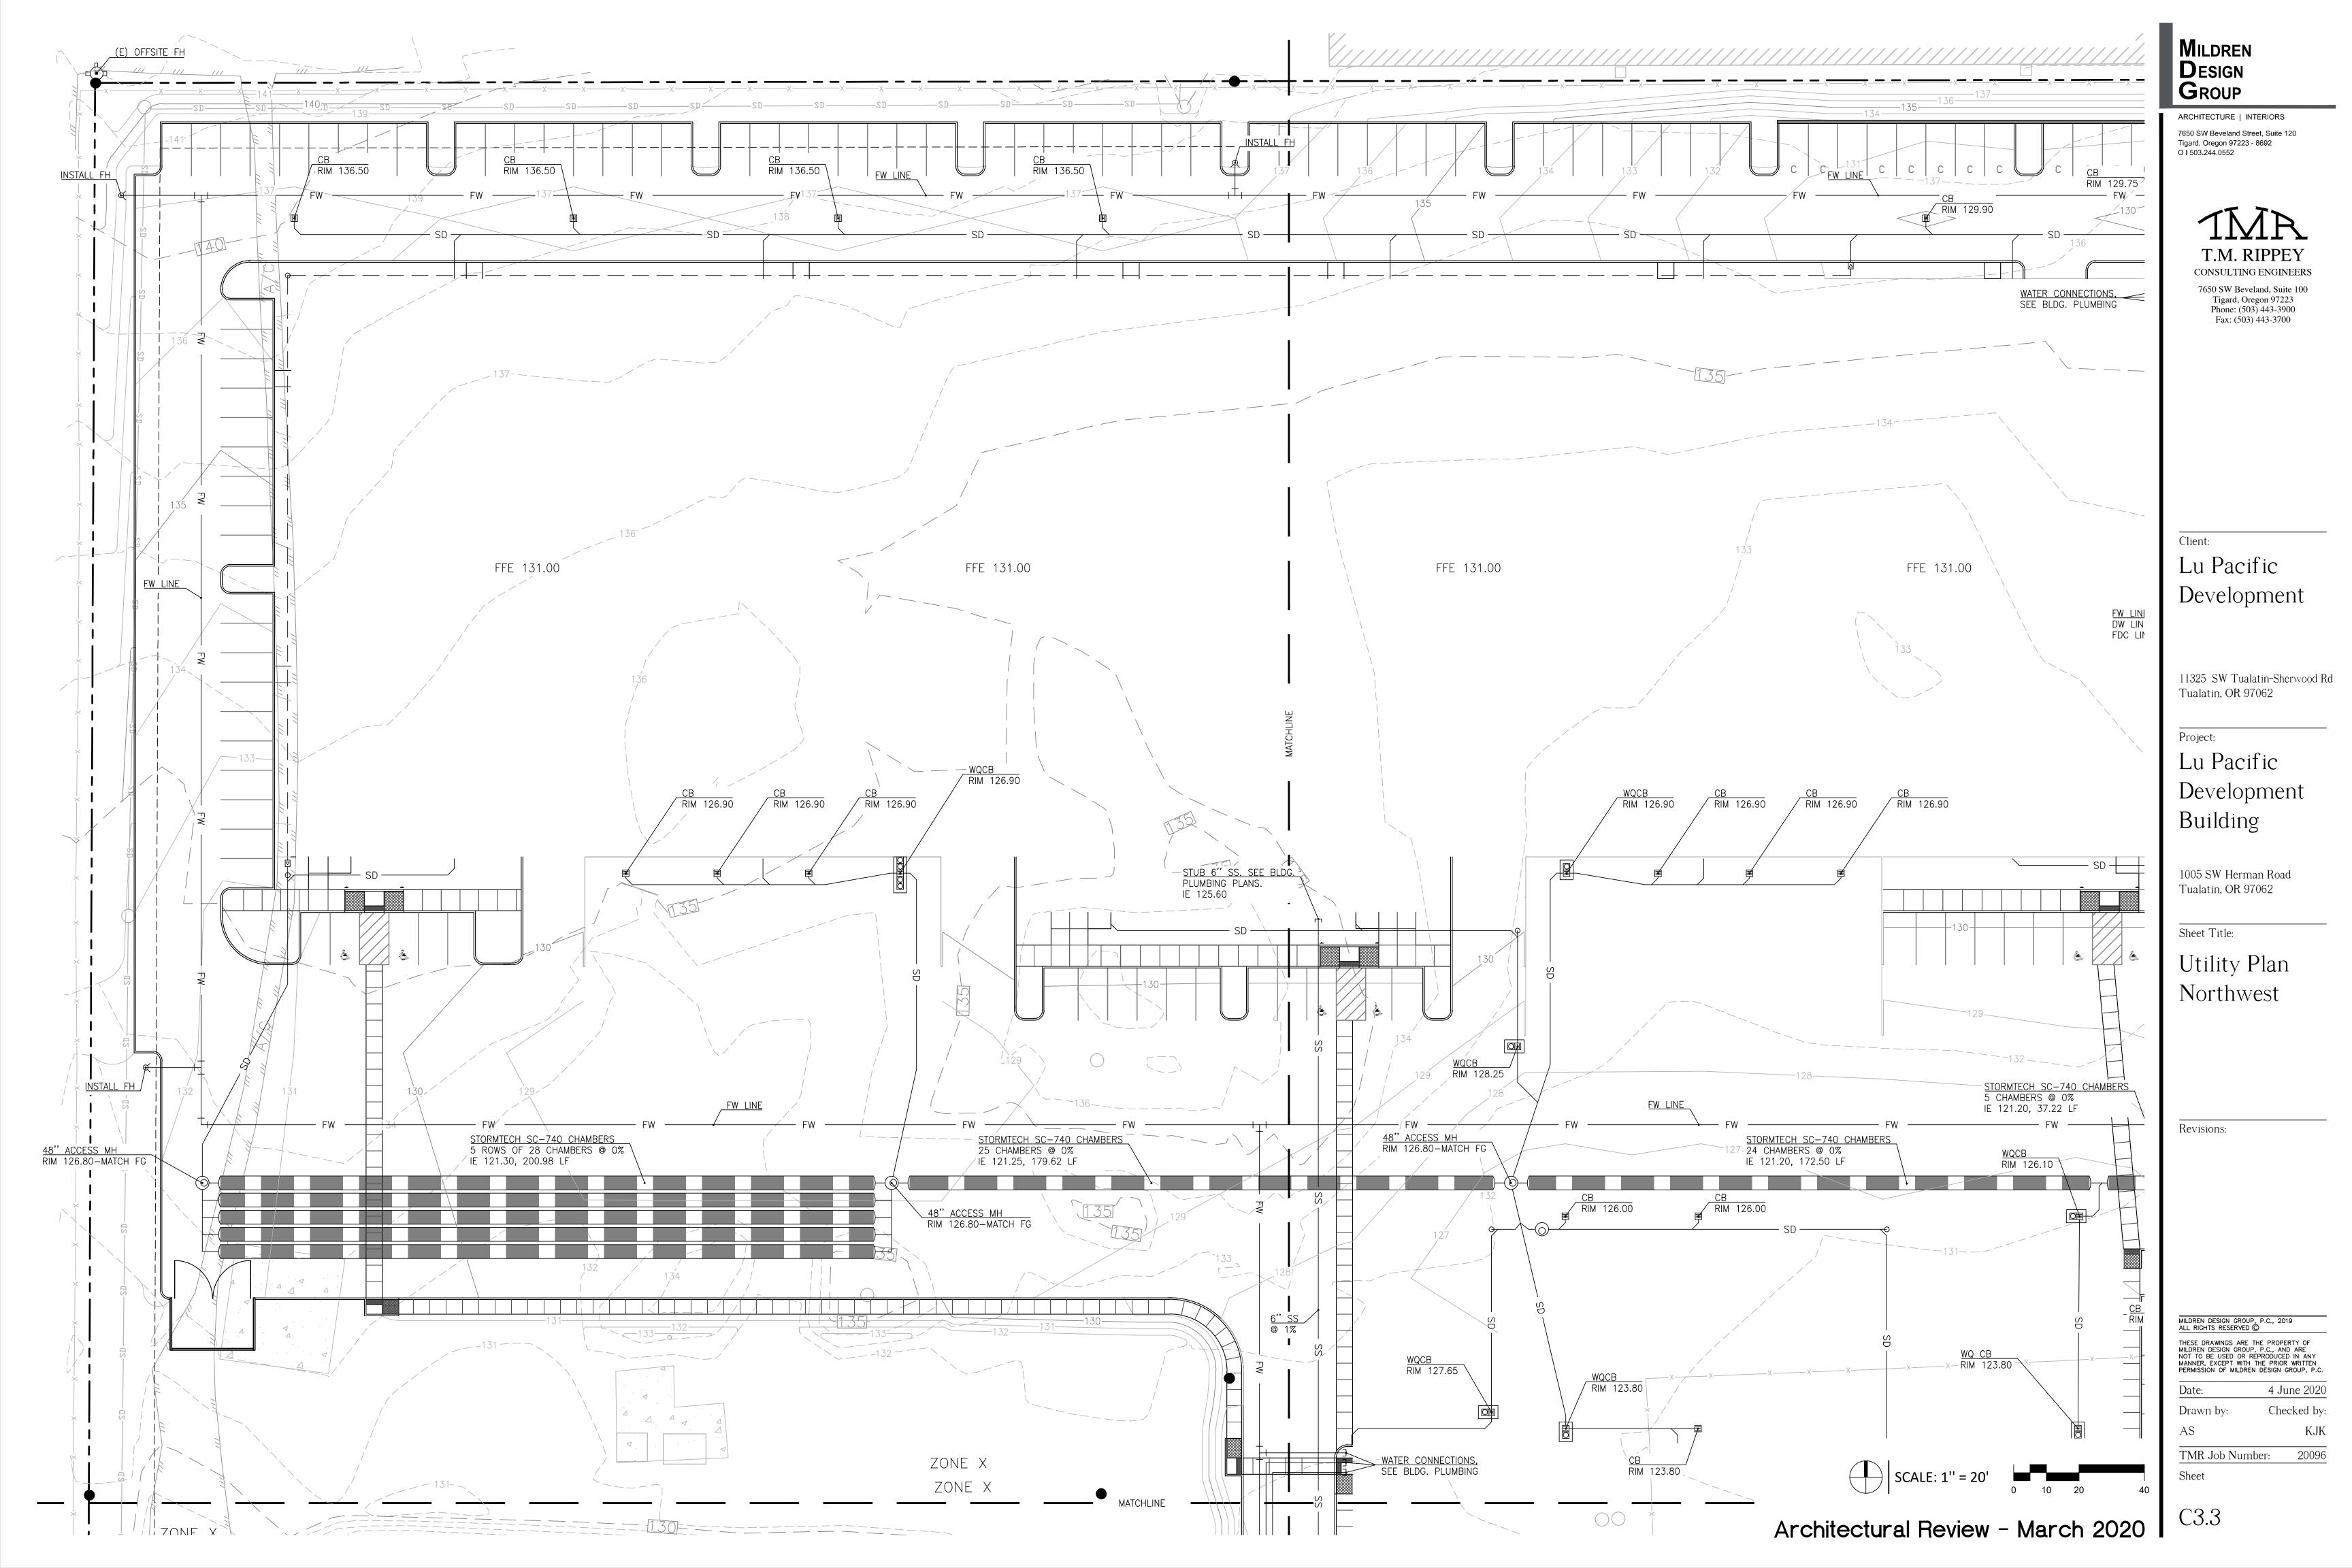

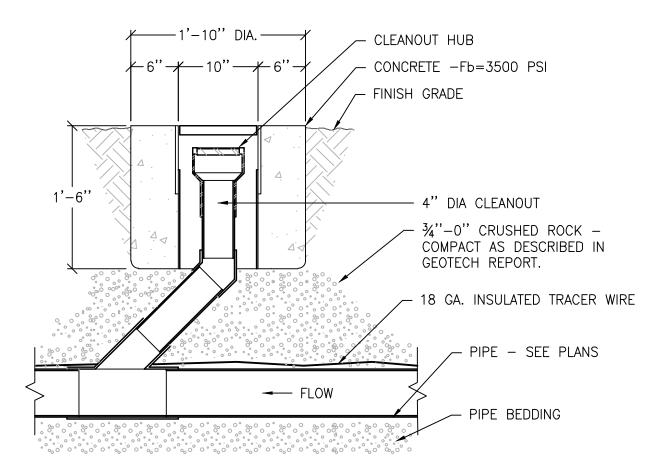

TYPICAL CLEANOUT DETAIL


-METAL GRATE - RATED FOR 16,000 LBS. WHEEL LOAD CAST IRON PIPE (H-20). ARCHITECT TO SLEEVE CONNECTOR COORDINATE GRATE STYLE. PROVIDED BY MFR. PIPE SIZE 18" MIN. FOR PVC PIPE — BAFFLE IE AS CALLED USE D.I. PIPE UNTIL -18" BELOW GRADE. └2'-0'' SQUARE OR ROUND SHEET METAL CATCH BASIN - DEPTH AS REQUIRED. COAT WITH ASPHALT EMULSION INSIDE AND OUT. PAN WALL TO BE 10 GA.

CATCH BASIN DETAIL

PAVED AREA ONLY LANDSCAPE AREA ONLY SAWCUT EX. A.C. **EXISTING** SECTION °∘ ° MIN. - APPROVED NATIVE 1.5"-0" CRUSHED -BACKFILL AGGREGATE BACKFILL (COMPACTED) (COMPACTED) PIPE ZONE BEDDING -¾''-0" PIPE BEDDING & PIPE ZONE MATERIAL


PRIOR TO START OF CONSTRÚCTION

TRENCH BACKFILL DETAIL (PRIVATE SIDE ONLY)

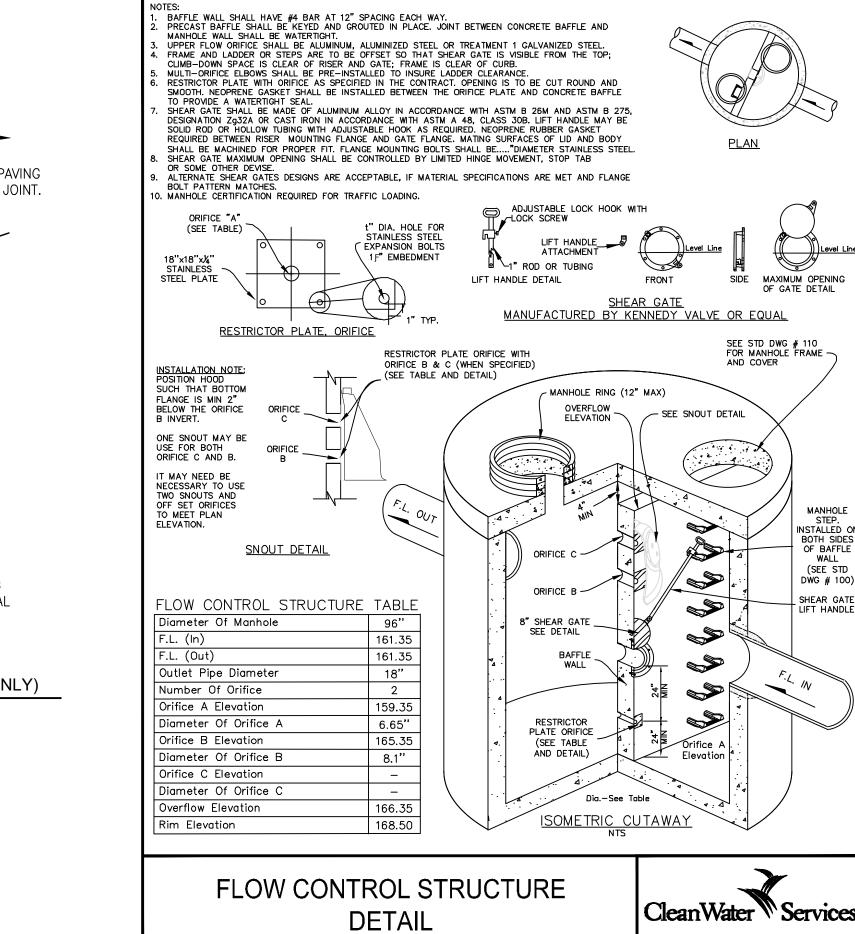

CWS FLOW CONTROL STRUCTURE DETAIL

DRAWING NO. 270

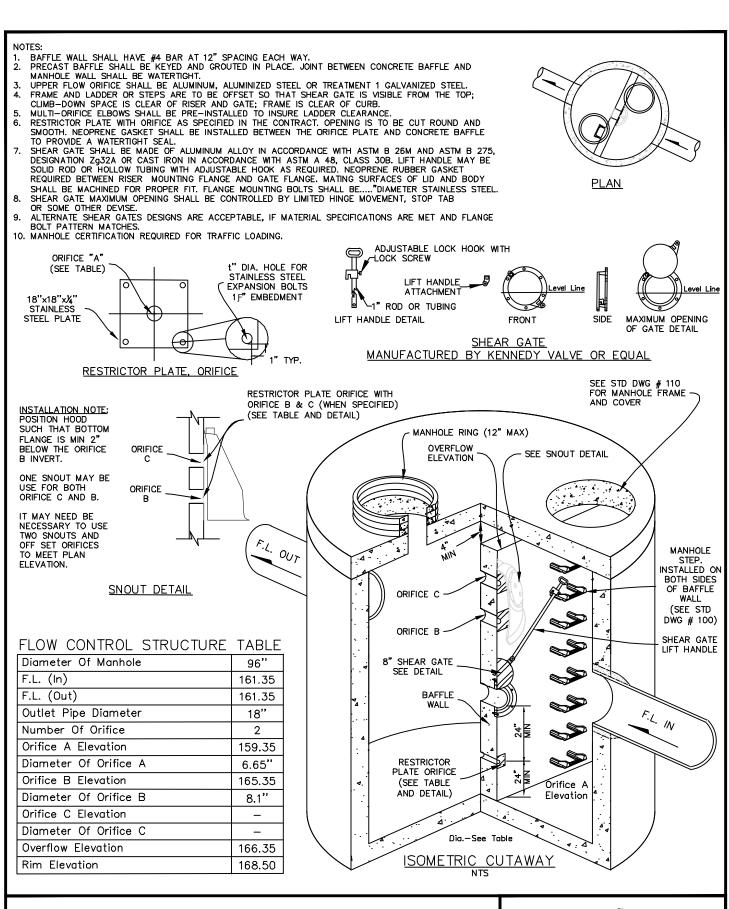

Lu Pacific

Tualatin, OR 97062

Client:

Lu Pacific

Development

11325 SW Tualatin-Sherwood Rd

DESIGN

GROUP

O I 503.244.0552

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T.M. RIPPEY

CONSULTING ENGINEERS

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Tigard, Oregon 97223

Phone: (503) 443-3900

Fax: (503) 443-3700

Development

1005 SW Herman Road Tualatin, OR 97062

Sheet Title:

Details


Revisions:


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Checked by: Drawn by: KJK

TMR Job Number: 20096


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RESURFACING TO MATCH EXISTING PAVING SECTION. SAWCUT AT LOCATION OF JOINT.

NOTE: VERIFY ALL REQUIREMENTS W/ JURISDICTION

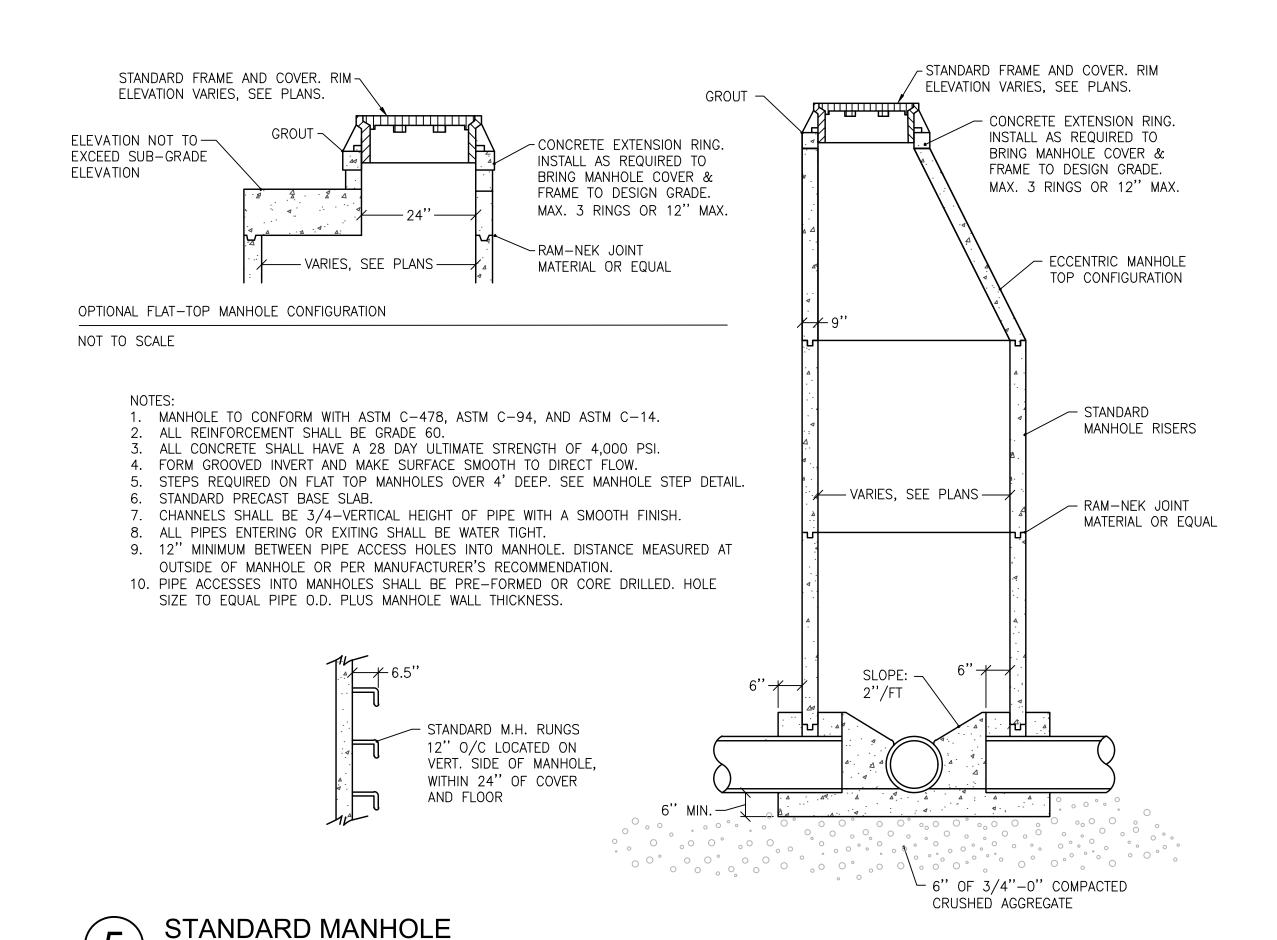

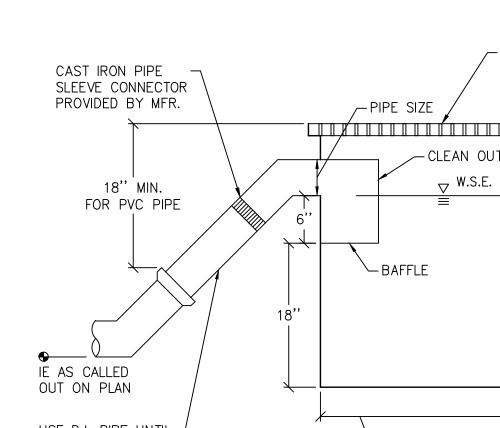
TREE SUMMARY

TREES EXISTING = 48
TREES TO BE REMOVED = 48
TREES TO REMAIN = 0
TREES PROPOSED = 123

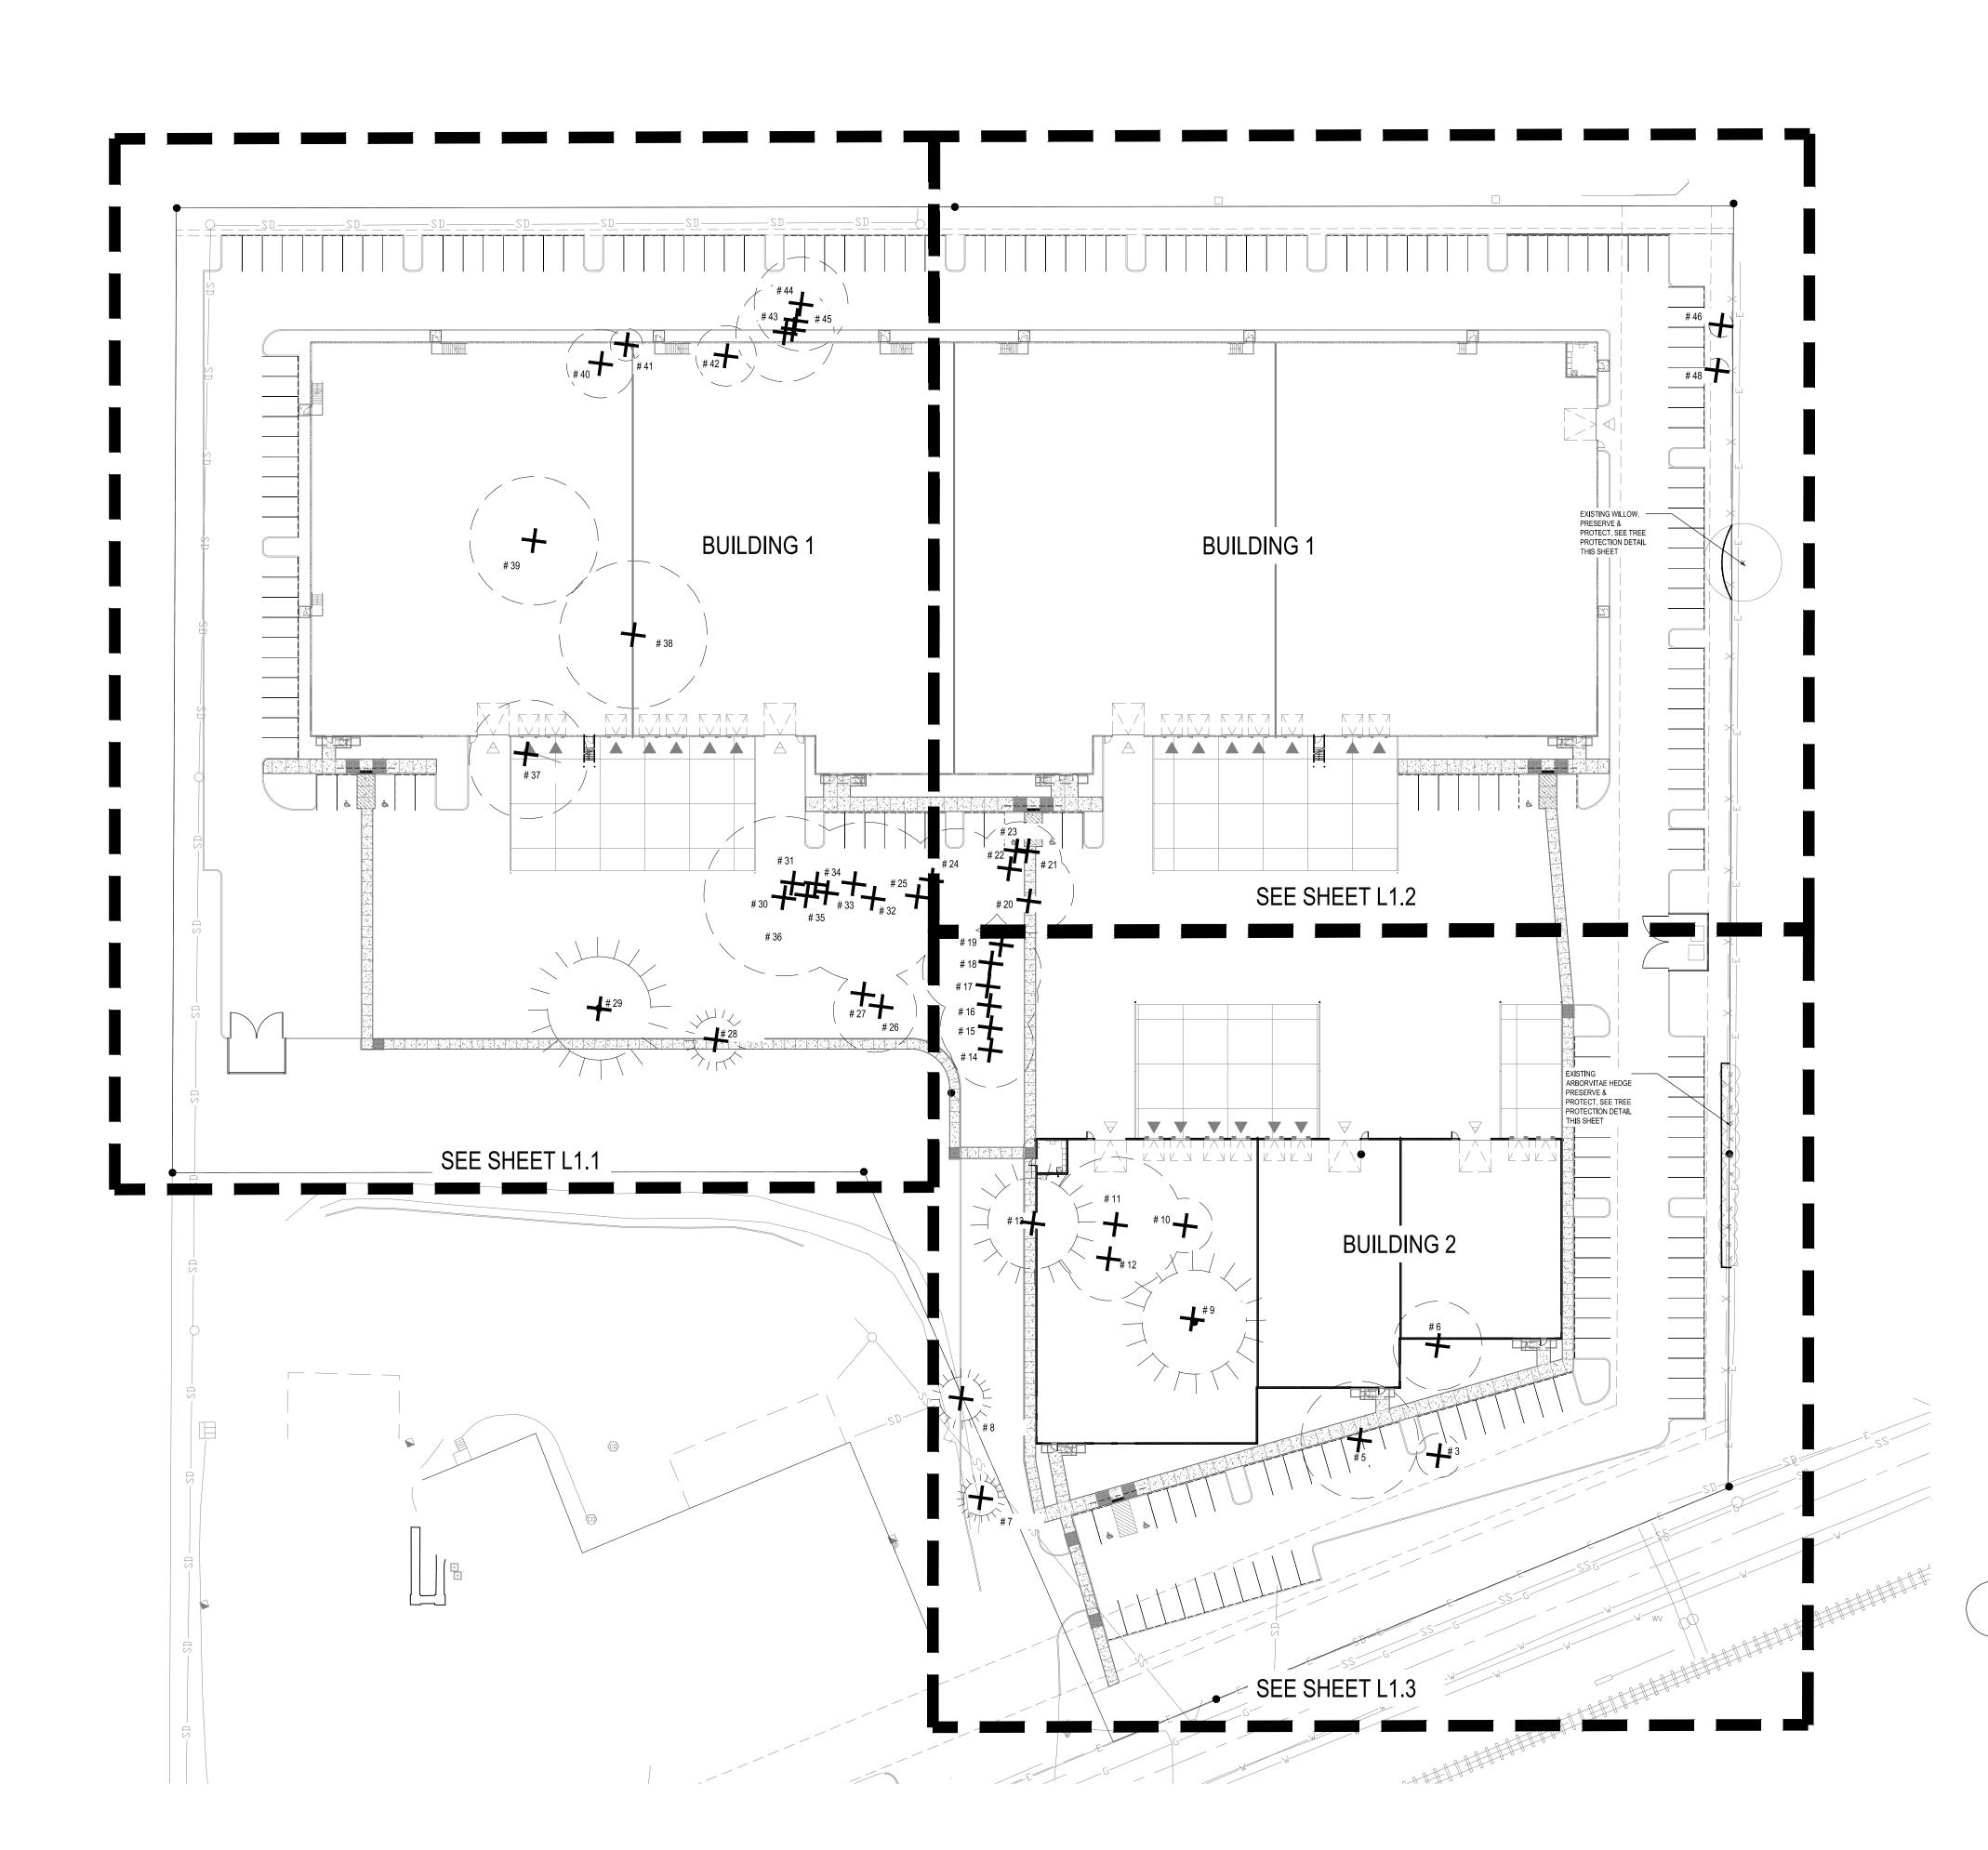TREE NOTES:

- 1. SEE ARBORIST REPORT FOR TREE CONDITION, SIZE, AND SPECIES.
- 2. PLEASE NOTE THERE IS NOT A TREE # 1, 2, 4, AND 47.

LEGEND

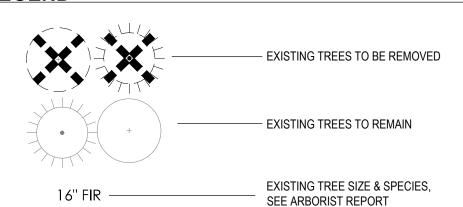

TREE PROTECTION FENCE


TREE PROTECTION FENCE

TREE PROTECTION NOTES:

- 1. BEFORE WORK IS STARTED, INSTALL TREE PROTECTION FENCING. CONTACT THE PROJECT ARBORIST FOR ASSISTANCE.
- 2. REFER TO SECTION 34.200 TREE REMOVAL, 34.270 TREE PROTECTION DURING CONSTRUCTION & 73.250 TREE PRESERVATION OF THE TUALATIN CITY CODE.
- 3. NO ENCROACHMENT OF ANY KIND IS ALLOWED WITHIN THE TREE PROTECTION FENCE ZONE DURING CONSTRUCTION.
- 4. INSTALL FENCE ON TREE SIDE OF EXISTING CURB FOR ALL TREES TO BE PRESERVED.
 ROOT PROTECTION ZONE IS AN AREA AROUND A TREE THAT IS BASED ON THE
 DIAMETER OF THE TREE CANOPY AND BETWEEN EXISTING CURB AND PROPOSED
 SIDEWALK
- 5. FENCING SHALL BE 6-FOOT HIGH METAL FENCING WITH METAL POSTS AND BE SECURED TO THE GROUND WITH 8-FOOT METAL POSTS. AVOID DRIVING POSTS OR STAKES INTO MAJOR ROOTS.
- 6. FENCE SHALL BE INSTALLED PRIOR TO LAND CLEARING, FILLING OR ANY LAND ALTERATION AND SHALL REMAIN IN PLACE UNTIL AFTER CONSTRUCTION IS COMPLETE.
- 7. NO EXCAVATION OR COMPACTION OF EARTH OR OTHER POTENTIALLY DAMAGING ACTIVITIES ALLOWED WITHIN THE PROTECTION FENCING.
- 8. WORK WITHIN PROTECTION FENCE SHALL BE DONE MANUALLY. NO STOCKPILING OF MATERIALS, VEHICULAR TRAFFIC, OR STORAGE OF EQUIPMENT OR MACHINERY SHALL BE ALLOWED WITHIN THE LIMITS OF THE FENCING.
- 9. WITHIN CLEARING/GRADING LIMITS OR AT THE EDGE OF THE CLEARING/GRADING LIMITS, TREE PROTECTION MAY BE INSTALLED AROUND GROUPS OF TREES.
- 10. DURING WORK, ANY ROOTS GREATER THAN TWO INCHES FOUND DURING EXCAVATION SHALL BE CLEANLY CUT. MULTIPLE ROOT PRUNING EVENTS FOR SINGLE TREES SHALL BE MANAGED & MONITORED BY THE PROJECT ARCHITECT.
- 11. AFTER CONSTRUCTION IS COMPLETE, PROJECT ARCHITECT SHALL VERIFY TREE PROTECTION FENCING CAN BE REMOVED.

ROOT ZONE: UP TO TREE CANOPY DRIP LINE WHERE POSSIBLE. SEE NOTE 5 & PLAN FOR LOCATION METAL POST SEE NOTES 4,5, & 6.



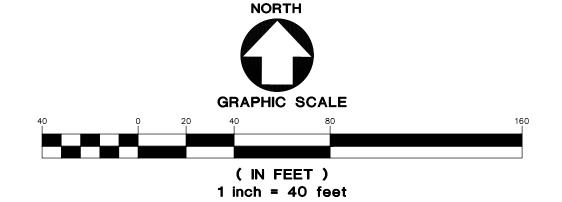

Architectural Review - March 2020

MILDREN DESIGN GROUP

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Lu Pacific Development

11325 SW Tualatin-Sherwood R Tualatin, OR 97062

Project:

Lu Pacific
Development
Building

1005 SW Herman Road Tualatin, OR 97062

Sheet Title:


TREE
REMOVAL &
PROTECTION
PLAN

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LANDSCAPE PLAN

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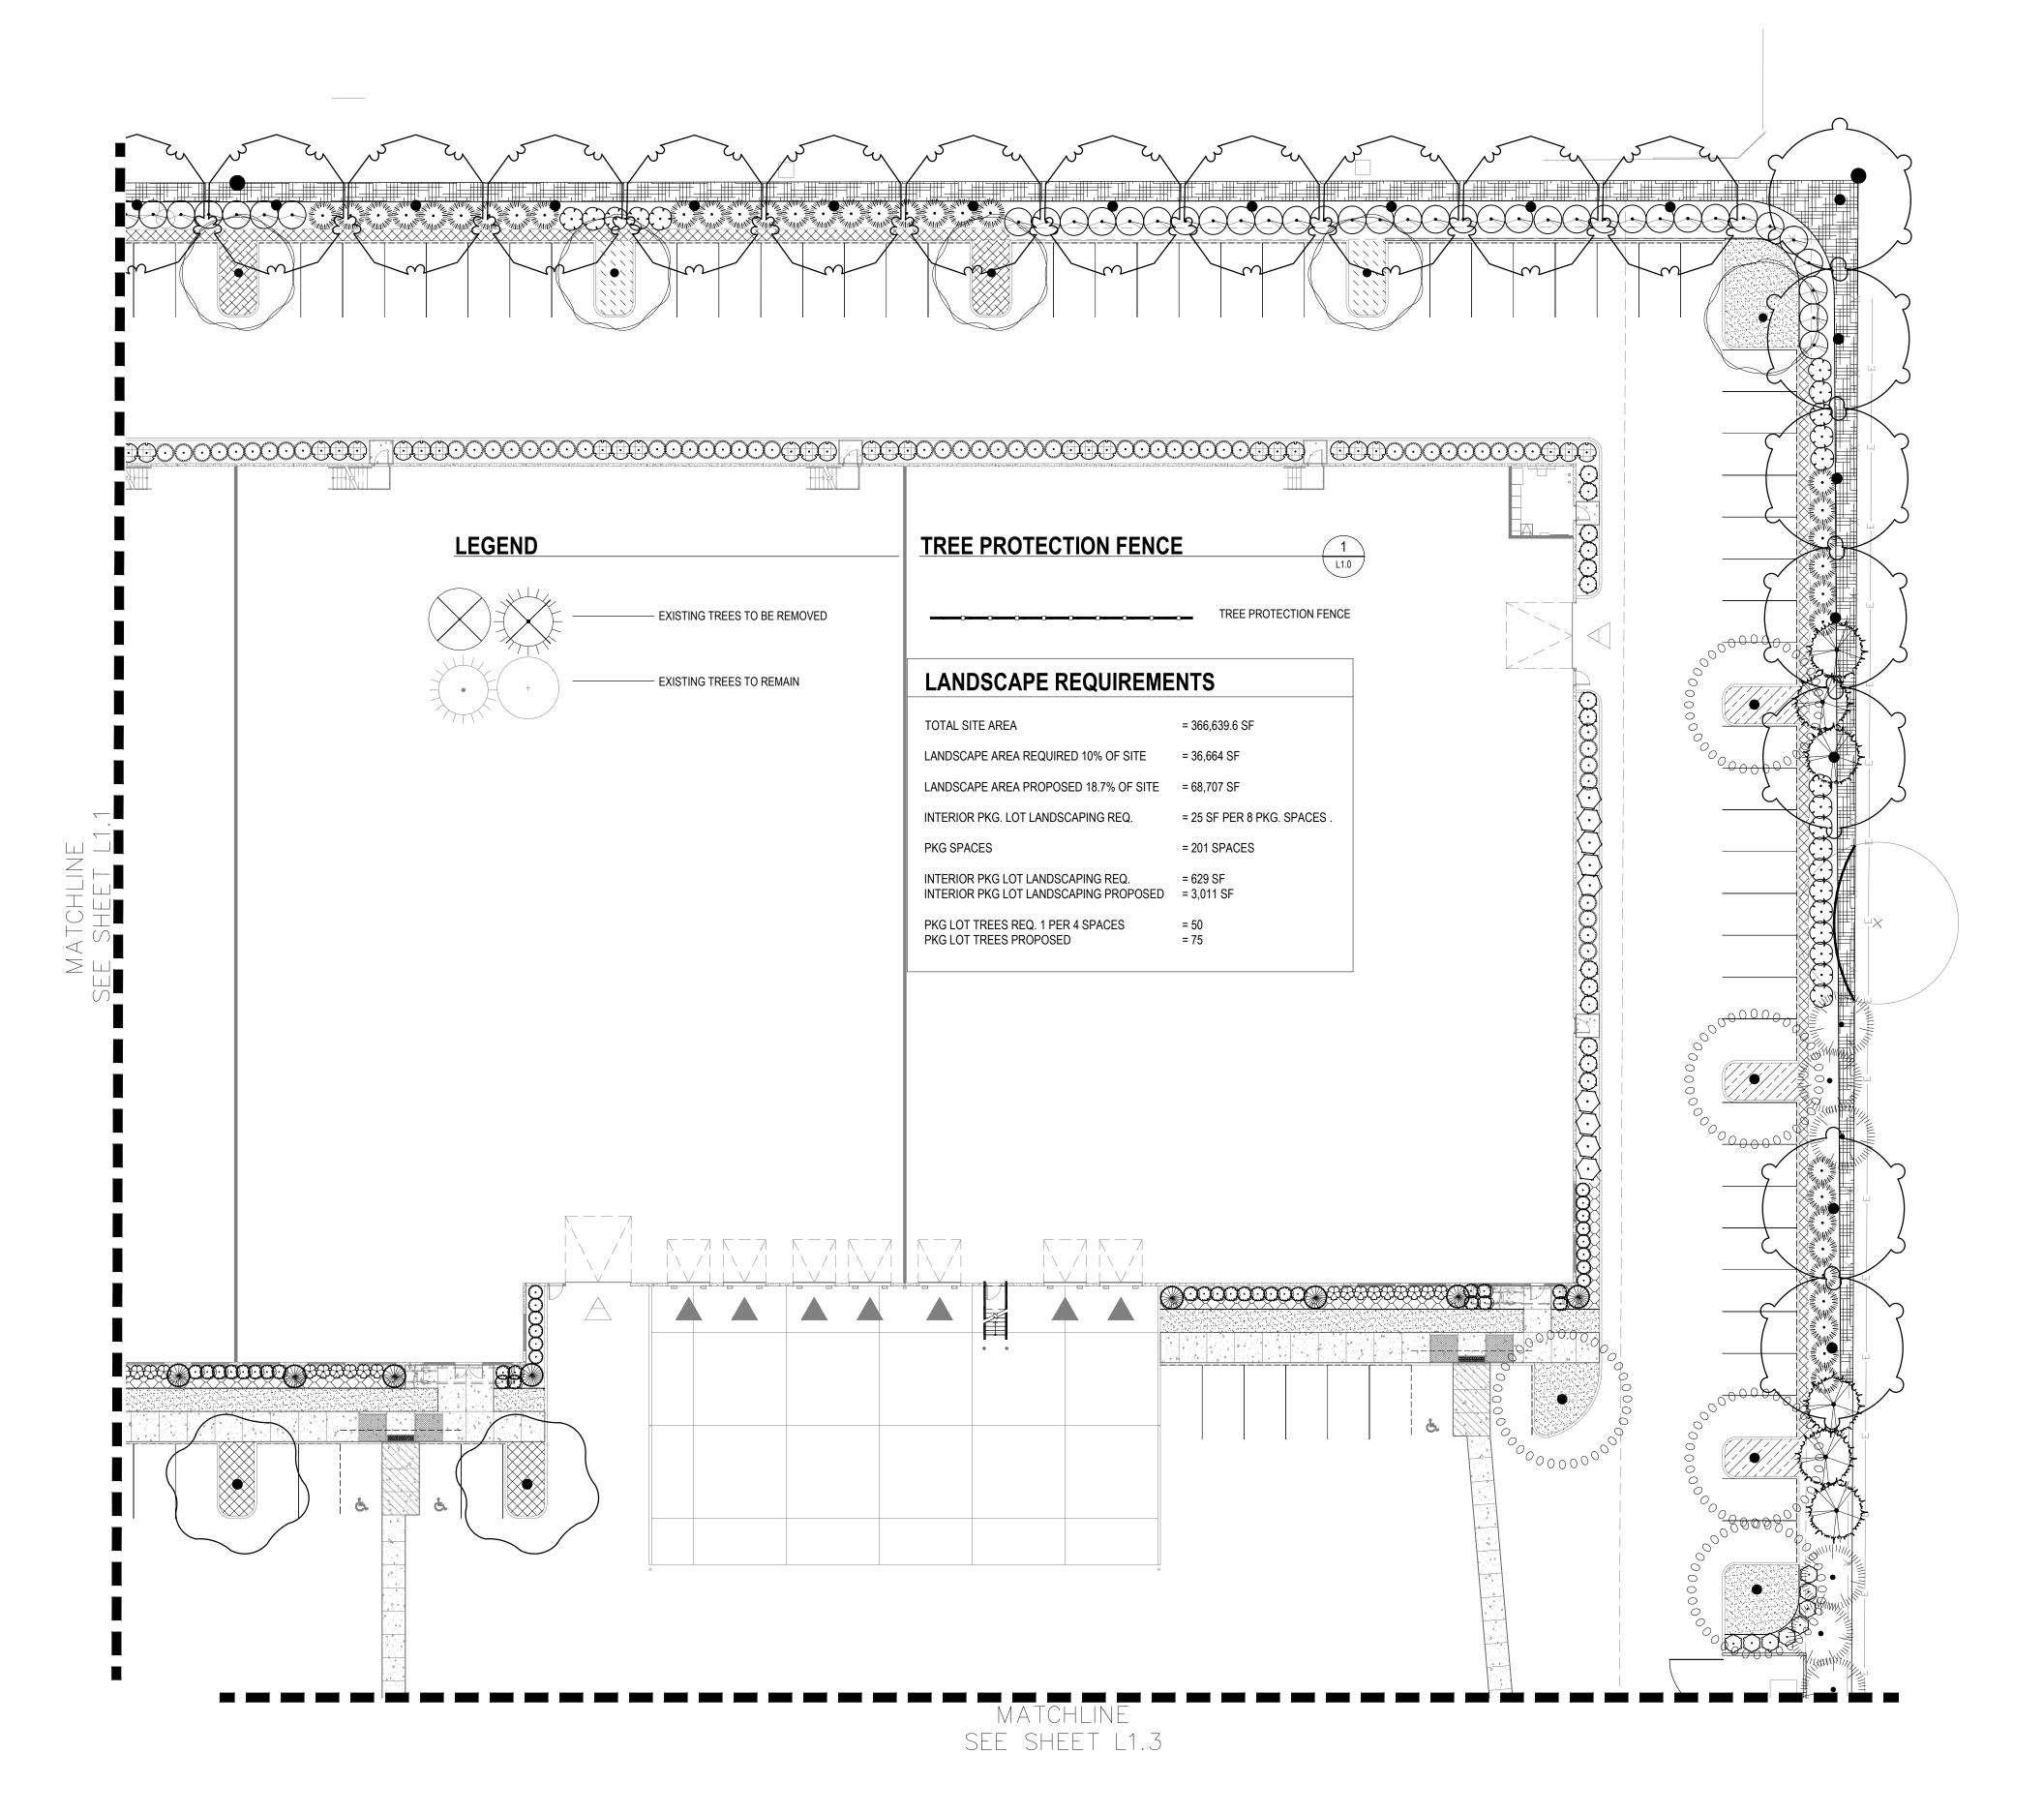
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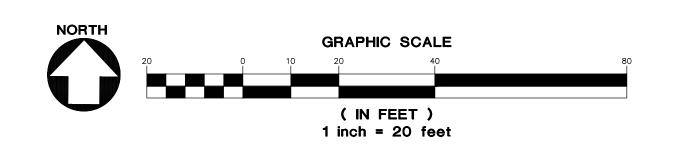
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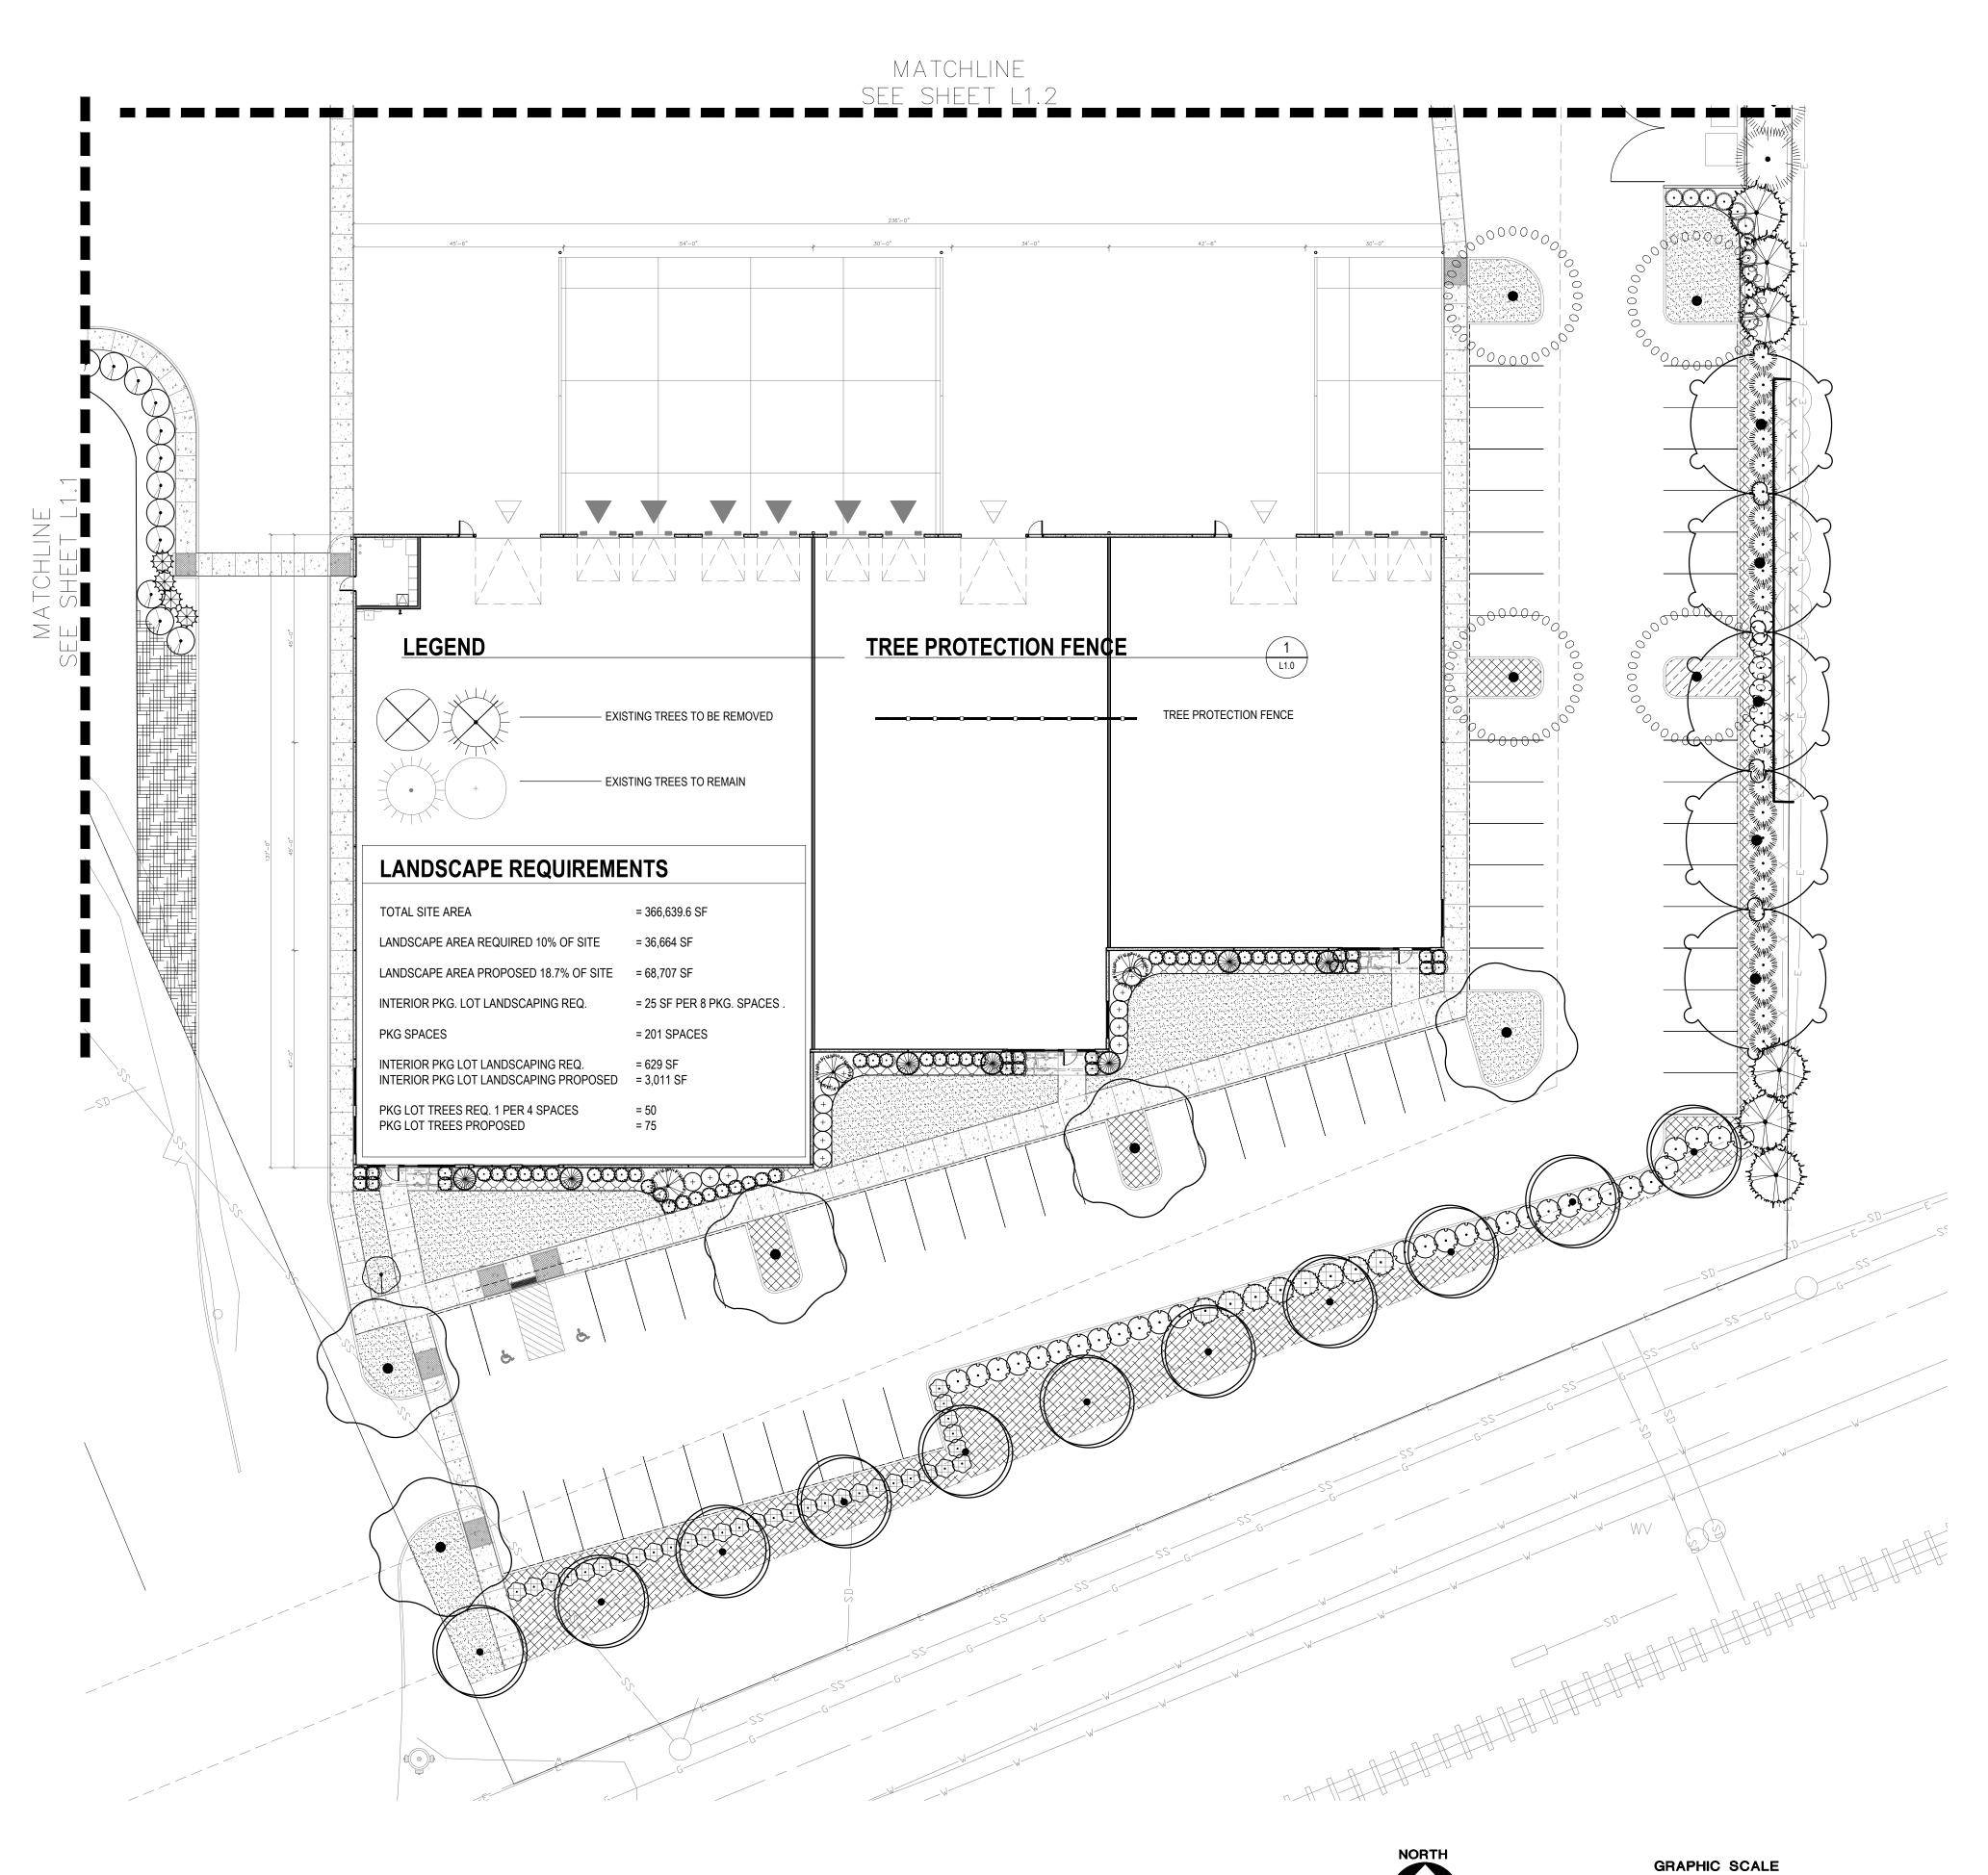
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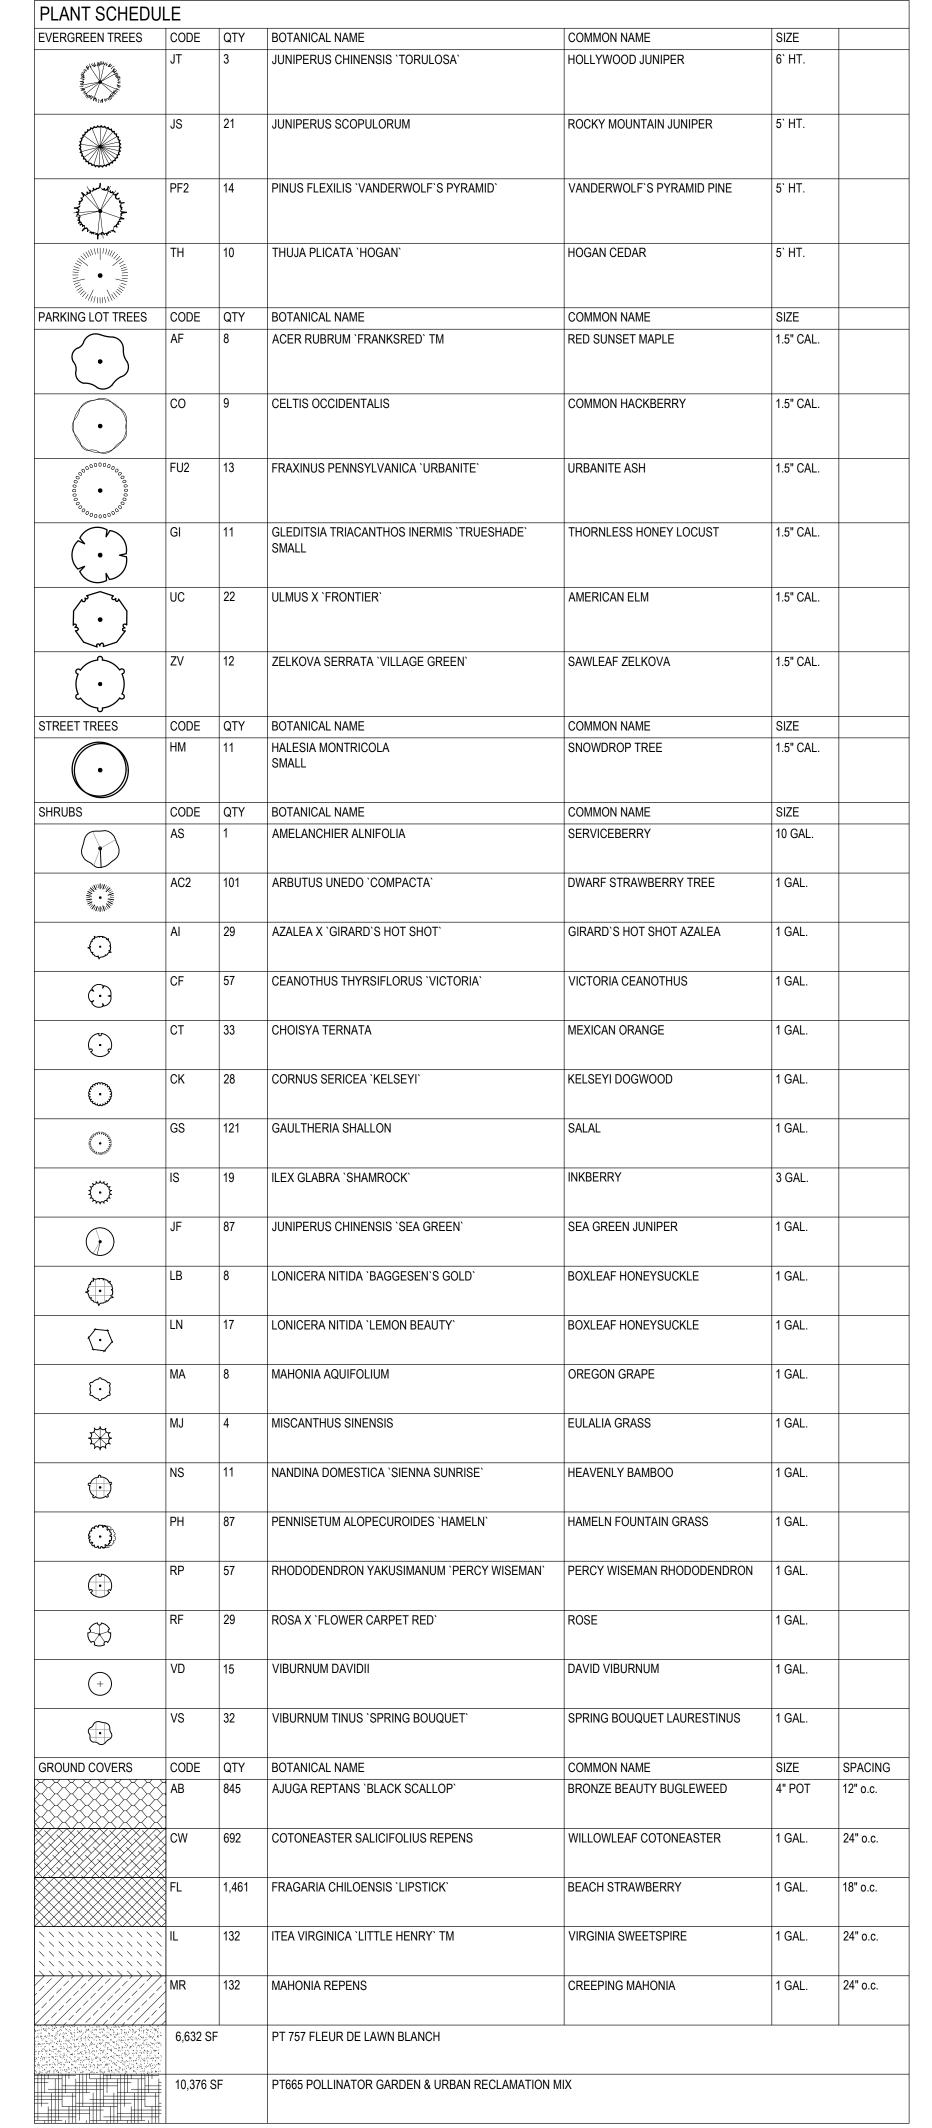
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1 inch = 20 feet



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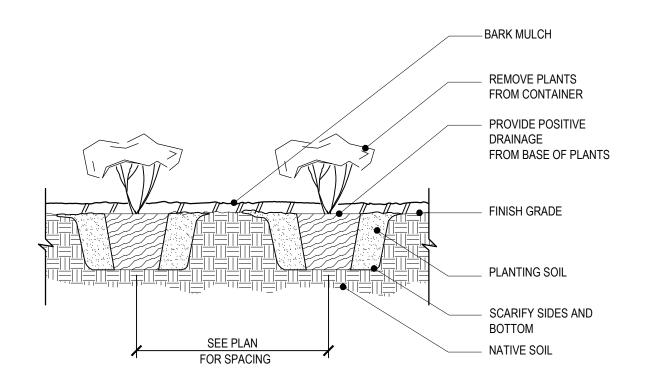
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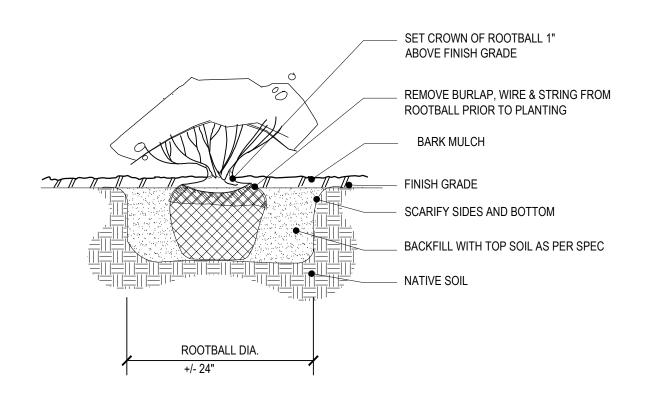
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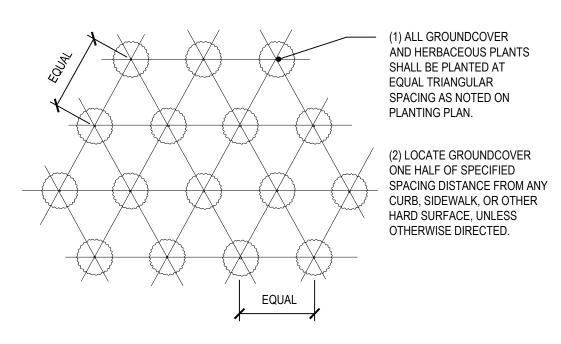


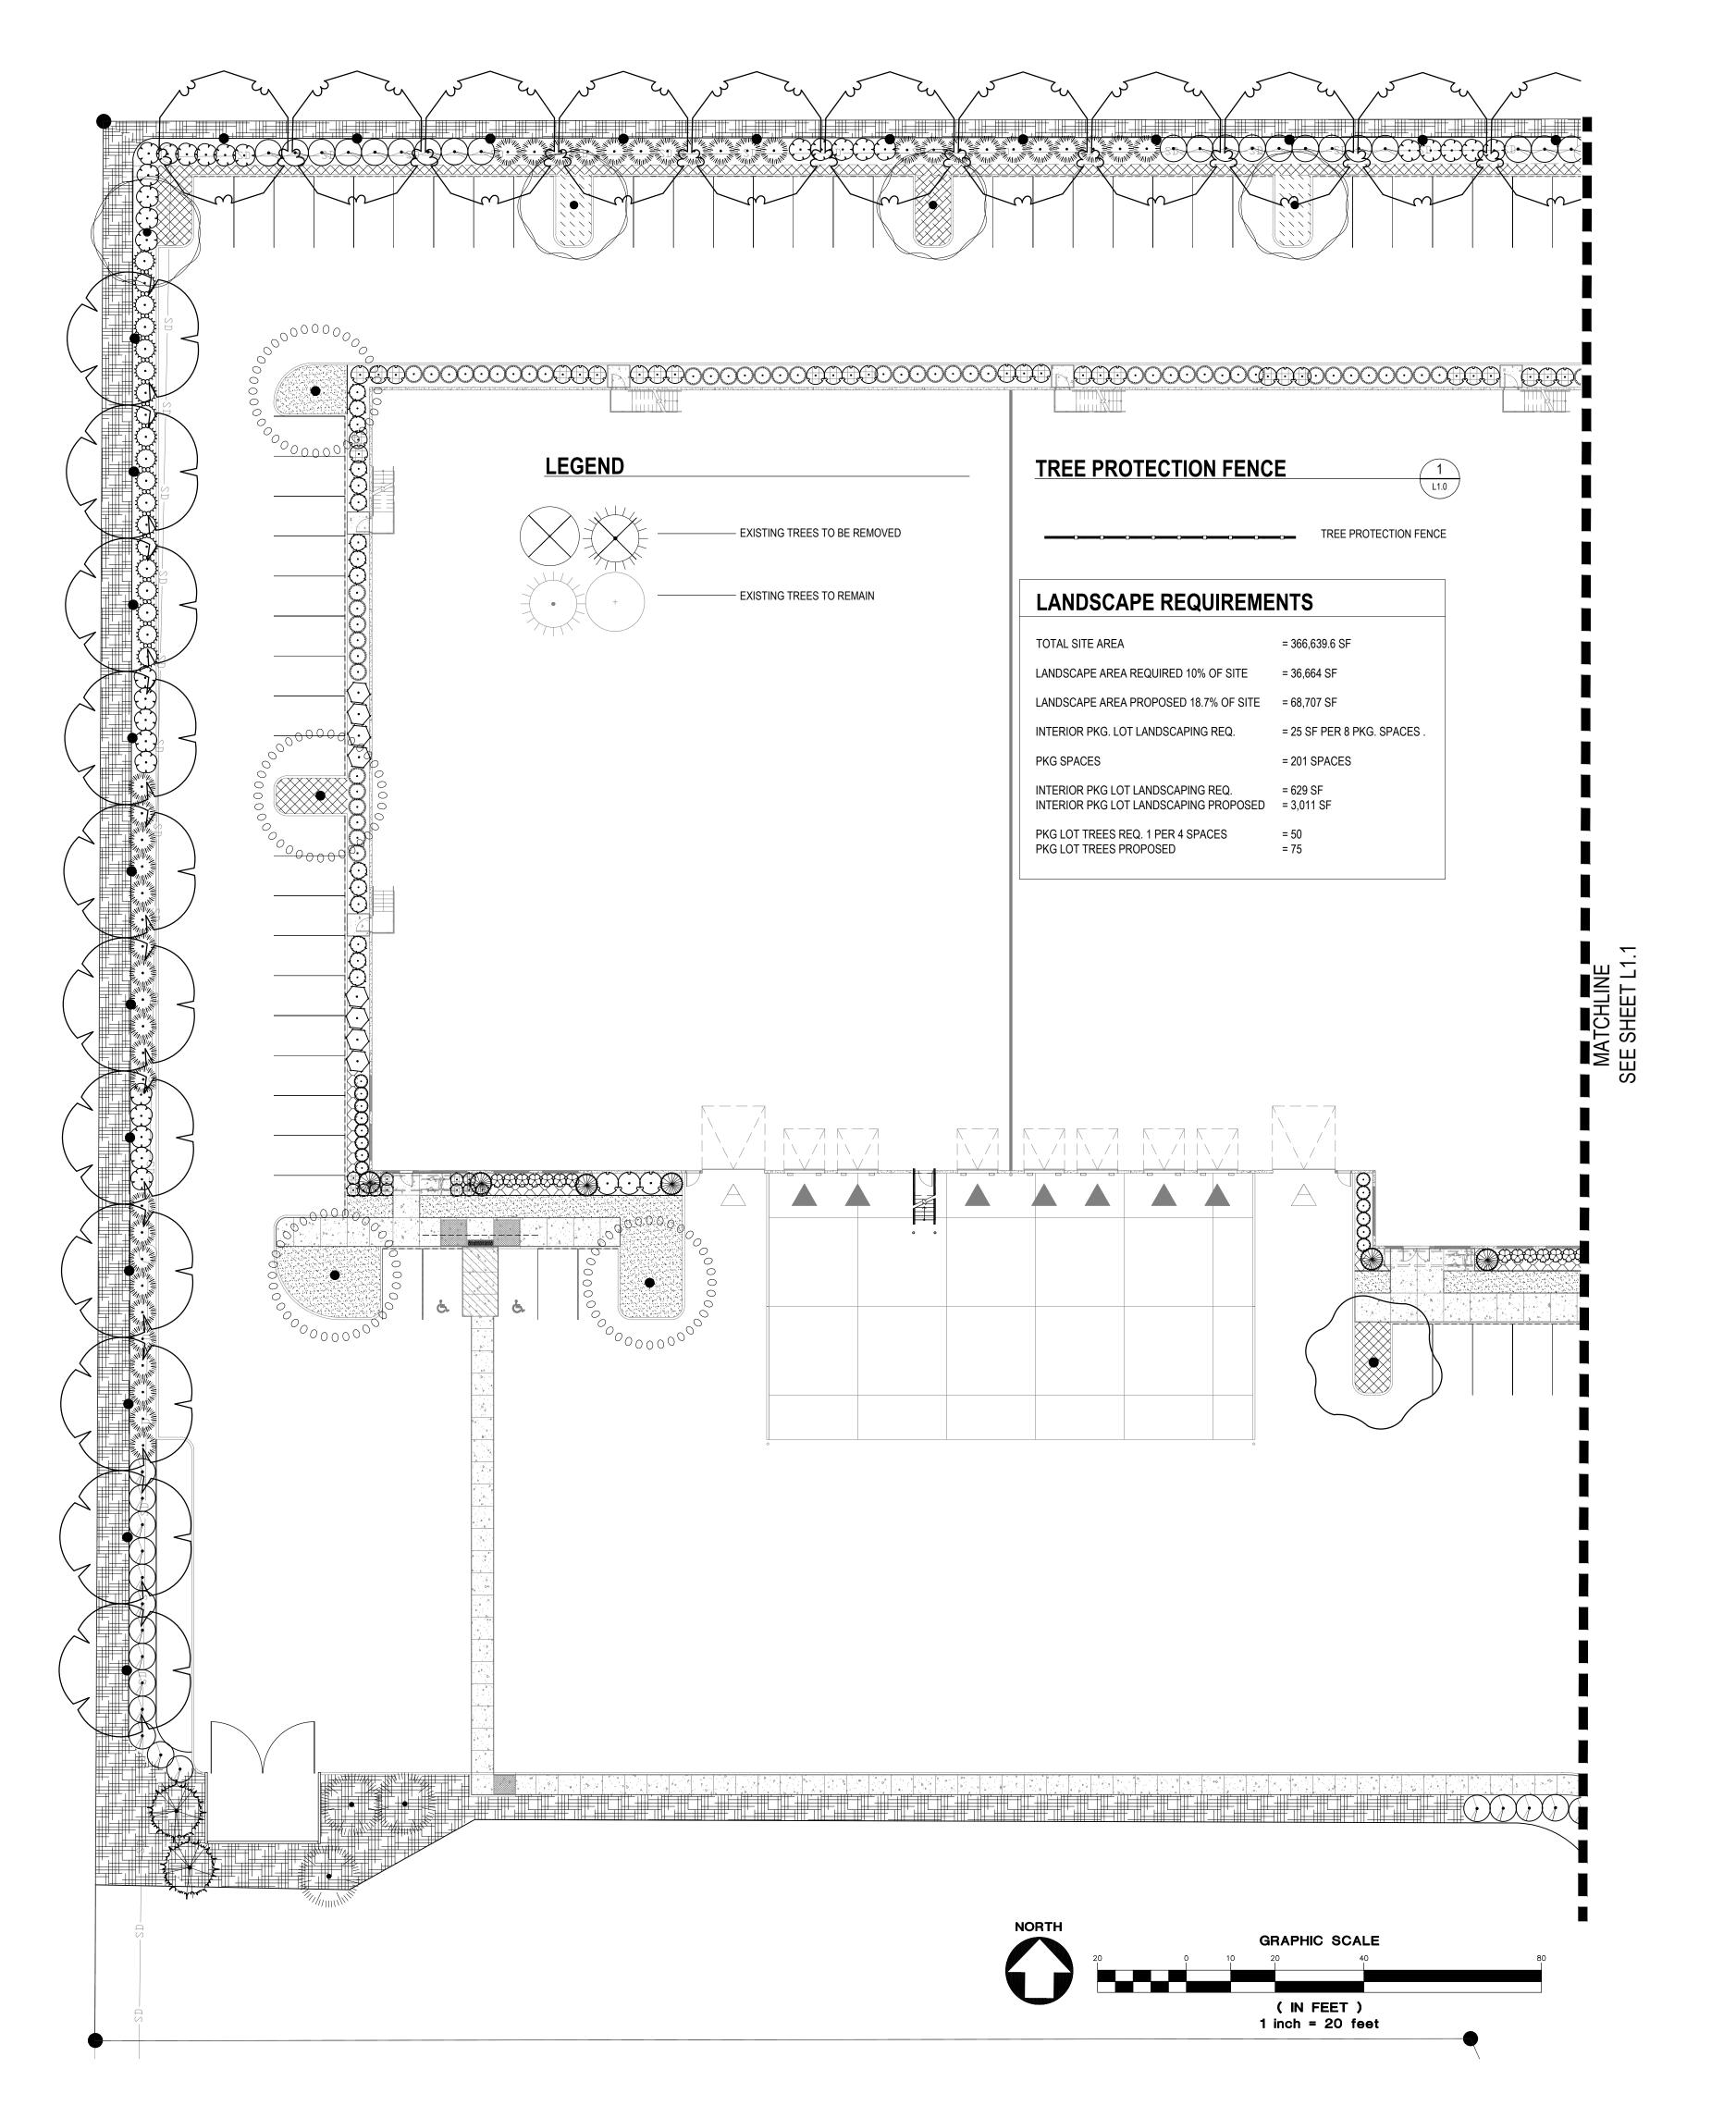1 GROUNDCOVER & HERBACEOUS PLANT PLANTING DETAIL

L2.0 SCALE: NTS




4 SHRUB PLANTING
L2.0 SCALE: NTS




2 GROUNDCOVER & HERBACEOUS PLANT PLANTING PLAN

L2.0 / SCALE: NTS

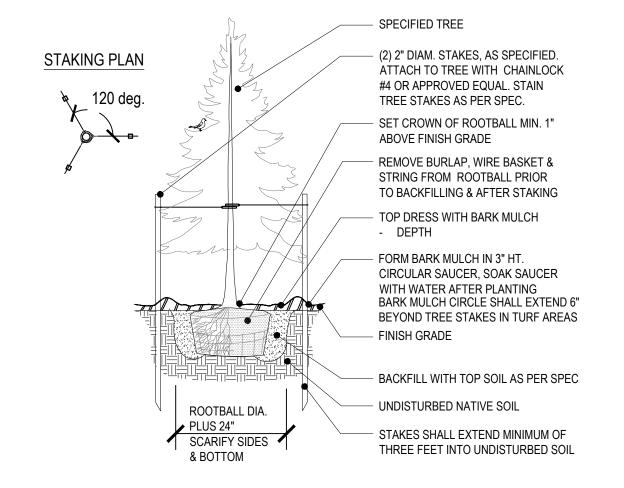

5 CONIFER TREE PLANTING DETAIL

L2.0 / SCALE: NTS

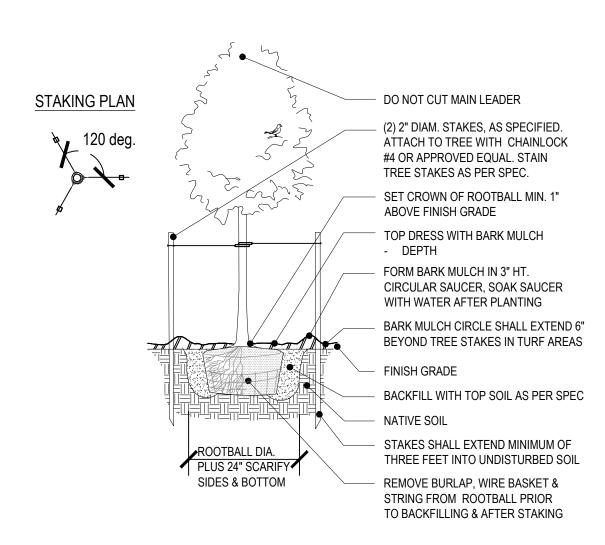

DECIDUOUS TREE PLANTING DETAIL

L2.0 SCALE: NTS

GENERAL NOTES

1. CONTRACTOR SHALL CONTACT LANDSCAPE ARCHITECT AT LEAST TWO WEEKS PRIOR TO START OF LANDSCAPE WORK TO REVIEW PLANT SUBSTITUTIONS & JURISDICTIONAL REQUIREMENTS.

PLANTING NOTES

- 1. ALL CONSTRUCTION SHALL BE PERFORMED IN ACCORDANCE WITH CURRENT CITY OF TUALATIN STANDARDS AND THE OREGON STRUCTURAL SPECIALTY CODE.
- 2. VERIFY ALL EXISTING CONDITIONS, INCLUDING LOCATION OF PROPERTY LINES, PRIOR TO BEGINNING ANY WORK. REPORT ANY DISCREPANCIES TO THE OWNER'S REPRESENTATIVE IMMEDIATELY.
- 3. DO NOT WILLFULLY PROCEED WITH CONSTRUCTION WHEN UNKNOWN OBSTRUCTIONS AND/OR DIFFERENCES EXIST THAT MAY NOT HAVE BEEN KNOWN DURING DESIGN. IMMEDIATELY NOTIFY OWNER'S REPRESENTATIVE OF UNKNOWN OBSTRUCTIONS AND/OR DIFFERENCES. PRIOR TO REMOVING ANY EXISTING FEATURES, REVIEW AND CONFIRM EXTENT OF DEMOLITION WITH OWNER'S REPRESENTATIVE.
- 4. PROTECT EXISTING ITEMS TO REMAIN DURING CONSTRUCTION. ANY DAMAGE TO EXISTING ITEMS DESIGNATED TO REMAIN I.E. CURBS, WALKS, PLANT MATERIAL, LAWN OR FENCES SHALL BE REPAIRED OR REPLACED AT NO ADDITIONAL COST TO THE OWNER.
- 5. VERIFY THE LOCATION OF ALL UNDERGROUND UTILITIES, LINES, PIPES, VAULTS, OR BOXES PRIOR TO EXCAVATION. MARK AND PROTECT ALL UTILITIES, SITE FEATURES AND VEGETATION TO REMAIN IN PLACE. ANY DAMAGE TO ANY KNOWN EXISTING UTILITY ELEMENTS SHALL BE REPAIRED PROPERLY AND IMMEDIATELY.
- 6. REMOVE FROM THE SITE AND LEGALLY DISPOSE OF ALL DEBRIS AND EXCAVATED MATERIAL NOT REQUIRED FOR FILL. NO RUBBISH OR DEBRIS SHALL BE BURIED ON THE SITE.
- 7. MAINTAIN ALL ROADWAYS AND PAVED PATHWAYS CLEAN AND FREE OF CONSTRUCTION MATERIALS AND DEBRIS, PROVIDING NECESSARY DUST CONTROL WHERE REQUIRED.
- 8. COORDINATE AND SCHEDULE ALL WORK WITH THE OWNER'S REPRESENTATIVE.
- 9. INSTALL EROSION CONTROL SYSTEMS IN ACCORDANCE WITH CITY OF TUALATIN STANDARDS PRIOR TO SITE WORK AND LANDSCAPE INSTALLATION.
- 10. CONTRACTOR SHALL PROVIDE TOPSOIL, SOIL AMENDMENTS, AND EROSION CONTROL.
- 11. CONTRACTOR SHALL SUBMIT CERTIFIED TOPSOIL ANALYSIS REPORT FOR OWNER'S APPROVAL PRIOR TO PLANT INSTALLATION. SEE SPECS.
- 12. CONTRACTOR IS RESPONSIBLE FOR ANY AMENDMENTS TO SOIL PH FERTILITY AND/OR DRAINAGE CONDITIONS NECESSARY TO ENSURE PROPER GROWING CONDITIONS FOR PROPOSED PLANTINGS. SEE SPECS.
- 13. CONTRACTOR SHALL FOLLOW PROVIDER'S INSTRUCTIONS AND RECOMMENDATIONS FOR SEEDING.
- 14. ALL PLANTS SHALL BE INSTALLED ACCORDING TO AMERICAN STANDARD FOR NURSERY STOCK (ANSI Z60.1) AS WELL AS DETAIL DRAWINGS AND SPECIFICATIONS.
- 15. ALL PLANTS SHALL BE IRRIGATED BY A FULLY AUTOMATED, PERMANENT IRRIGATION SYSTEM UNLESS OTHERWISE NOTED. SEE SPECS.
- 16. CONTRACTOR SHALL INSTALL RAIN SENSORS AS PER MANUFACTURE'S INSTRUCTIONS AND RECOMMENDATIONS. VERIFY THE LOCATION WITH THE OWNER PRIOR TO INSTALLATION.
- 17. CONTRACTOR SHALL DESIGN THE IRRIGATION SYSTEM AND PROVIDE OWNER WITH SHOP DRAWINGS FOR APPROVAL. SEE SPECS.
- 18. PRIOR TO FINAL ACCEPTANCE, CONTRACTOR SHALL PROVIDE OWNER WITH AS-BUILT PLANS OF THE INSTALLATION, COPIES OF ALL OPERATION MANUALS AND WARRANTY DOCUMENTS.
- 19. ALL NEW PLANTS IN LANDSCAPE AREAS SHALL BE WARRANTED FOR A PERIOD OF ONE YEAR FROM THE DATE OF FINAL ACCEPTANCE.

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LANDSCAPE DETAILS & PLANTING NOTES

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Landscape Construction Specifications

General

- 1. Municipal, County, State and Federal laws, regarding uses and regulations governing or relating to any portion of the work depicted on these plans are hereby incorporated into and made part of these specifications, and their provisions shall be carried out by the contractor.
- 2. The Contractor shall verify the locations of all existing utilities, structures, and services before commencing work. The location of utilities, structures, services shown on these plans are approximate only. Any discrepancies between these plans and the actual field conditions shall be reported to the Owner's representative.
- 3. The Contractor shall locate and protect all existing utilities, features and plants on and adjacent to the project site during construction. Contractor shall repair, at his own expense, all damage resulting from his operations or negligence.
- 4. The Contractor shall obtain all necessary valid licenses, permits, and insurance required to perform the work indicated herein before commencing work, and shall be responsible for coordinating work with all parties involved, including jurisdictional
- 5. The Contractor shall use all means necessary to protect the public at all times during the construction process.
- 6. In the event of conflict between pertinent codes, regulations, structural notes, and/or requirements, or the referenced standards of these Specifications, the provisions of the more stringent shall govern.
- 7. Weather Limitations: Soil work shall be performed only when the weather conditions do not detrimentally affect the quality of

Mandatory Site Inspection Schedule

1. Schedule for Mandatory site inspection procedures. The mandatory site inspections include but are not limited to the following:

Pre-Construction Site Meeting

Contractor shall be notified a minimum of 48 hours prior to meeting to review site conditions, proposed construction and construction schedule, and review construction specifications prior to commencement of construction operations.

Rough Grading Inspection

Contractor shall notify Owner's Representative a minimum 48 hours prior to request for inspection of rough soil grades. All rough grading operations shall be completed per specifications and prepared for inspection. No topsoil placement or backfilling in areas to be landscaped should occur until written approval by Owner's Representative has been issued.

Open Trench Irrigation Inspection

Contractor shall notify Owner's Representative 24 hours prior to inspection for written approval of irrigation trench depths, piping conditions, and pressure testing. (Refer to Irrigation Specification for inspection procedures)

Plant Material Inspection

Plant material quality and layout inspection and written approval shall occur with 24 hours notice to Owner's Representative prior to installation of any plant material. (Refer to Planting Specification for inspection procedures)

Final Landscape Areas and Irrigation Performance Inspection

Contractor shall notify Owner's Representative 48 hours prior to inspection for approval of landscape and irrigation work. Irrigation operations and coverage shall be inspected. Plant quality and layout shall be inspected. Written approval shall be issued upon inspection approval of specified construction. (Refer to relative specification sections)

Erosion Control

- 1. Provide and maintain positive drainage patterns throughout the construction process, and as directed by the Owner's Representative if weather or construction activity creates drainage conflicts detrimental to construction process or environmental conditions. Comply with jurisdictional requirements.
- 2. Maintain erosion measures throughout the landscaping process. Restore erosion control measures disturbed by landscaping operations. Remove only upon approval of Owner's Representative.

Invasive Weed Control Prior to Construction

1. Verify and identify conditions requiring eradication of invasive weeds and grasses prior to existing soil surface disturbance as directed by Owner's Representative. Stockpiled topsoil shall be treated to eradicate weeds prior to soil ripping and stockpiling. Weed eradication shall include herbicide and non-herbicide methods only administered by a currently licensed applicator. Eradication shall include and is not limited to elimination of the following invasive species from areas to be

Cirsium arvense (Canadian Thistle) Lotus corniculatus (Bird's foot Trefoil Convolvulus spp. (Morning Glory) Lythrium salicaria (Purple Loosestrife) Cytisus scoparus (Scotch Broom) Melilotus spp. (Sweet Clover) Dipsacus sylvestris (Common Teasel) Myriophyllum spicatum (Eurasian Milfoil) Equisetum spp. (Horsetail) Phalaris arundinaceae (Reed Canary Grass) Festuca arundinaceae (Tall Fescue) Rubus discolor (Himalayan Blackberry) Hedera helix (English Ivy) Solanum spp. (Nightshade) Holcus canatus (Velvet Grass) Trifolium spp. (Clovers) Lolium spp. (Rye Grasses)

Rough Grade Inspection

- Conditions and quality of rough grade shall be inspected and approved by Owner's Representative prior to the commencement of specified work in areas to be landscaped. The contractor shall then be responsible for completion of activities specified herein, and defined on the plan.
- 2. In all plant bed areas the sub-grade shall be free of unsuitable material such as stumps, roots, rocks, concrete, asphalt, or metals, for a minimum depth of 24 inches, and in all lawn or seeded areas the sub-grade shall be free of unsuitable material for a minimum depth of 12 inches
- The Owner's Representative, at their discretion, shall direct further rough grading or soil preparation if specified activities have not created a surface satisfactory for further work to commence. Compensation for additional surface work created by conditions unknown at the outset and as directed in writing by the Owner's Representative shall be negotiated at the time of the directive, and prior to the commencement of particular construction activities.

Finish Grading

1. Verify that rough grade in landscape areas is sufficiently below proposed final grade for planting beds and lawn areas to allow for placement of topsoil mix. Refer to grading plans for finish grade references. Verify that grades provide positive drainage at all landscape areas, and slope away from structures at a minimum of 2% slope. Final grades in all landscape areas shall be crowned at center to facilitate proposed drainage.

Installation Of Irrigation Sleeving

1. Sleeving conduit shall be installed at existing and proposed paved areas as per specifications, as directed by the Owner's Representative, or as irrigation installation requirements, prior to preparation for paving construction. Set piping to provide minimum covers of:

18-inch for sleeving beneath walkways;

24-inch for sleeving beneath vehicular traffic or structures.

Mark each end of sleeving with a 2 x 4 stake with 24" exposed, clearly marked 'SLEEVE LOCATION'. Contractor shall maintain staking identification and location throughout construction process. Protect all existing paving when installing sleeving. Restore all paving damaged by sleeve installation

- 2. Size of sleeving conduit pipe shall be a minimum of two times the diameter of the bell end of the pipe that is to be fed into the sleeve.
- 3. Set sleeving in a compacted bed of material that will not damage the pipe during compaction of surface backfill

Design / Build Irrigation Specification

1.1 DESIGN BUILD SUBMITTALS AND REQUIREMENTS

- A. Design Criteria: Submitted plan shall meet the following criteria and shall be approved for construction only upon verification that all required criteria have been met.
- 1. Drawings submitted for design approval:
- a. Must clearly illustrate irrigation heads, dripline, valve, controller and point of connection locations. Individual valves and controllers shall be numbered sequentially. The size and
- maximum flow through each valve and capacity of each controller shall be clearly noted. b. Must clearly illustrate pipe sizes from all laterals and mainline pipe.
- c. Drawings must be to a standard measurable engineering scale that is at a minimum of 1"=30'-0". d. Drawings must be CAD generated.
- e. Drawings must include a legend that describes all symbols and materials represented on the
- f. Drawings must clearly illustrate that the proposed irrigation system meets all performance criteria described by these specifications.
- g. Must utilize graphics that clearly distinguish between lateral and mainline pipe and sleeves under pavement; dripline; manual or automatic control valves, isolation valves and drain valves;
- irrigation controllers and all other equipment located on the plan. B. Irrigation system as designed and installed shall perform within the tolerances and specification of the
- C. The system shall be fully adjustable to fine-tune the system performance for specific zones. Indicate water pressure and gallonage parameters at available water source on the required submittal. D. Irrigation system shall be designed so that planting beds, sloped banks and lawn zones are on separate
- control valves to facilitate the different water requirements of each area.

F. System shall furnish components to allow operation within manufacturer's specified tolerances for

optimum performance. Undersized components shall not be approved for installation.

- E. System shall be designed to supply manufacturer's specified minimum operating pressure to furthest emitter from water meter. Water flow through piping shall not exceed a velocity of 5 feet per second.
- 5. Upon completion of the irrigation system installation and as a condition of it's acceptance, deliver to the Owner's
- representative the following 'As- built' drawings; Three prints and one reproducible sepia of all changes to the irrigation system including a Controller Zone Reference chart. Instruct owner of system components operation, system winterization, and controller adjustment processes. Instruct owner of precipitation requirements and schedule of anticipated controller adjustments as landscape matures.
- 6. Protect existing buildings, walls, pavements, reference points, monuments, and markers on this site. Verify location of and protect all utilities. Protect adjacent property. Protect work and materials of other trades. Protect irrigation system materials before, during, and after installation. In the event of damage, repair or replace items as necessary to the approval of the Owner's representative and at no additional cost to the Owner. Use all means necessary to protect the public from injury at all times.
- 7. Provide warranty for all installed materials and work for one year beyond the date of final acceptance of the irrigation system installation.
- 8. Verify gallonage, pressure, size, and location of service water line. The Contractor shall guarantee an irrigation system that functions to manufacturer's specifications with the source volume and pressure afforded to site. Make arrangements for water shut-off during construction if necessary, notify owner 24 hours prior to suspension of water service.
- 9. Irrigation trenches shall be a depth to provide a minimum cover of 18 inches for sleeving beneath walkways; 18 inches for all pressurized main lines; 36 inches for sleeving beneath asphalt paving, and 12 inches for all lateral lines. Backfill with clean fill void of material injurious to system components. All sleeving under vehicular traffic to be Class 200 PVC, all other sleeving shall be class 200 PVC Locate top of zone valves a minimum of 6" below finish grade.

10. Combine wire and piping where possible.

11. Contractor shall follow manufacturer's instructions for solvent welding of PVC pipe and fittings to achieve tight and inseparable joints. Utilize single wrap Teflon tape at all threaded joints.

- 12. Install all valves with fittings that facilitate maintenance removal and place valve boxes at location that are easily serviced but not in conspicuous locations. Locate in planting beds wherever possible, away from mower, edger, or de-thatcher operations.
- 13. Contractor shall install one manual drain valve at discharge side of each remote control valve and at all low points in mainline pipe so as to allow for complete drainage of all main lines. Mark with a painted sleeve cover and indicate locations on As-Built drawings.
- 14. Contractor shall provide backflow prevention as required per local and state codes, installed as per manufacturer's specifications.
- 15. Contractor shall install irrigation controller in accordance with manufacturer's specifications. Verify a 120 V.A.C. electrical source and a min. 1 1/2" conduit from controller location open to all electrical zone valves in field. Weatherproof any exterior wall penetrations.
- 16. Automatic Controller: Rainbird or Hunter capable of meeting Water Sense EPA Criteria or approved equal. Controller shall have ability for all zones to fully operate and meet both normal and specified low volume system requirements as specified herein, and as required by site conditions. Coordinate location in field with owner's representative.
- 17. Install all wire in accordance with manufacturer's specifications with a minimum of 18 inch looped inside valve box at each remote control valve and at the controller. All splices shall occur within valve boxes with water-proof connectors.
- 18. Contractor shall install all sprinkler heads with flexible risers, using flexible polyethylene pipe not to exceed 18 inches in length or PVC swing joints. Tee fittings shall extend horizontally from pipe.
- 19. Contractor shall thoroughly flush irrigation system after piping, risers, and valves are installed but prior to installing sprinkler heads. Thoroughly clean, adjust and balance the installed irrigation system. Adjust spray pattern of nozzles to minimize throw of water onto buildings, walls, roads and parking lots. Adjust controller for optimum performance and precipitation rates utilizing proper water conservation measures.

Topsoil Placement and Soil Preparation

- 1. Contractor shall submit certified topsoil analysis report for owner's approval prior to plant installation.
- 2. Contractor is responsible for any amendments to soil PH, fertility and/or drainage conditions necessary to ensure proper growing conditions for proposed planting.
- 3. Topsoil shall be friable soil from existing stockpiled material or imported, with added soil amendments as specified. It shall not be delivered while in a frozen or muddy condition. Protect from erosion at all times. Utilize existing stockpiled topsoil only under the direction of the Owner's Representative. Do not place topsoil in areas that have not been cleared of weeds listed herein. Topsoil shall meet the following requirements:
 - a. Free of roots and rocks larger than 1/2 inch,
 - b. Free of subsoil, debris, large weeds, foreign matter and any other material deleterious to plant
 - c. Acidity range (pH) of 5.5 to 7.5.
- d. Containing a minimum of 4 percent and a maximum of 25 percent inorganic matter with decaying matter of 25 percent content by volume or less.
- e. Textural gradations shall be sand: 45-75%, silt: 15-35%, clay: 05-20%.
- 4. Commercial fertilizer shall be an organic base, complete fertilizer containing in available form by within a minimum of 10N 10P 5K - with 50 percent of the available nitrogen in slow-release formula, Webfoot Organic Delux, or approved equal.a
- 5. Compost shall be yard debris compost meeting industry and jurisdictional standards.
- 6. Contractor shall remove all debris, rocks one inch in diameter or larger, sticks, mortar, concrete, asphalt, paper, contaminated soil and any material harmful to plant life, in all planting areas.
- 7. Contractor shall rototill subgrade six (6) inches deep before placing topsoil. Specified imported topsoil shall be placed at a minimum depth of **12"** in all planting areas. Do not place material during wet conditions. Do not work saturated soils in any manner. floated to a level, sloped or mounded grade between any existing or constructed point on the site, such as curbs, walls, walks, paving and the like. Final soil grades in planting beds shall be 2" below adjacent paving and curbs for mulch application.
- 8. Distribute following soil amendments to all landscape areas in even layers and power rototill or spade to a minimum depth of six (6) inches into topsoil, as follows;

Planting Beds:

- a. Compost: Apply nine cubic yards per 1000 sq. ft. b. Commercial Fertilizer: Apply 50 pounds per 1000 sq. ft.
- 9. Preparation of backfill planting soil mix shall be as follows:
- Three cubic yards topsoil
- 1 1/2 cubic yards compost - 1 1/2 cubic yards medium bark,
- 10 pounds commercial fertilizer
- Five pounds bonemeal
- 10. Keep project free from accumulation of debris, topsoil and other material. At completion of each area of work, remove debris, equipment and surplus materials. Any paved area or surfaces stained or soiled from landscaping materials shall be cleaned with a power sweeper using water under pressure. Building surfaces shall be washed with proper equipment and materials as approved by the Owner's representative.

Thoroughly blend and mix the following proportion of materials while in a moist condition:

Seed Installation

- 1. Seeding operations shall occur only between March 15 and October 15.
- 2. Seeding is not permitted during cold weather (less than 32 degrees F), hot weather (greater than 80 degrees F), when soil temperature is less than 55 degrees F, when ground is saturated, or when wind velocity is greater than 10
- 3. Contractor shall float rough graded seedbed. Do not disturb natural drainage patterns. Remove rocks, clumps, or debris at surface. Lightly scarify surface.
- 4. Contractor shall apply 10 pounds commercial fertilizer per 1,000 square feet of surface area before spreading seed.
- 5. Lawn Seed: Contractor shall manually broadcast or hydro-seed eight pounds of Sunmark "Northwest Supreme Lawn Mix" grass seed per 1,000 square feet.
- 6. Fieldgrass Seed: Contractor shall manually broadcast or hydro-seed eight pounds of Sunmark "Diamond Green" grass seed per 1,000 square feet.
- 7. The Contractor shall protect and maintain the seeded area by fencing, watering, feeding, reseeding, moving and repairing as necessary to establish a thick, uniform stand of grass acceptable to the Owner's representative. Contractor to maintain lawn for a minimum of 3 mowings.

Trees, Shrubs, & Groundcover Installation

- 1. Contractor shall guarantee materials and workmanship in general landscape areas for one year from date of conditional acceptance. Plant material shall be in accordance with American Standard for Nursery Stock (ANSI Z60.1), shall comply with State and Federal laws with respect to inspection for insect infestation and plant diseases and shall be free of insect pests and plant diseases.
- 2. Plant materials shall have a minimum of 6 inches of prepared soil under the root ball, and a minimum of 6 inches on each side of the root ball. Tree roots or root ball shall have a minimum of 12 inches of plant soil under the root ball and a minimum of 12 inches on each side of the root ball, or roots. Final grade should maintain root ball slightly above surrounding grade (not to exceed one inch) for bark mulch installation.
- 3. Root control barrier shall be installed in trenches, alongside hardscape structures and utility lines such as sidewalks, curbs, pavement, walls, and concrete located within 5 feet of new trees measured from the trunk. Root barrier is to be 40 - 60 mil HDPE, minimum 18" deep and extend 10' in either direction measured from the center of the trunk.
- 4. Mulch all planting beds after planting, final raking, grading and leveling of the planting beds with a layer of Hem/Fir medium screened bark mulch as specified on the plans.
- 5. Balled and burlapped trees, boxed trees or bare root trees shall be either guyed or staked as detailed on the plans.
- 6. Remove all dead or dying branches and criss-crossing branches from trees.
- 7. Keep project free from accumulation of debris, topsoil and other material. At completion of each area of work, remove debris, equipment and surplus material. All paved areas or surfaces stained or soiled from landscape material shall be cleaned with a water-pressure power sweeper. Building surfaces shall be washed with proper equipment and materials as approved by the Owner.
- 8. River Rock Mulch: River rock mulch shall be minimum 3/4" to maximum 1-1/2" diameter washed

round river rock, uniform in size. All fines shall be screened from the aggregate within a one-quarter inch (1/4") tolerance. Color shall be white to light brown. Contractor shall provide the owner with samples of river rocks for approval prior to installation.

Maintenance

- 1. Contractor shall maintain general landscape areas for one year after accepted completion of project.
- 2. Maintenance shall include; all grade resettlement, weeding, policing and removal of plant material debris during maintenance period. Remove and replace dead plant material as needed at no cost to owner for maintenance period. Seasonal leaf fall removal is outside the scope of this maintenance specification.
- 3. Any unsatisfactory condition arising during this maintenance period shall be brought to the attention of the Owner's Representative immediately.



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Lu Pacific Development Building

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Sheet Title:

LANDSCAPE & IR SPECS

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117013

Date: 9 March 2020 Checked by Drawn by: TQI

Sheet

Job Number:

Description	Symbol	Avg	Max	Min	Max/Min	Avg/Min
ADA Parking 1	+	3.0 fc	4.5 fc	1.8 fc	2.5:1	1.7:1
ADA Parking 2	+	3.7 fc	5.7 fc	2.2 fc	2.6:1	1.7:1
ADA Parking 3	+	2.8 fc	4.1 fc	1.9 fc	2.2:1	1.5:1
ADA Parking 4	+	1.5 fc	1.9 fc	1.3 fc	1.5:1	1.2:1
MAIN ENTRIES(1)	+	14.2 fc	15.8 fc	9.5 fc	1.7:1	1.5:1
MAIN ENTRIES(2)	+	14.0 fc	16.1 fc	8.6 fc	1.9:1	1.6:1
MAIN ENTRIES(3)	+	13.9 fc	16.0 fc	8.5 fc	1.9:1	1.6:1
MAIN ENTRIES(4)	+	14.6 fc	17.7 fc	8.5 fc	2.1:1	1.7:1
MAIN ENTRIES(5)	+	14.9 fc	18.0 fc	8.7 fc	2.1:1	1.7:1
MAIN ENTRIES(6)	+	14.8 fc	17.8 fc	8.8 fc	2.0:1	1.7:1
MAIN ENTRIES(7)	+	14.6 fc	17.6 fc	8.5 fc	2.1:1	1.7:1
Overall Cita Lighting	1 1	1.0 fo	14 0 fo	0 0 fo	NI/A	NI/A

0.1 fc | 0.5 fc | 0.0 fc | N/A

+ 1.8 fc 8.8 fc 0.0 fc N/A

Property Line Light





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O I 503.244.0552



EXPIRES 12-31-20

Client:

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Development

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Developmen
Building

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Sheet Title:
SITE
LIGHTING
PHOTOMETRIC

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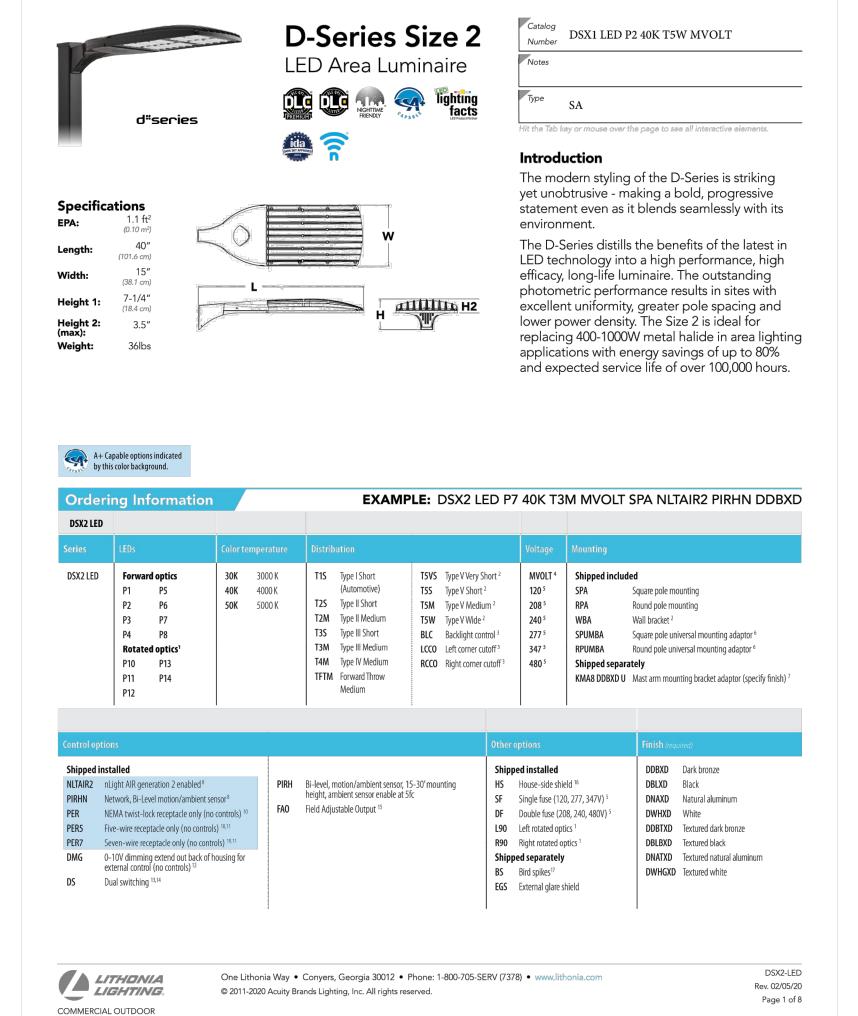
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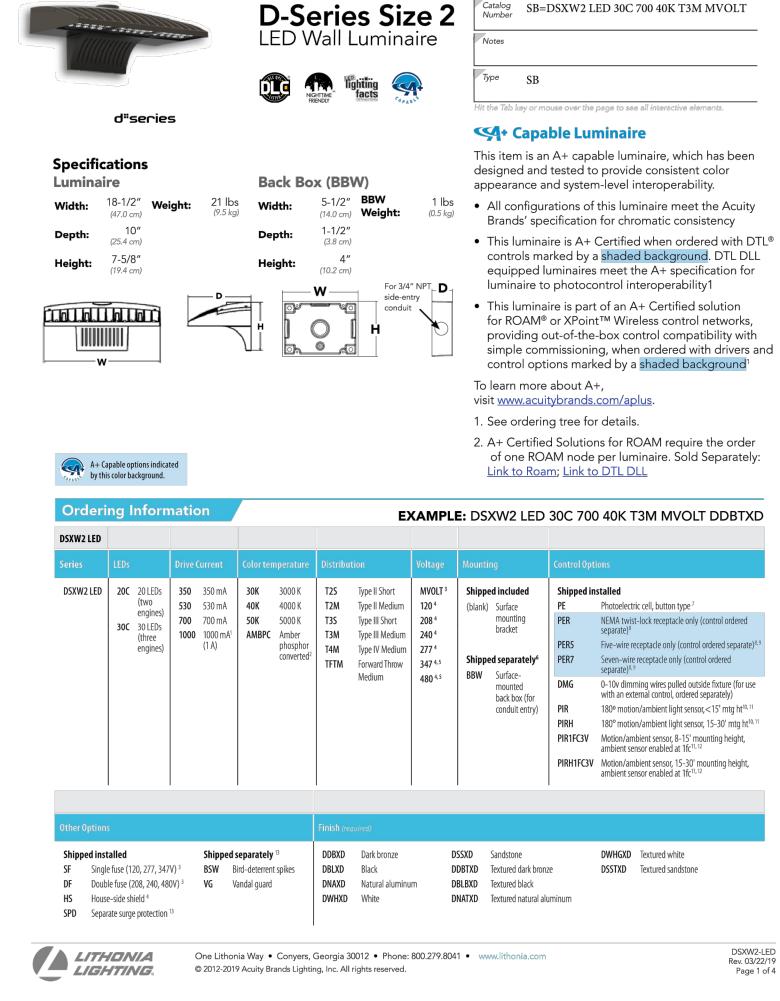
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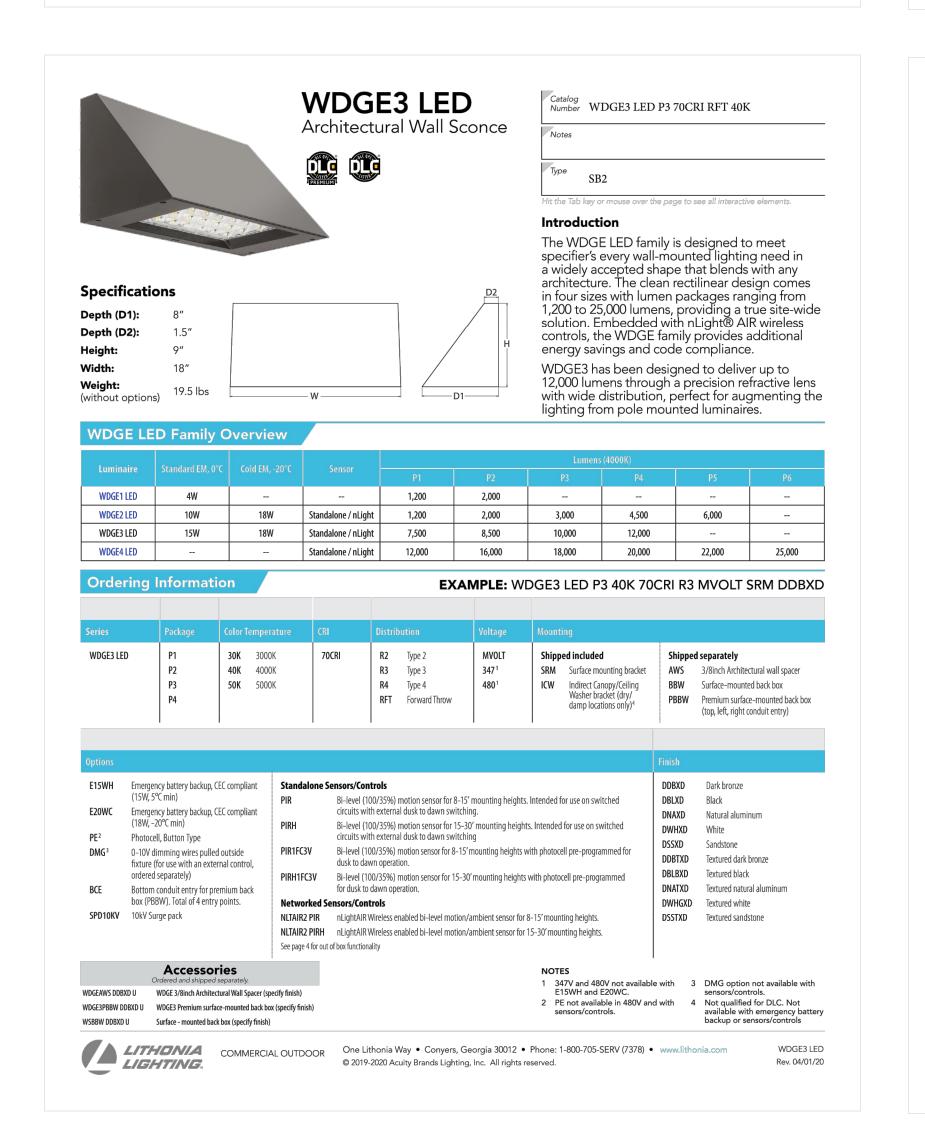
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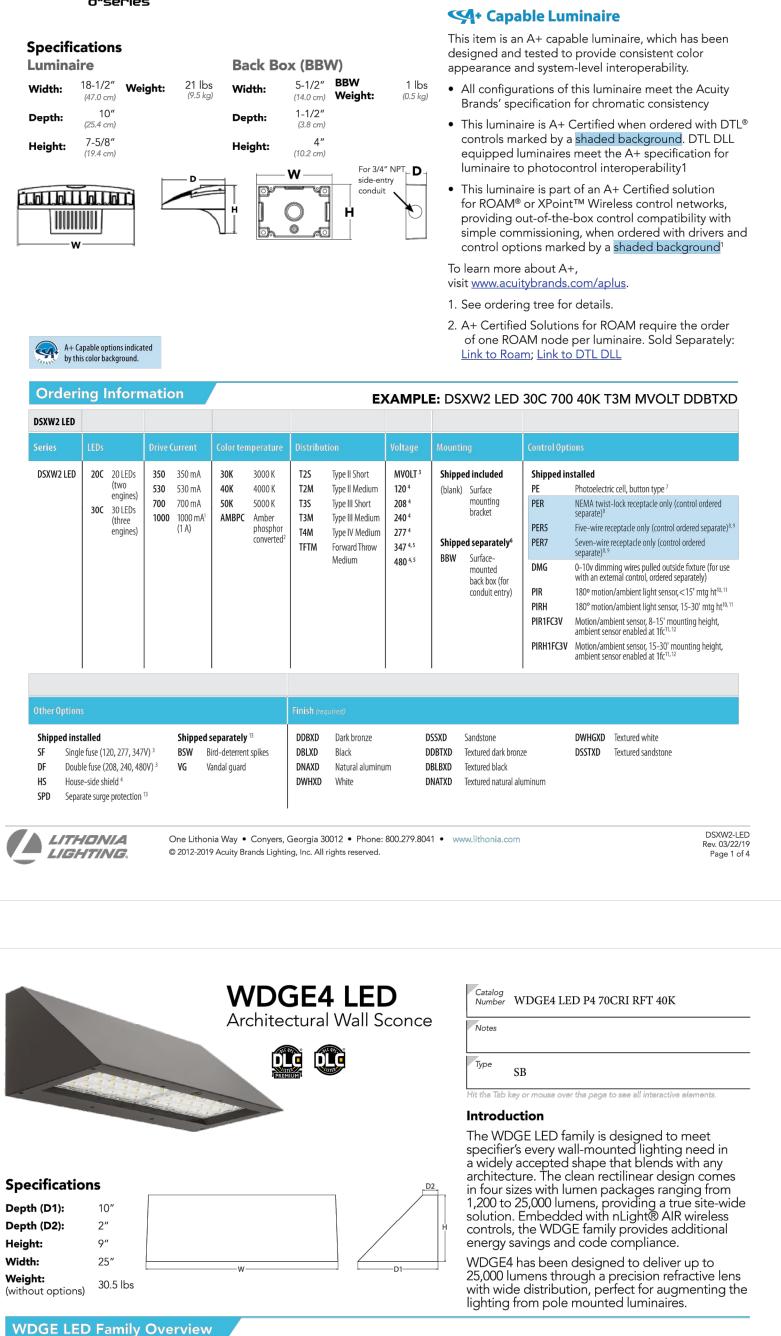
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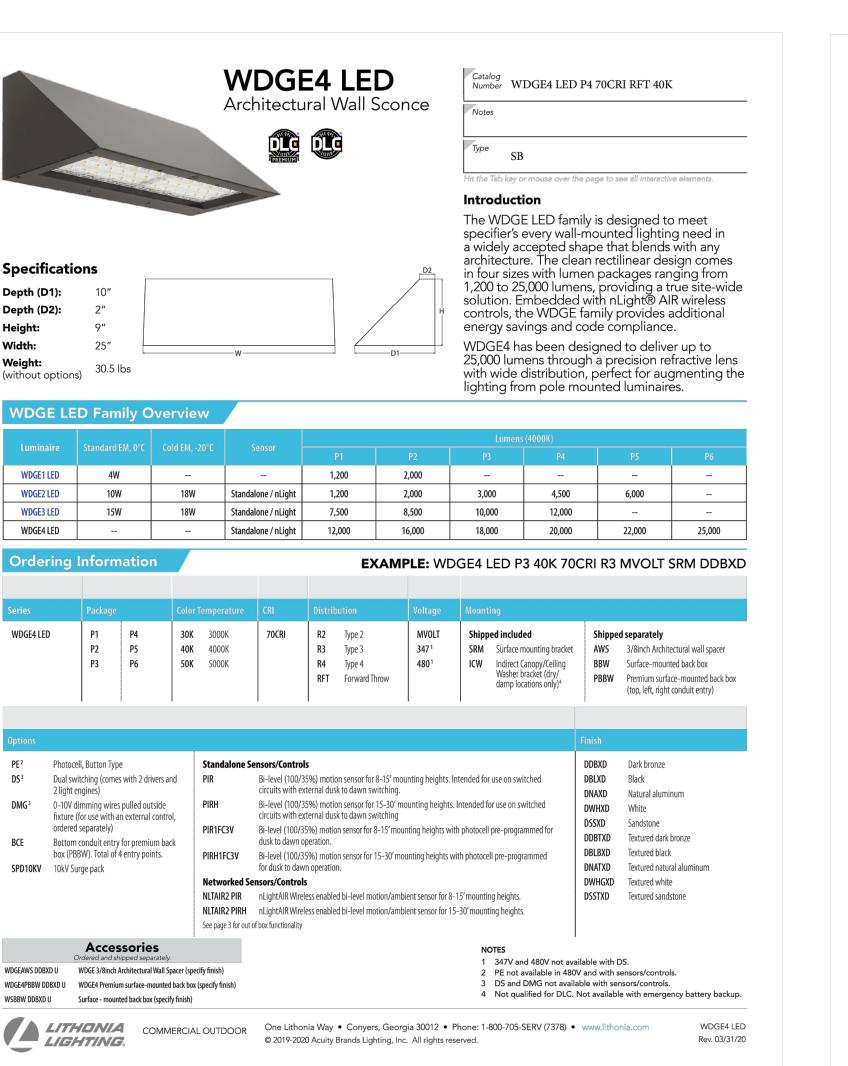
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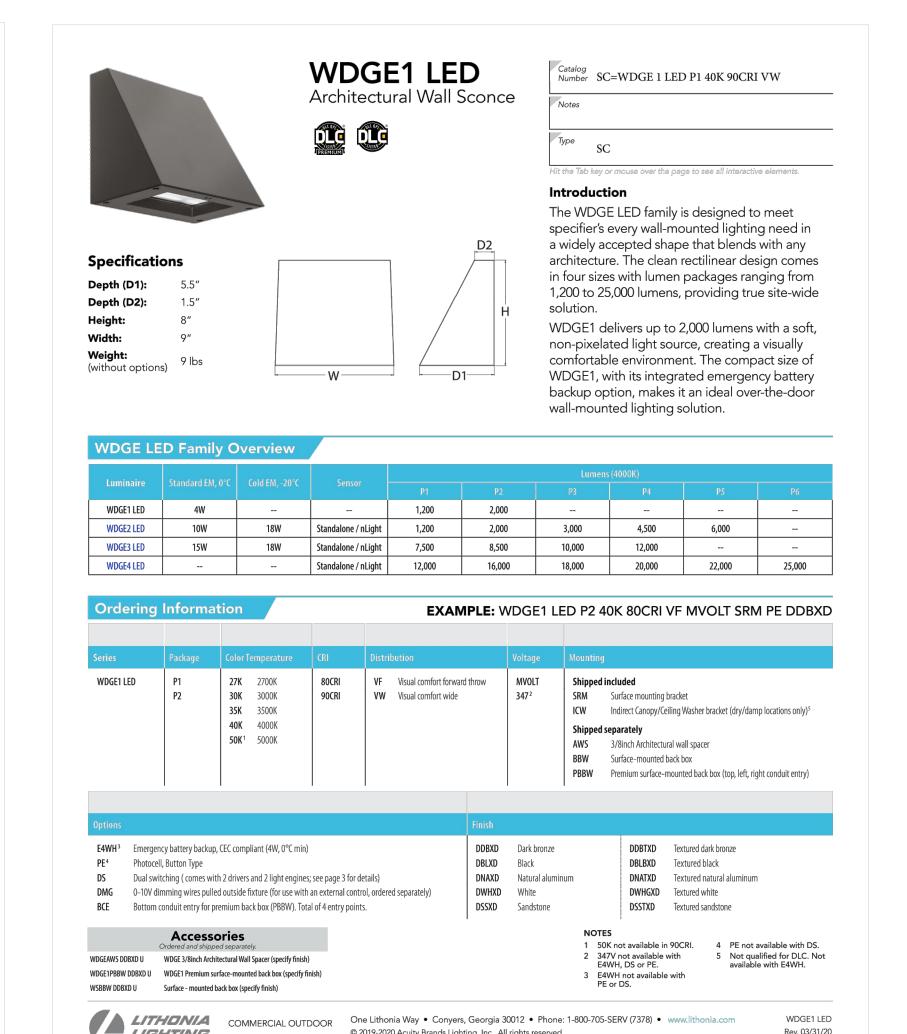




WDGE2 LED

WDGE3 LED

WDGE4 LED




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Rev. 03/31/20





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Sheet Title: LIGHT FIXTURE CUT SHEETS

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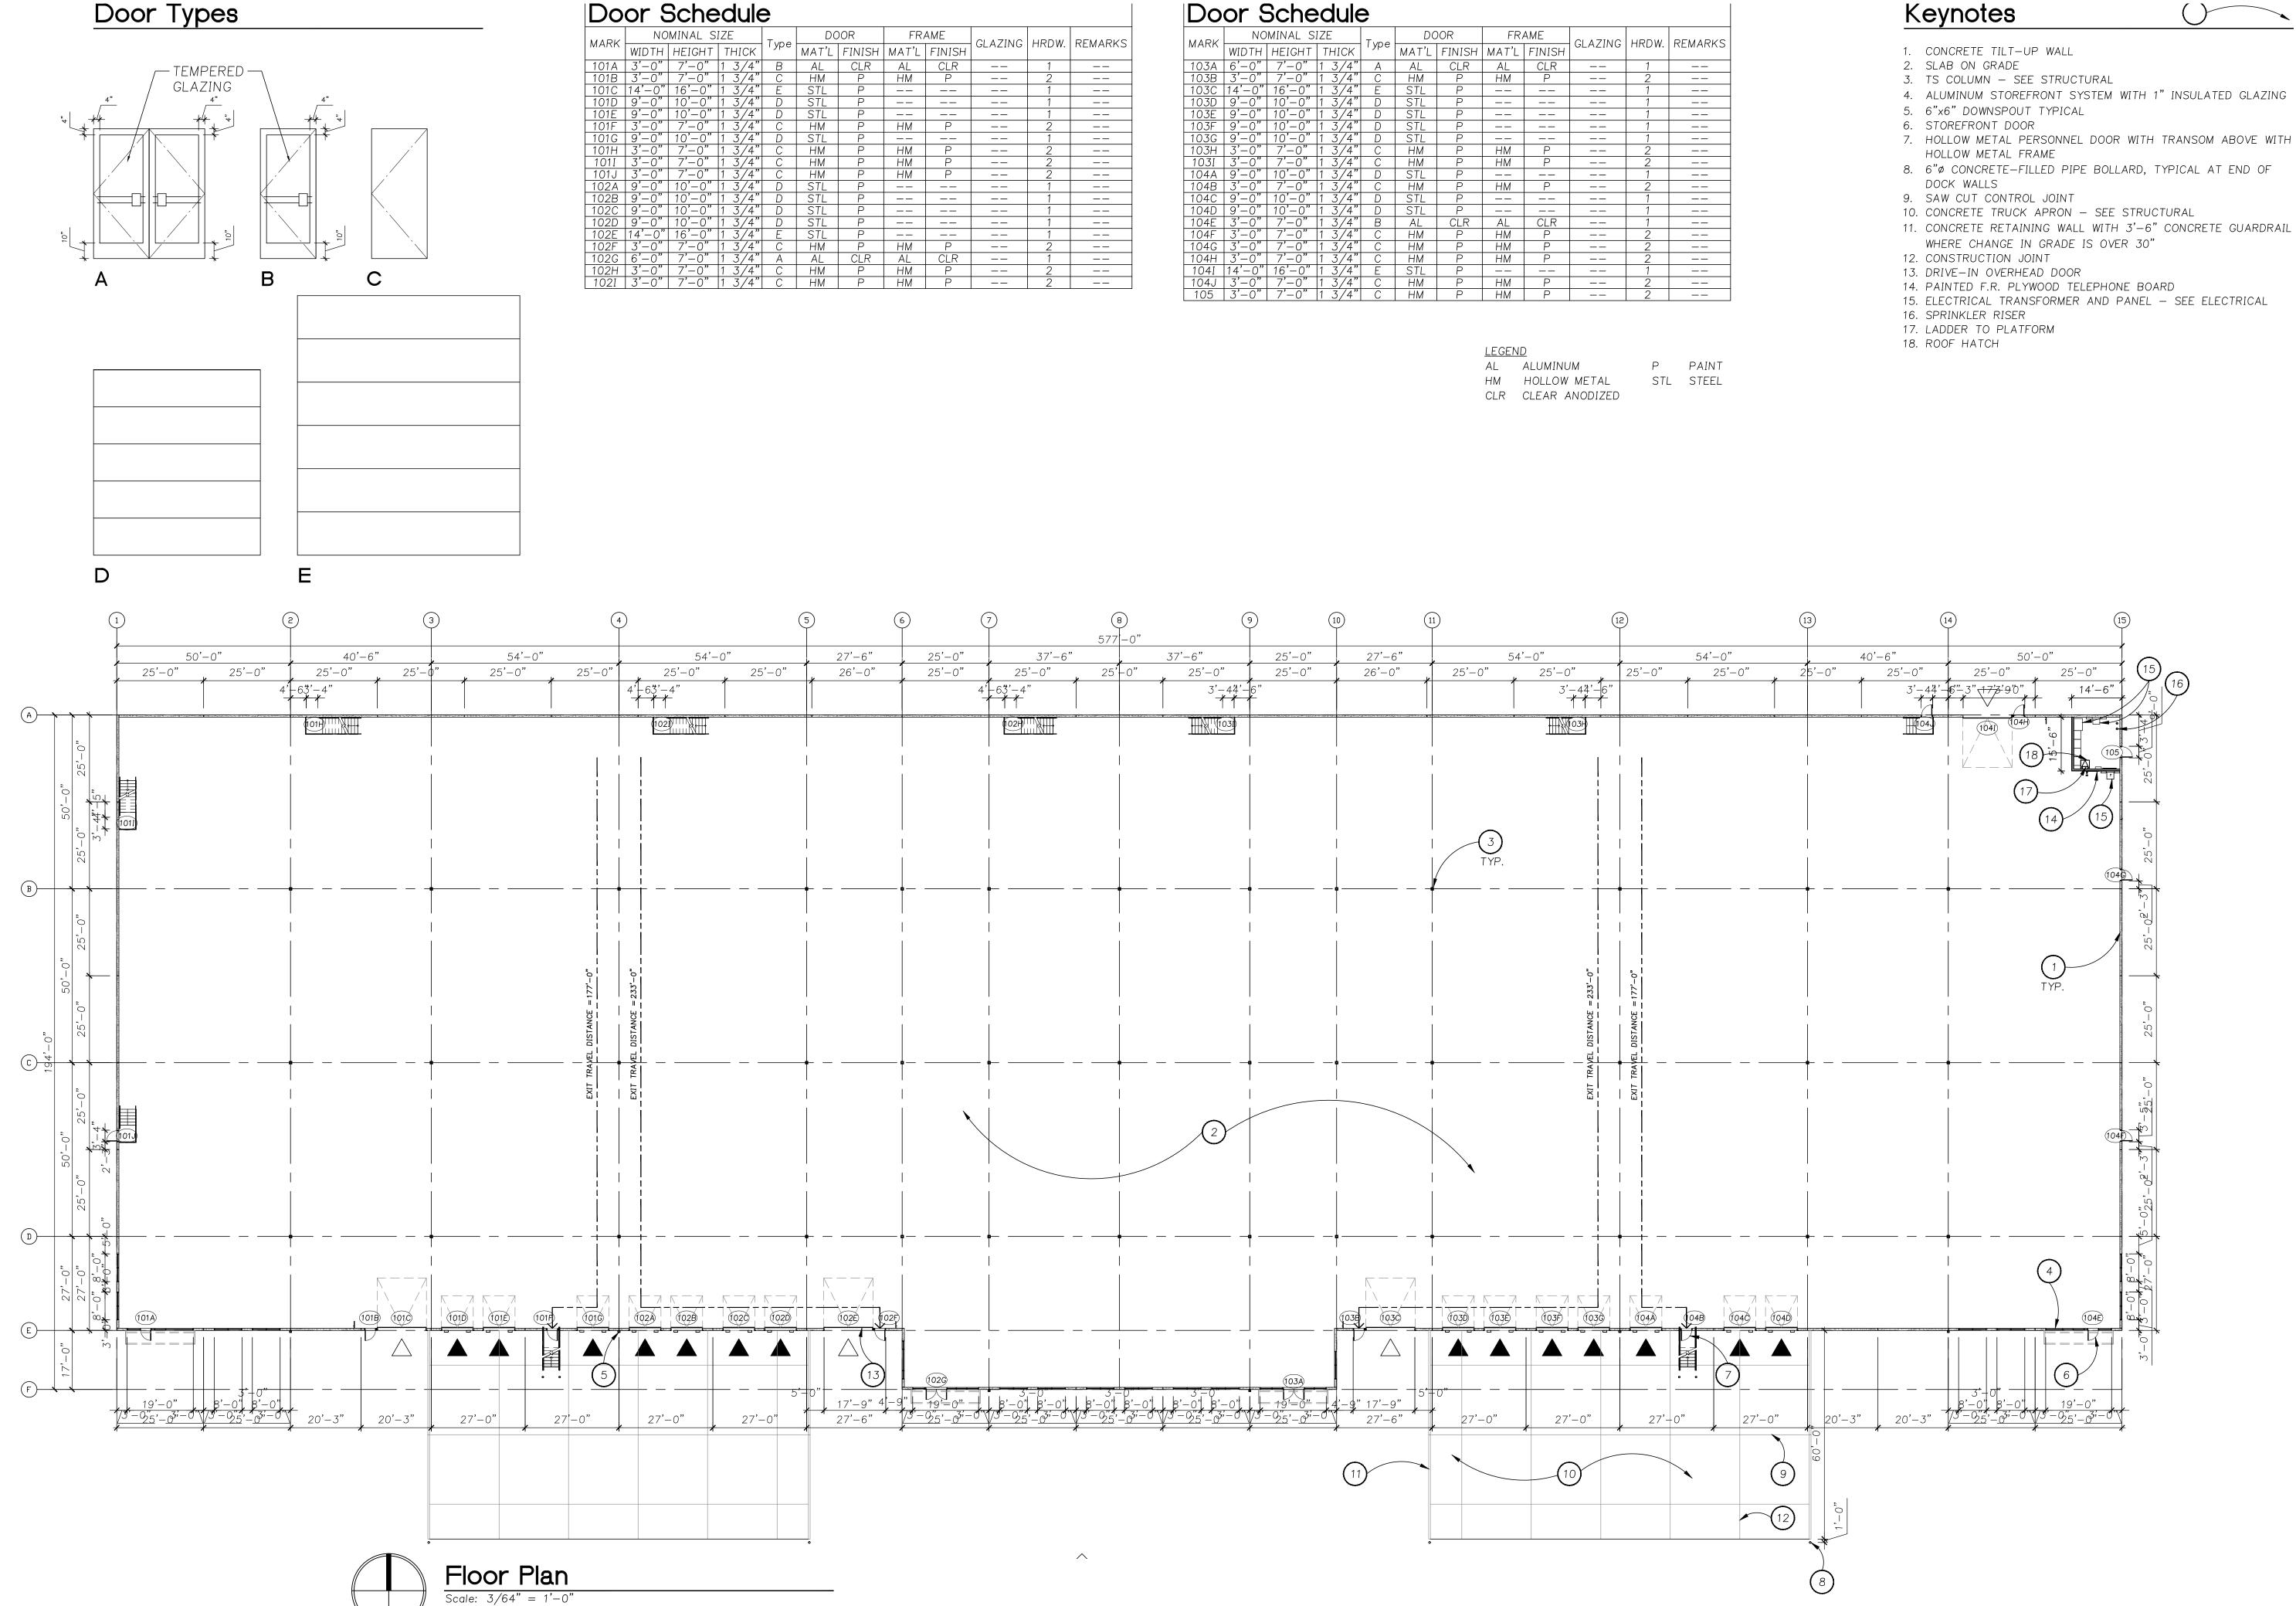
117013

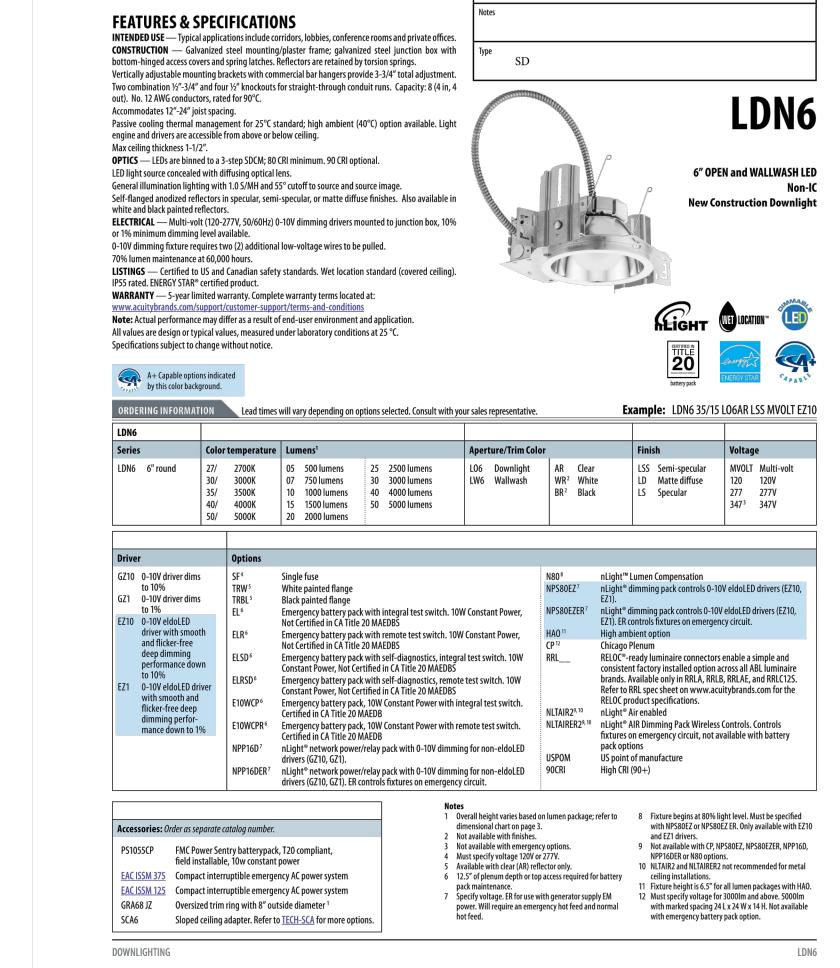engineering@mke-inc.com MECHANICAL AND ELECTRICAL SYSTEMS

PORTLAND, OREGON 972

PHONE: 503.892.1

FAX: 503.892.1190



11. CONCRETE RETAINING WALL WITH 3'-6" CONCRETE GUARDRAIL

ARI-12079

CURTIS L TROLAN

TIGARD, OREGON

OF ORTHO

IVIILDREN

DESIGN

GROUP

O I 503.244.0552

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Sheet Title:

Building 1 Floor Plan

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Sheet

Job Number:

A 1 '1 1 . **.**

BUILT-UP ROOFING SYSTEM, TYPICAL
 ROOF HATCH
 CRICKET
 PARAPET TYPICAL
 RIDGE
 SCUPPER AND 6"x6" DOWNSPOUT
 VALLEY

MILDREN
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Building

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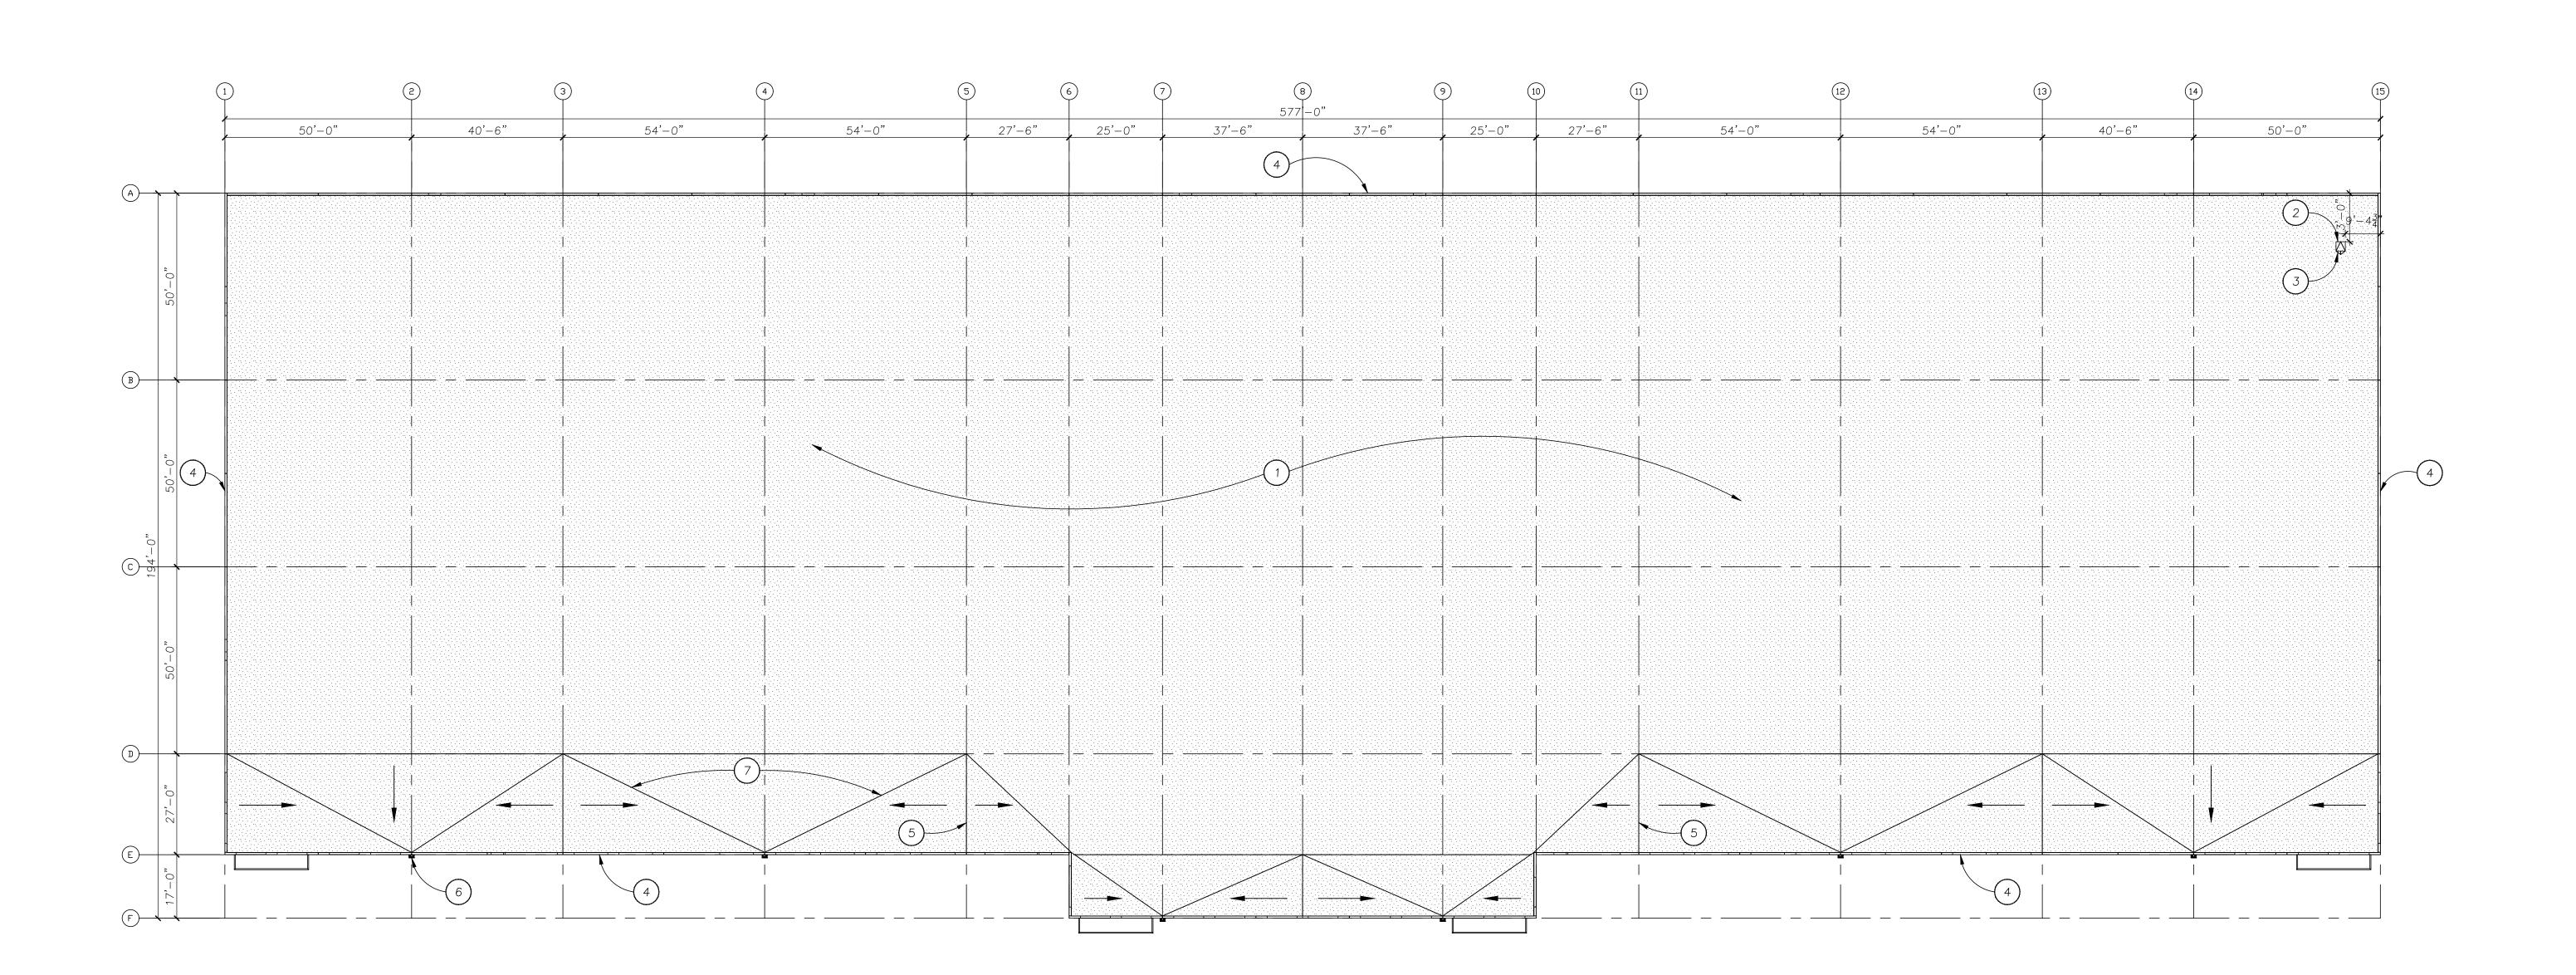
Building 1 Roof Plan

Revisions:


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Building 1 Elevations

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Job Number:

A 1 '1 1 1 I I

P1 MILLER PAINT 8683W TINDERBOX P2 MILLER PAINT 8684M OAK FLATS P3 MILLER PAINT 8676N, TURNED EARTH

Keynotes

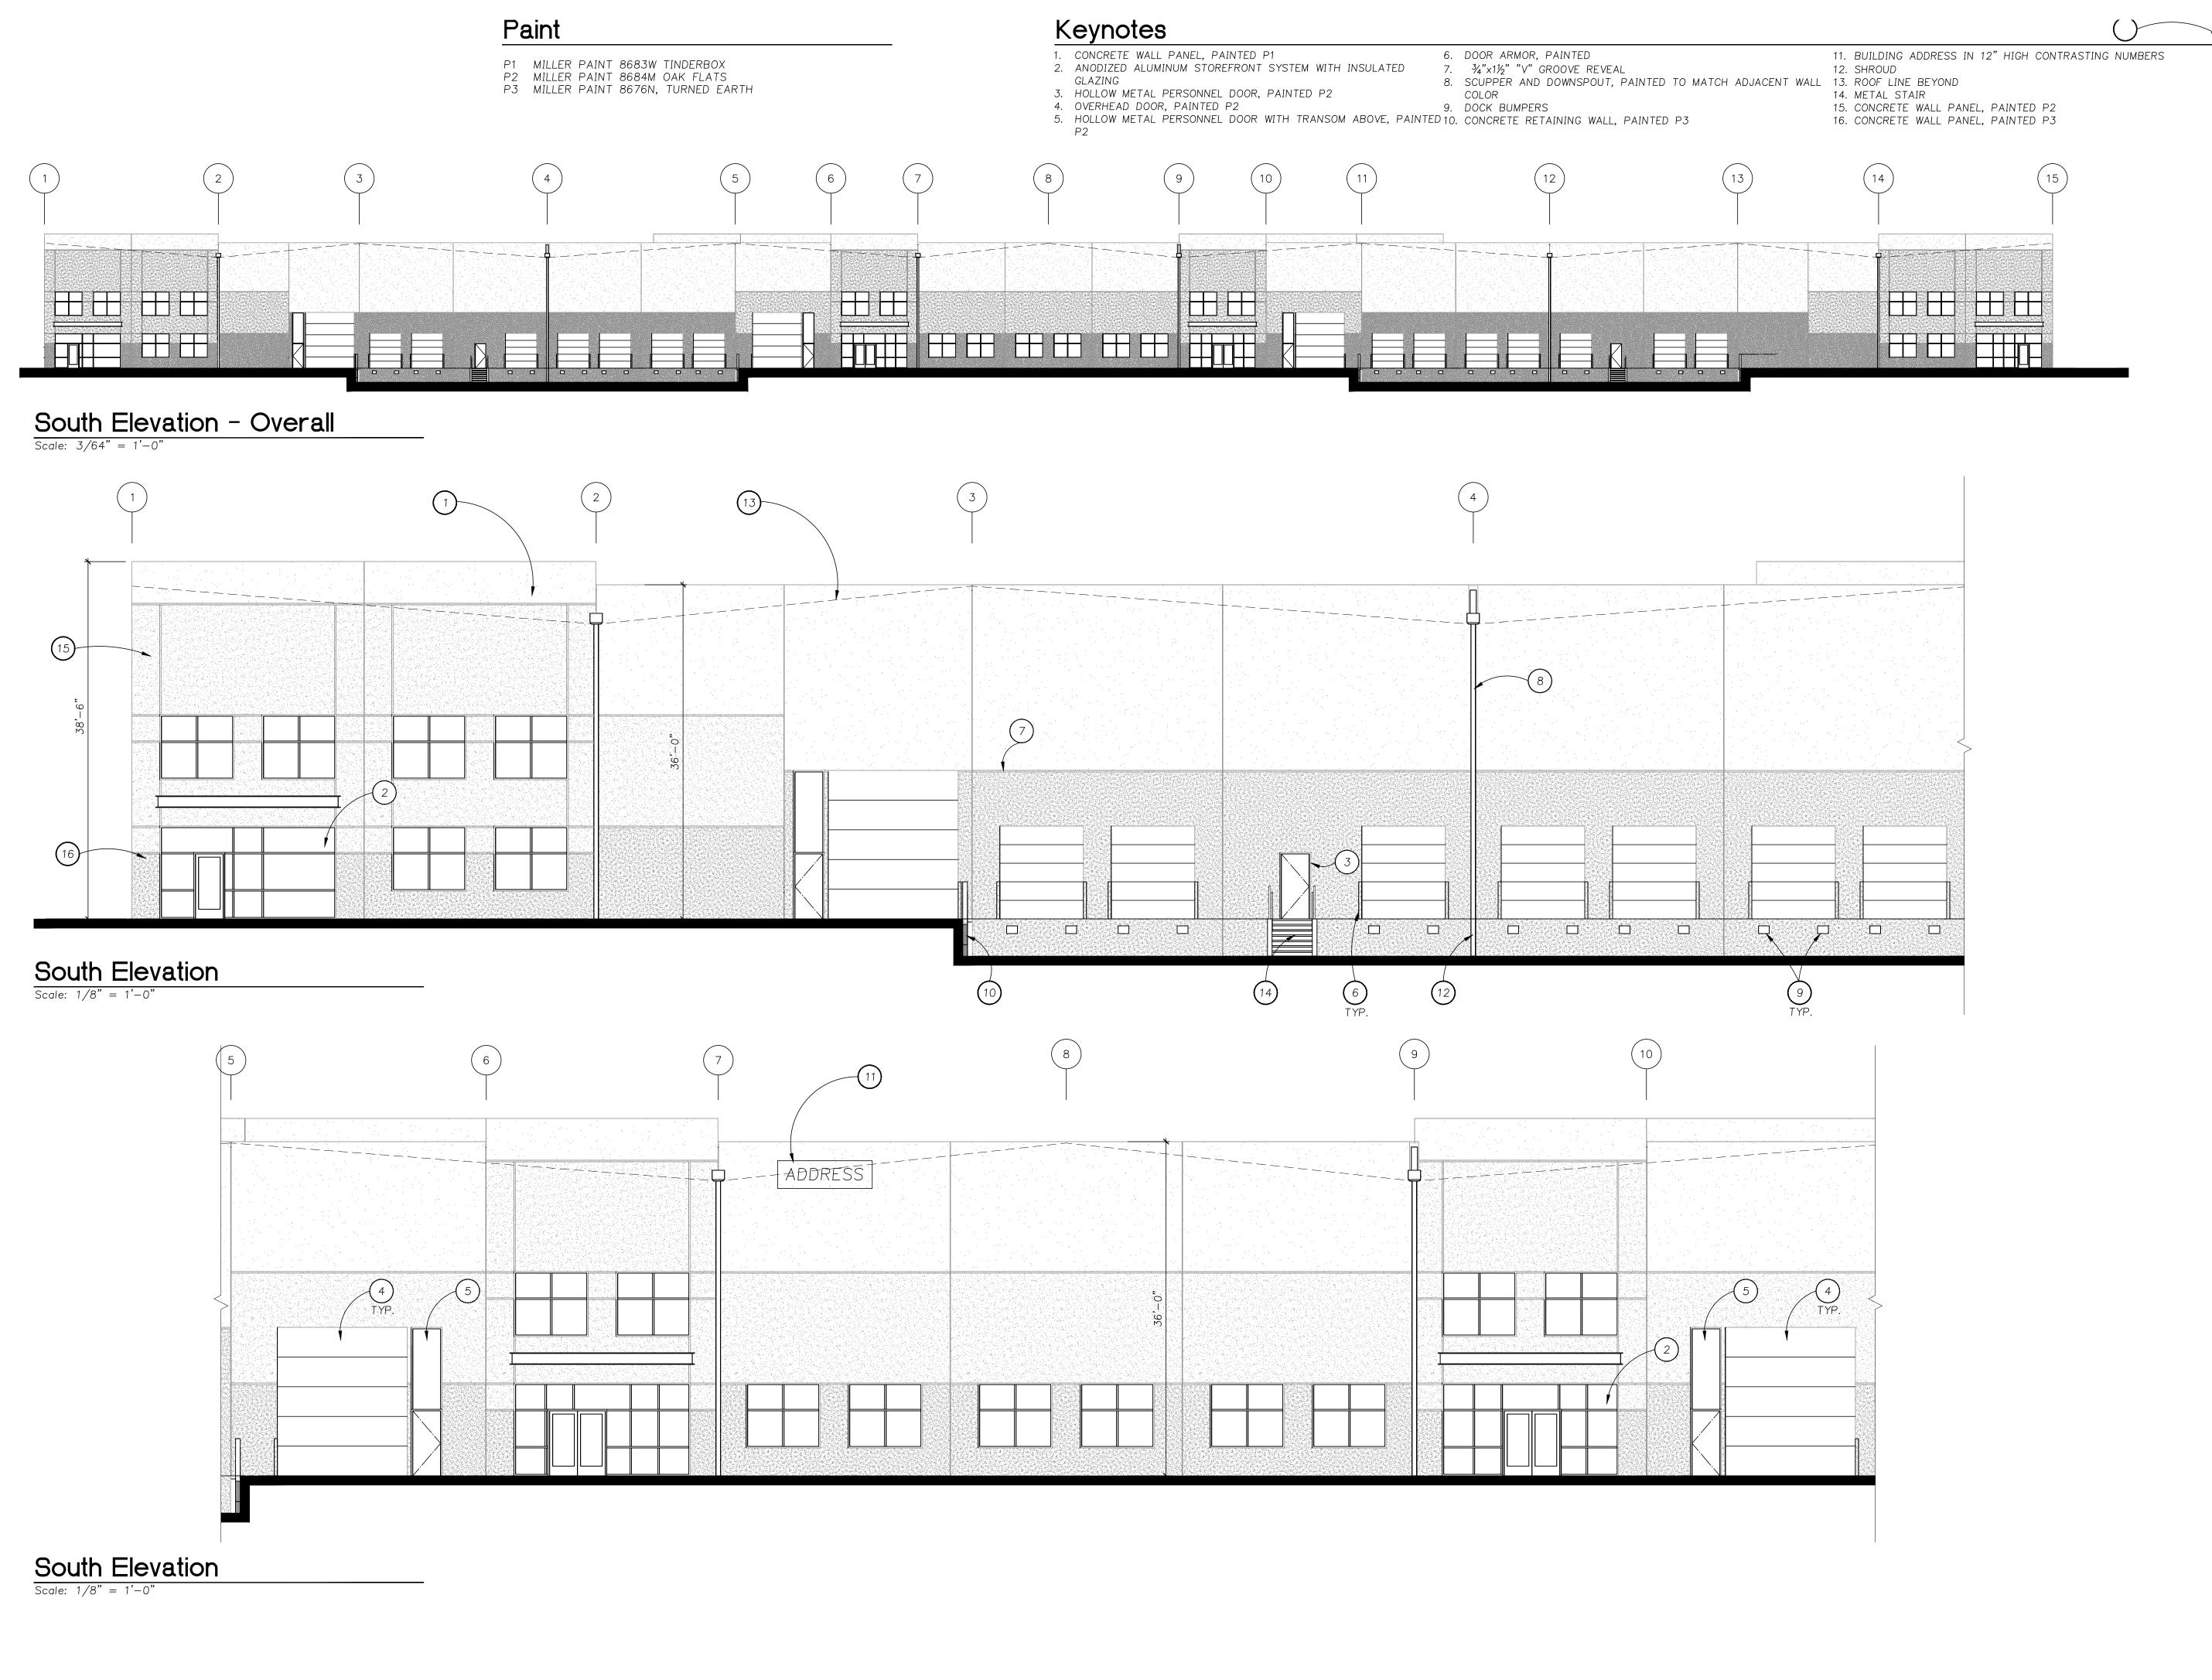1. CONCRETE WALL PANEL, PAINTED P1 2. ANODIZED ALUMINUM STOREFRONT SYSTEM WITH INSULATED


2. ANODIZED ALOMINOM STOREFRONT SYSTEM WITH GLAZING
3. HOLLOW METAL PERSONNEL DOOR, PAINTED P2
4. OVERHEAD DOOR, PAINTED P2
5. METAL STAIR
6. BOLLARD, PAINTED HAZARD YELLOW

7. DOOR ARMOR, PAINTED

13. ROOF LINE BEYOND

8. 3/4"x11/2" "V" GROOVE REVEAL
9. SCUPPER AND DOWNSPOUT, PAINTED TO MATCH ADJACENT WALL 15. CONCRETE WALL PANEL, PAINTED P3
COLOR

10. DOCK BUMPERS
11. CONCRETE RETAINING WALL, PAINTED P3
12. SHROUD

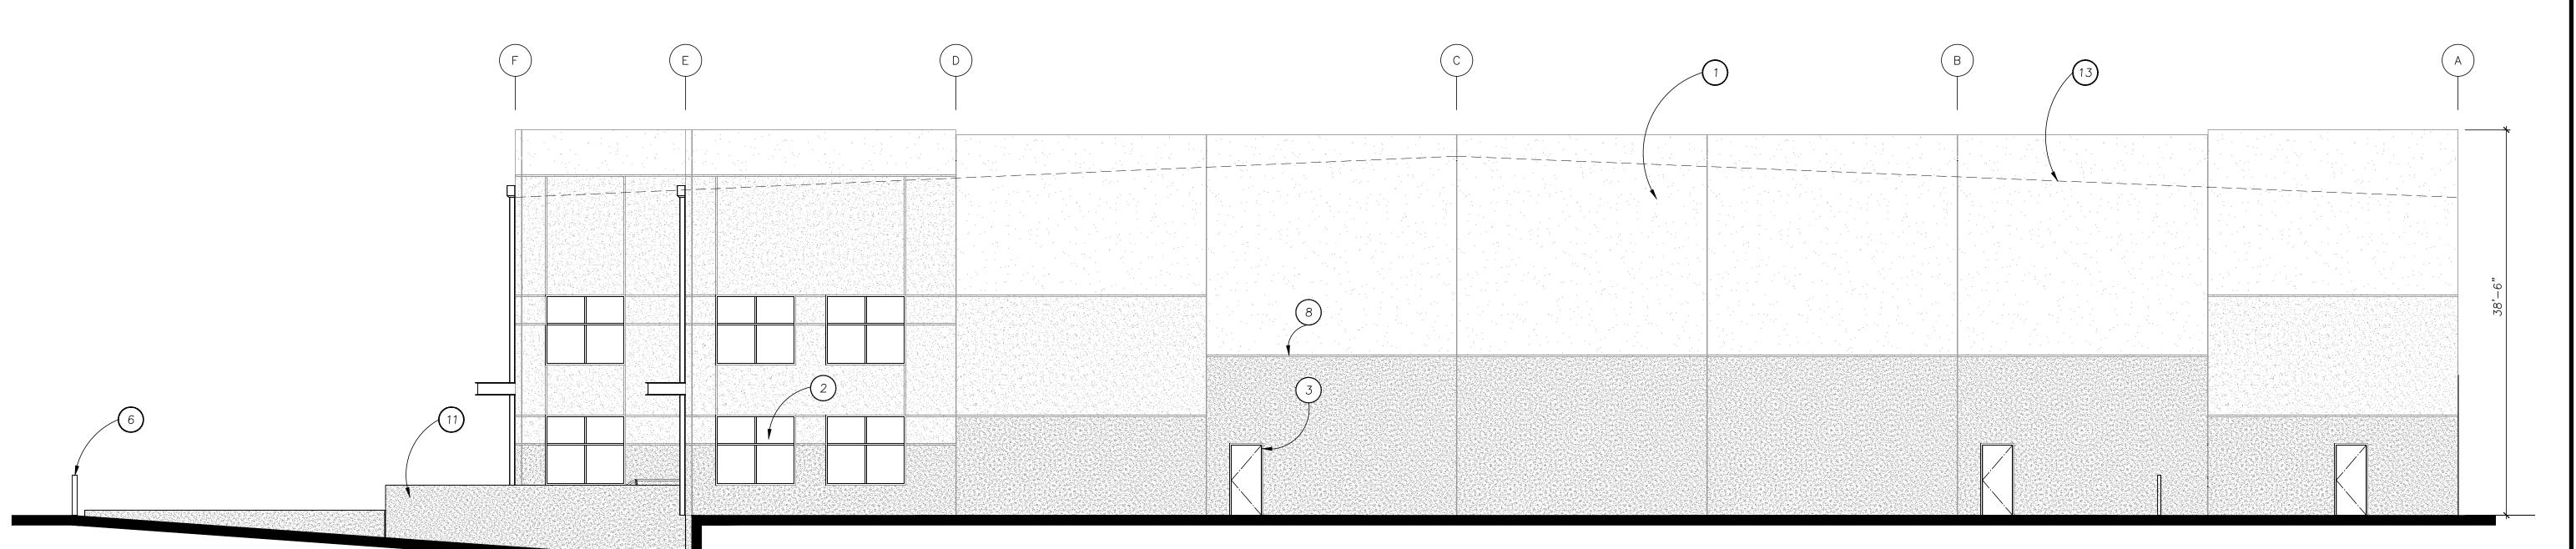

East Elevation

Scale: 1/8" = 1'-0"

South Elevation

Scale: 1/8" = 1'-0"

IVIILDREN **D**ESIGN GROUP

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Project:

Lu Pacific Development Building

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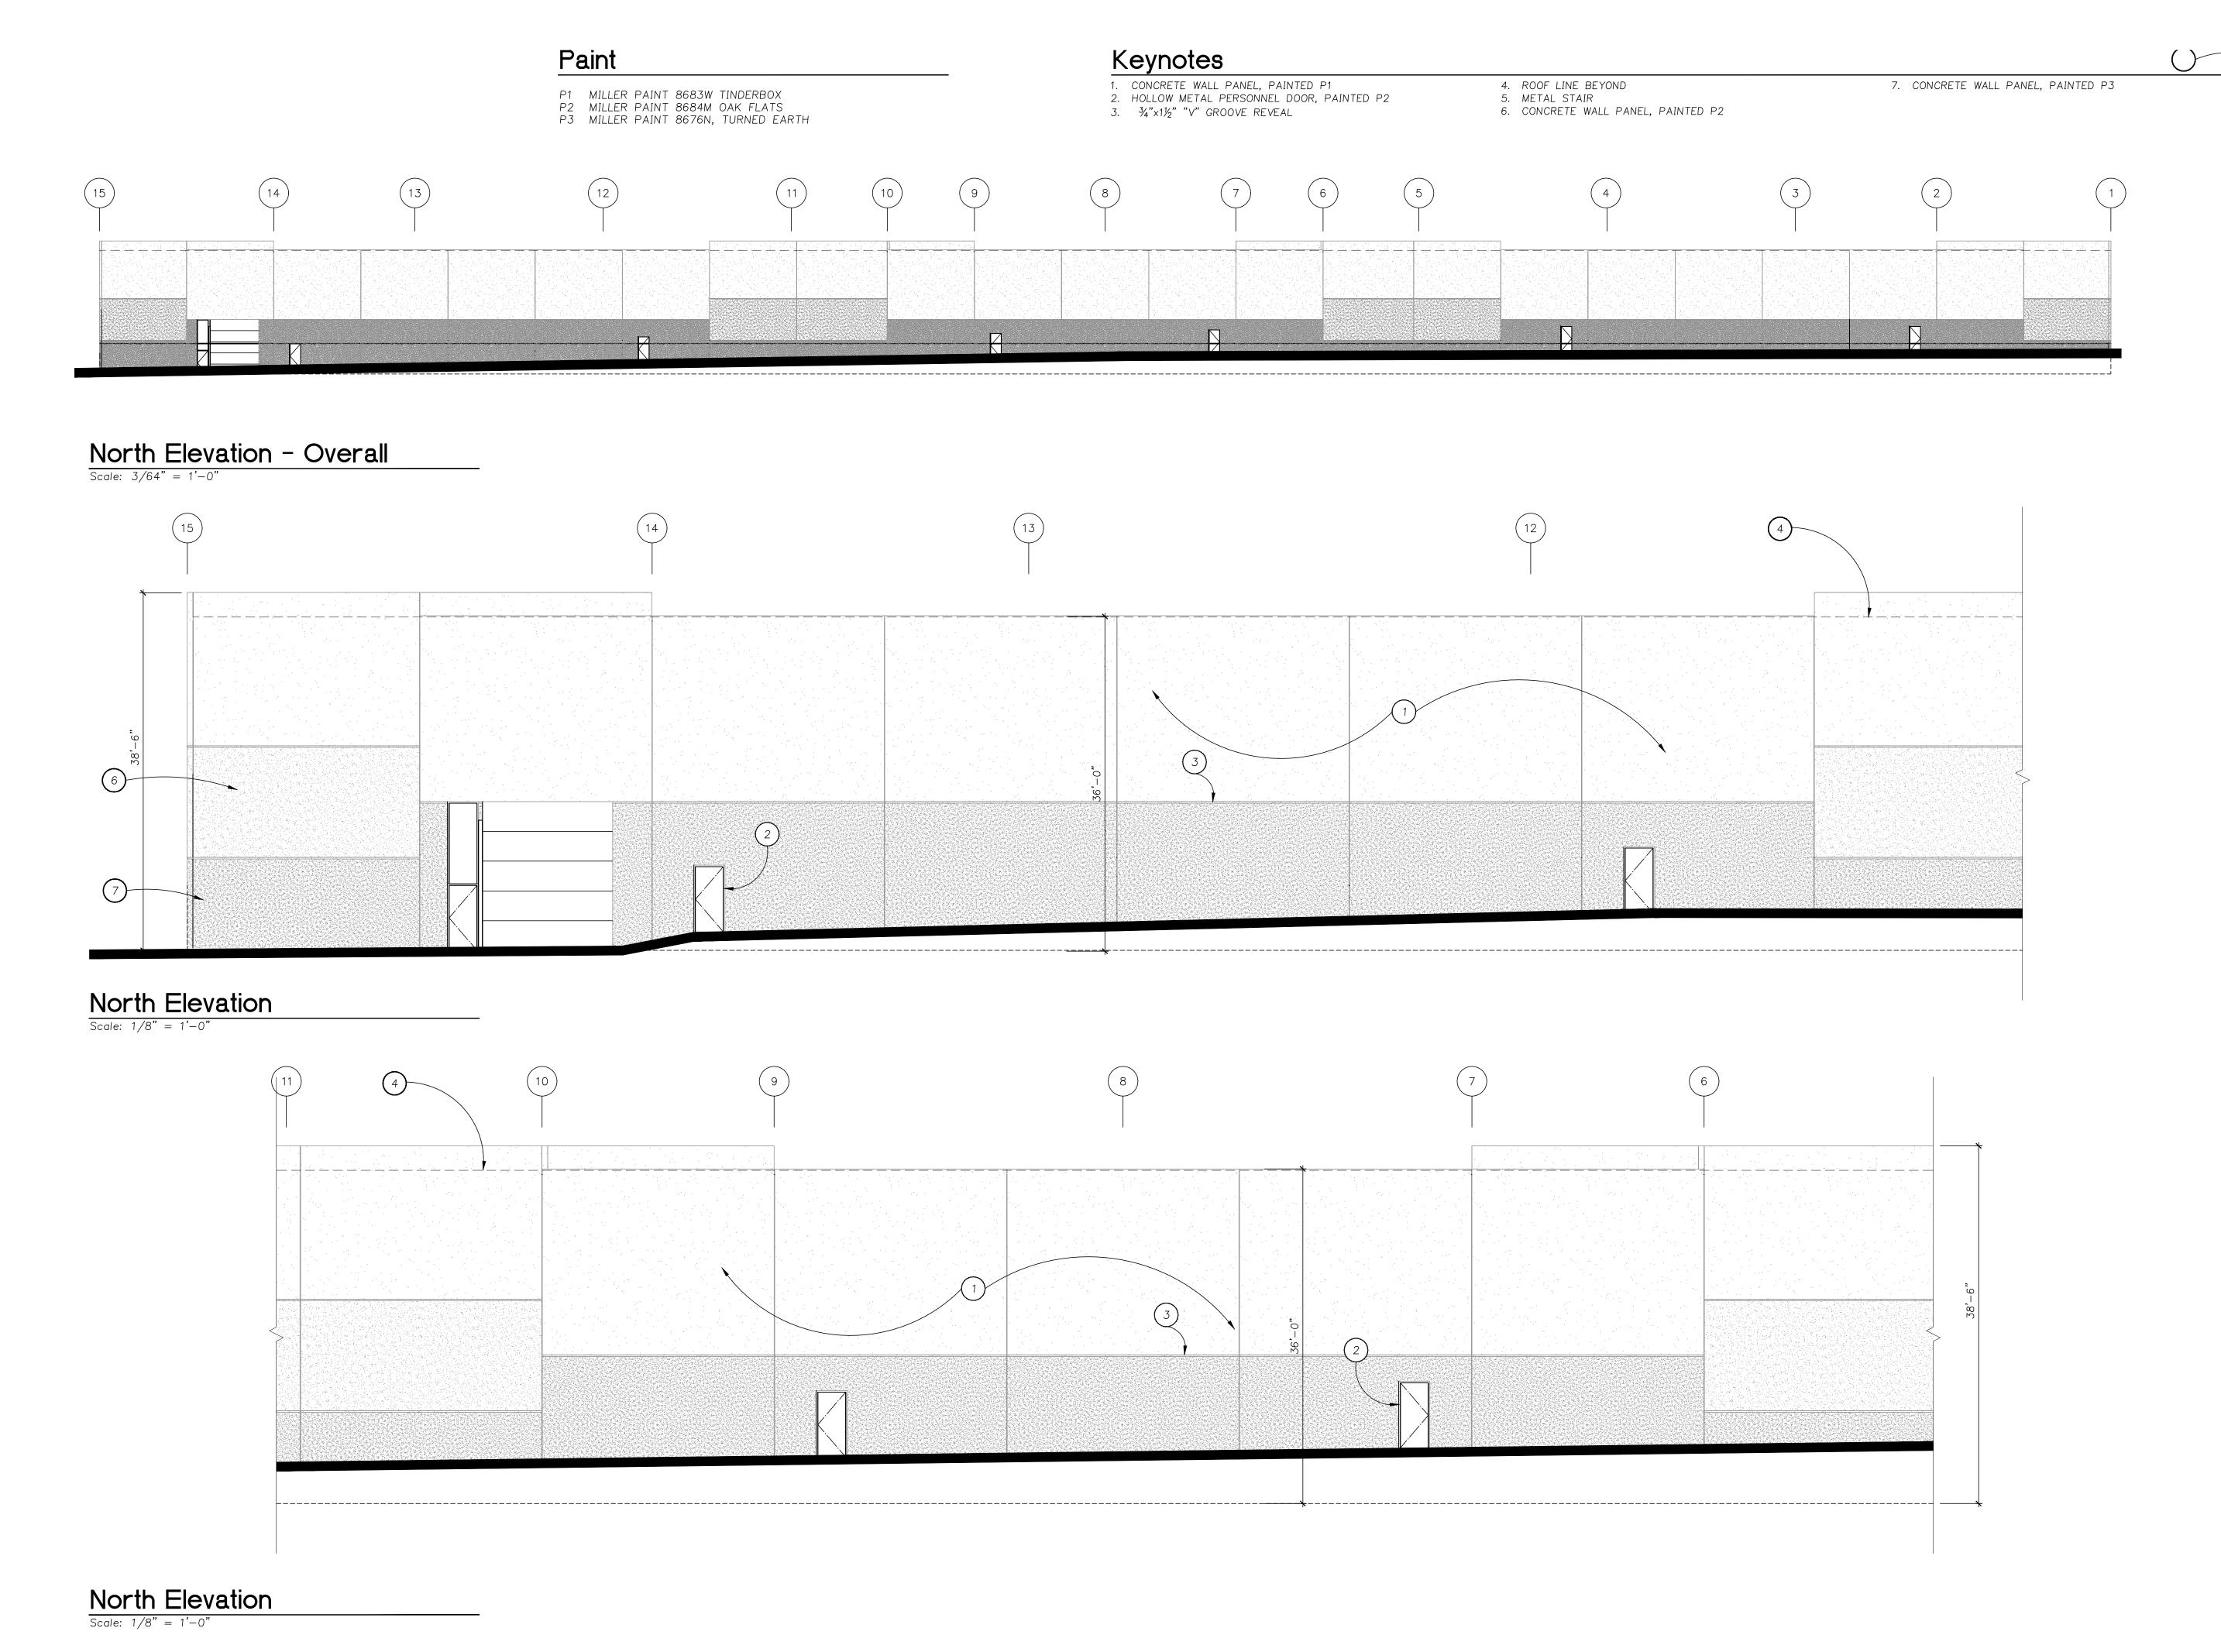
Building 1 Elevations

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ARI-12079

CUBTIS L. TROLAN

TIGARD, OREGON

OF OREO

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Project

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Sheet Title:

Building 1 Elevations

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TQL
Job Number: 117013

Sheet

P1 MILLER PAINT 8683W TINDERBOX P2 MILLER PAINT 8684M OAK FLATS P3 MILLER PAINT 8676N, TURNED EARTH

1. CONCRETE WALL PANEL, PAINTED P1 2. ANODIZED ALUMINUM STOREFRONT SYSTEM WITH INSULATED

GLAZING

3. HOLLOW METAL PERSONNEL DOOR, PAINTED P2

4. BOLLARD, PAINTED HAZARD YELLOW

5. ¾"x1½" "V" GROOVE REVEAL
6. SCUPPER AND DOWNSPOUT, PAINTED TO MATCH ADJACENT WALL
7. CONCRETE RETAINING WALL, PAINTED P3
8. ROOF LINE BEYOND

GROUP ARCHITECTURE | INTERIORS

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Building

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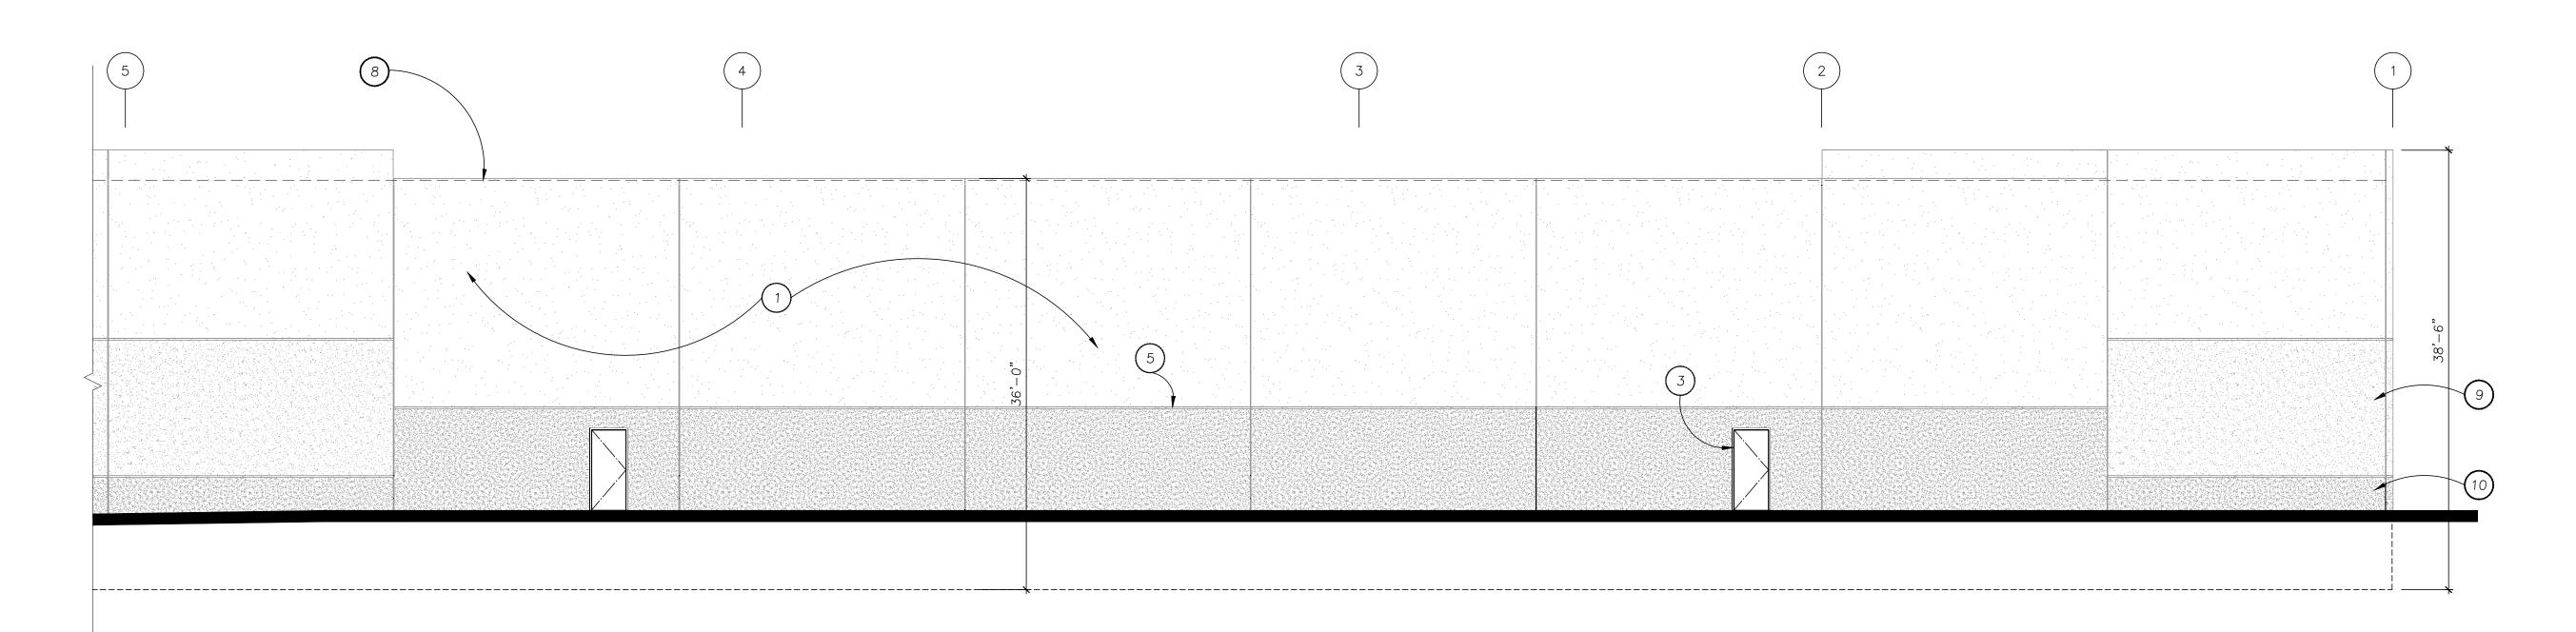
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Building 1 Elevations

Revisions:


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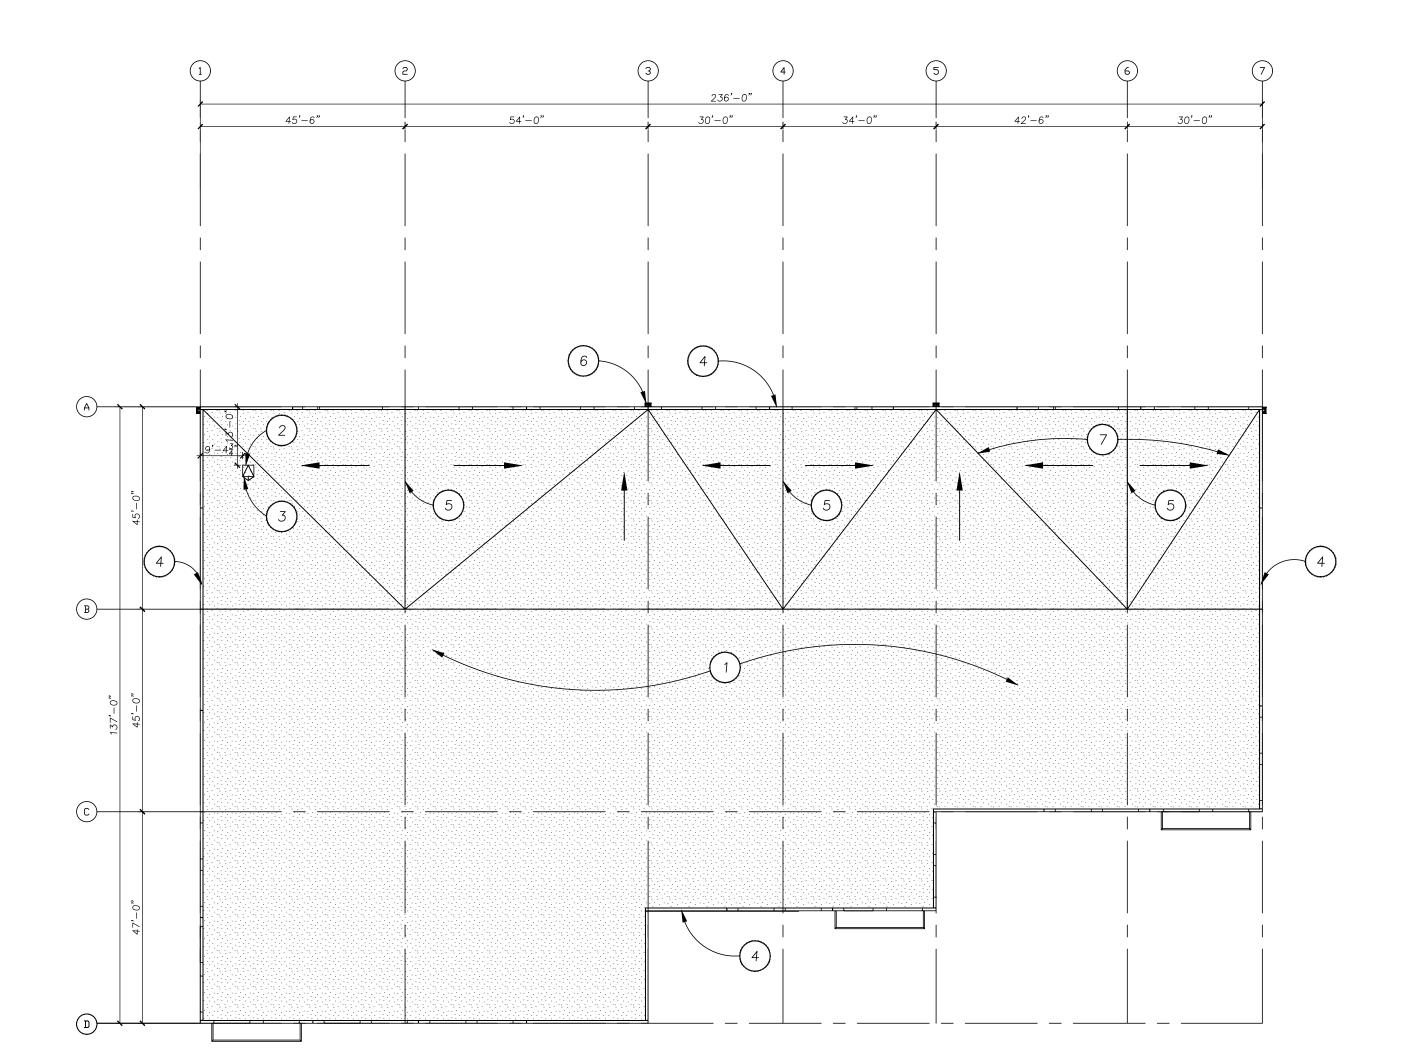
North Elevation


Scale: 1/8" = 1'-0"



West Elevation

| Scale: 1/8" = 1'-0"

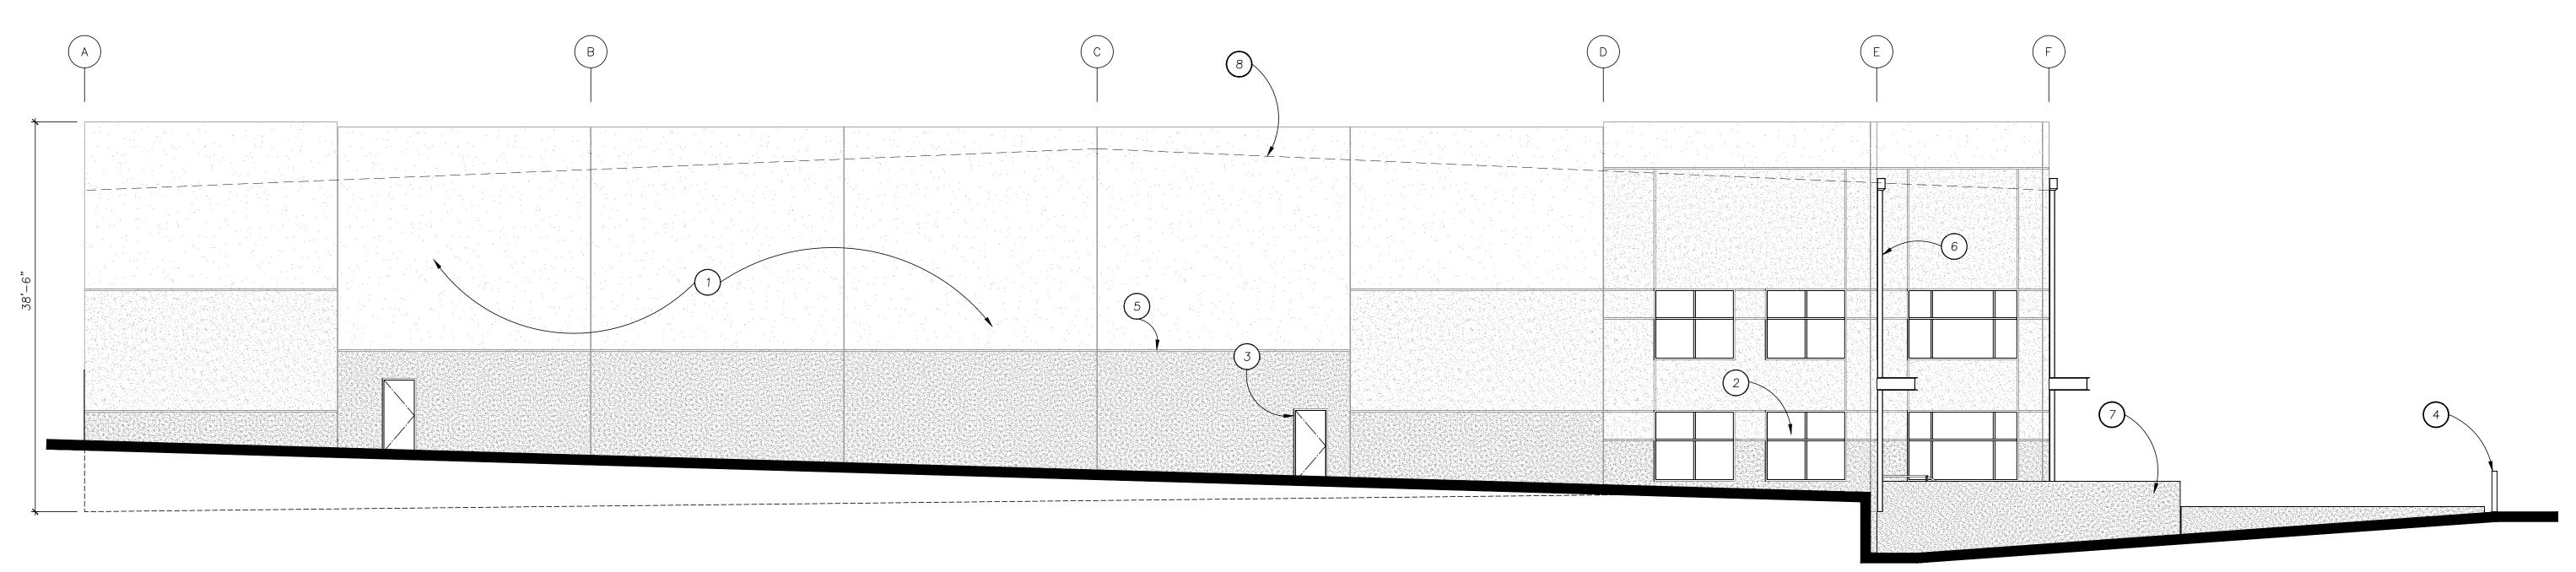

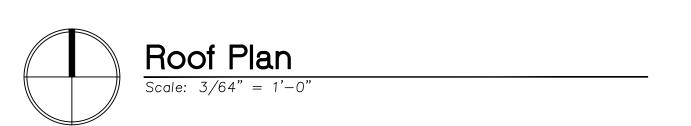

Keynotes





BUILT-UP ROOFING SYSTEM, TYPICAL
 ROOF HATCH
 CRICKET
 PARAPET TYPICAL
 RIDGE
 SCUPPER AND 6"x6" DOWNSPOUT
 VALLEY

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Sheet Title:

Building 2 Roof Plan

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Sheet

Keynotes

1. CONCRETE WALL PANEL, PAINTED P1
2. ANODIZED ALUMINUM STOREFRONT SYSTEM WITH INSULATED
3. OVERHEAD DOOR, PAINTED P2
4. HOLLOW METAL PERSONNEL DOOR WITH TRANSOM ABOVE, PAINTED

9. DOCK BUMPERS

5. BOLLARD, PAINTED HAZARD YELLOW
6. DOOR ARMOR, PAINTED
6. DOOR ARMOR, PAINTED
7. ¾"x1½" "V" GROOVE REVEAL
7. ¾"x1½" "V" GROOVE REVEAL
8. SCUPPER AND DOWNSPOUT, PAINTED TO MATCH ADJACENT WALL
9. DOCK BUMPERS

10. CONCRETE RETAINING WALL, PAINTED P3
11. SHROUD
12. ROOF LINE BEYOND
13. CONCRETE WALL PANEL, PAINTED P2
14. CONCRETE WALL PANEL, PAINTED P3
15. DOCK BUMPERS

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Sheet Title:


Building 2 Elevations

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North Elevation



East Elevation

Scale: 1/8" = 1'-0"

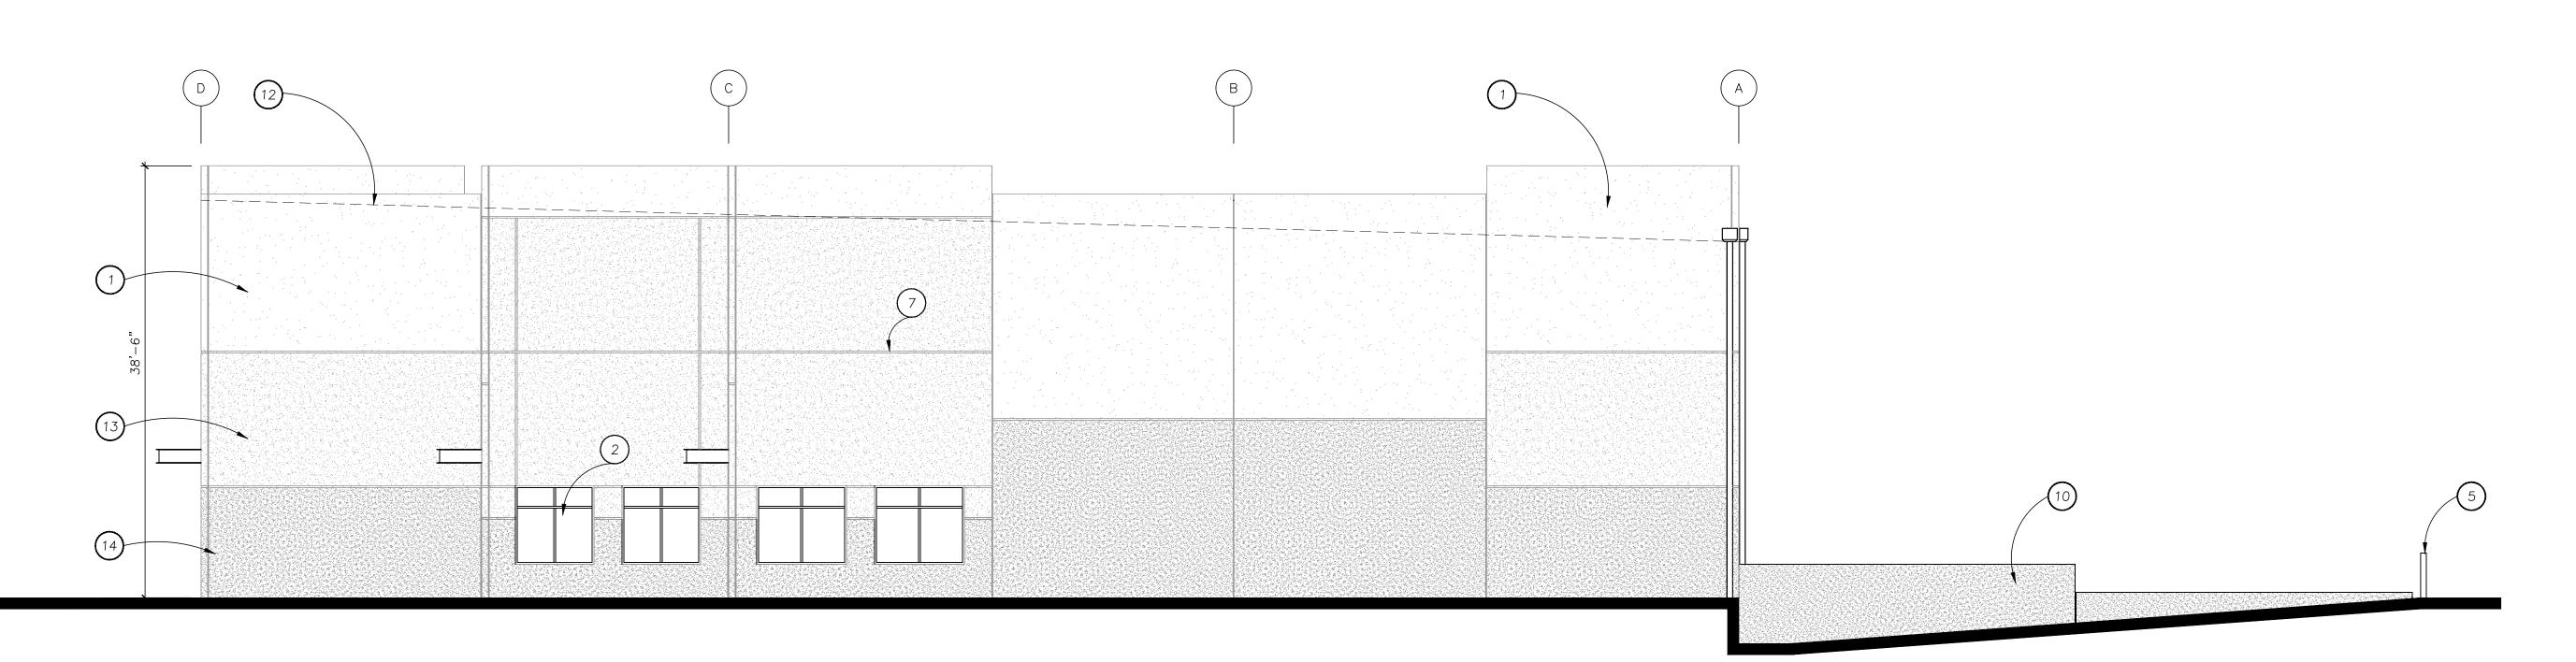Scale: 1/8" = 1'-0"

P1 MILLER PAINT 8683W TINDERBOX P2 MILLER PAINT 8684M OAK FLATS P3 MILLER PAINT 8676N, TURNED EARTH

1. CONCRETE WALL PANEL, PAINTED P1 2. ANODIZED ALUMINUM STOREFRONT SYSTEM WITH INSULATED

GLAZING


3. HOLLOW METAL PERSONNEL DOOR, PAINTED P2

4. BOLLARD, PAINTED HAZARD YELLOW

5. ¾"x1½" "V" GROOVE REVEAL


7. CONCRETE RETAINING WALL, PAINTED P38. BUILDING ADDRESS IN 12" HIGH CONTRASTING NUMBERS

9. ROOF LINE BEYOND

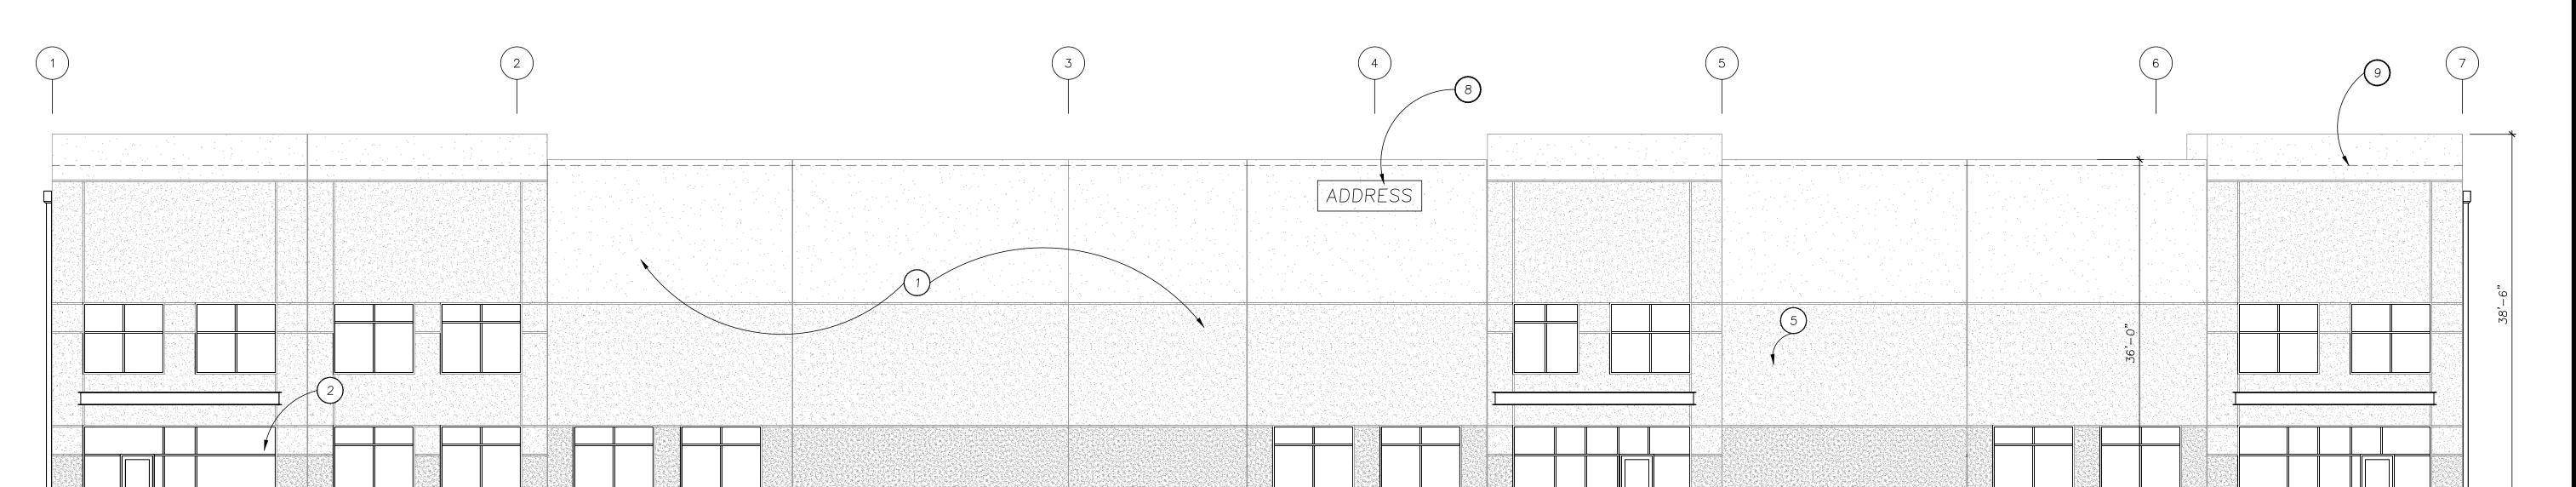

South Elevation

| Scale: 1/8" = 1'-0"

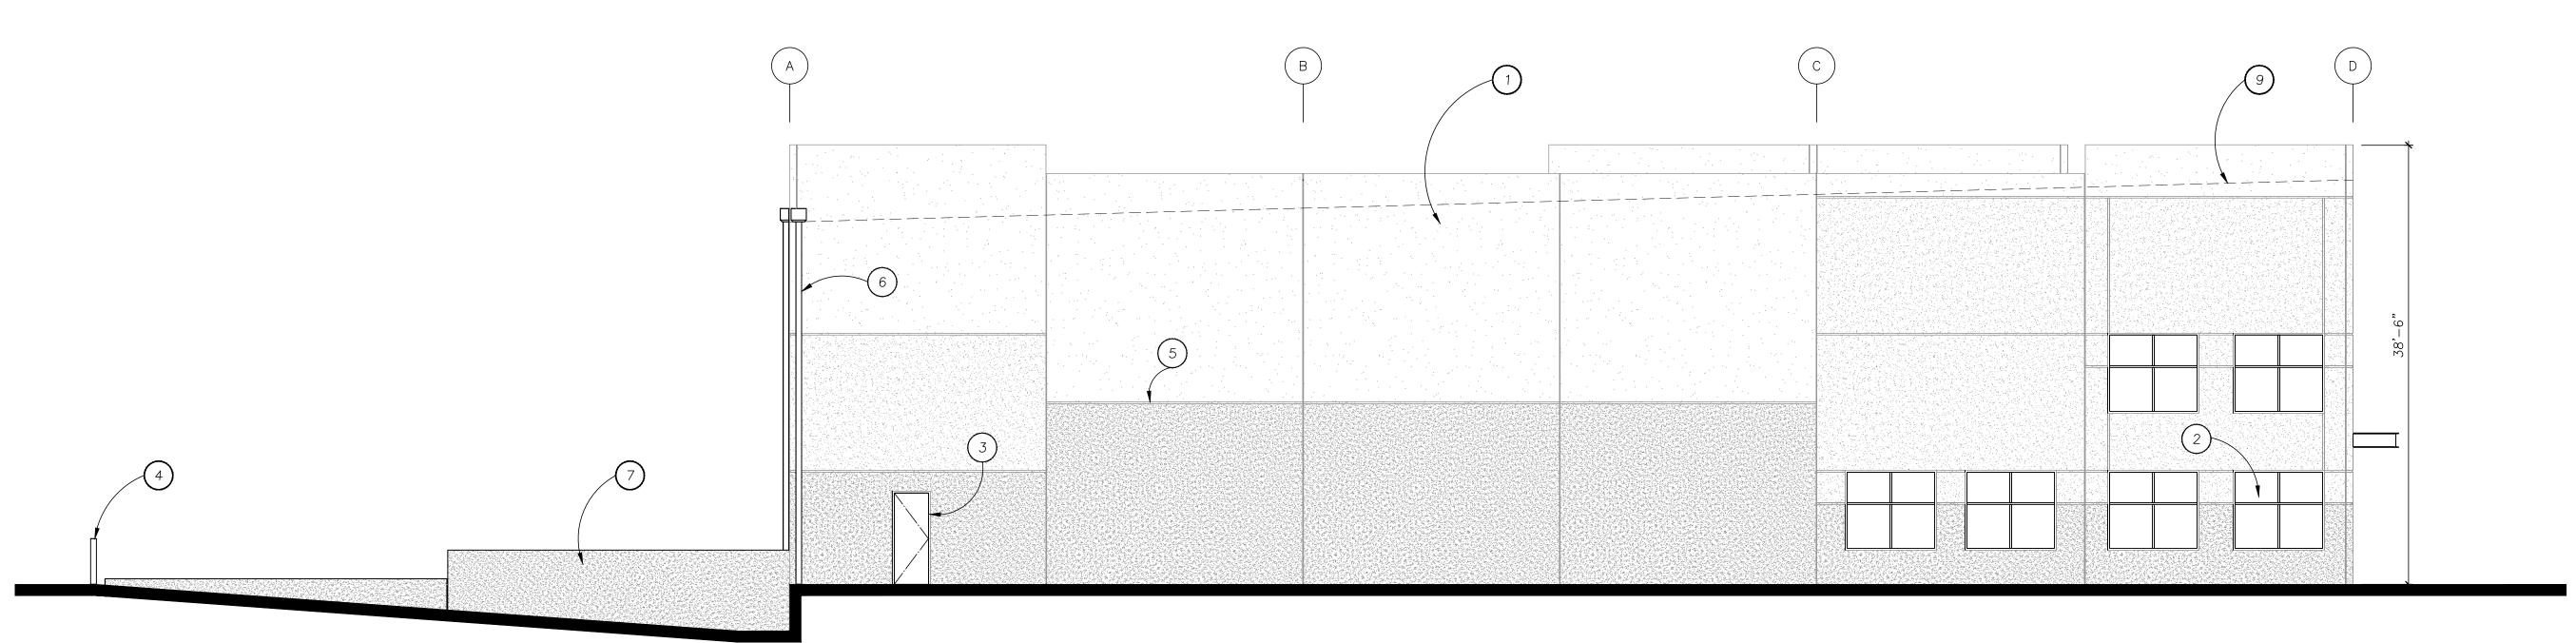

West Elevation

Scale: 1/8" = 1'-0"

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Lu Pacific Development Building

1005 SW Herman Road Tualatin, OR 97062

Sheet Title:

Building 2 Elevations


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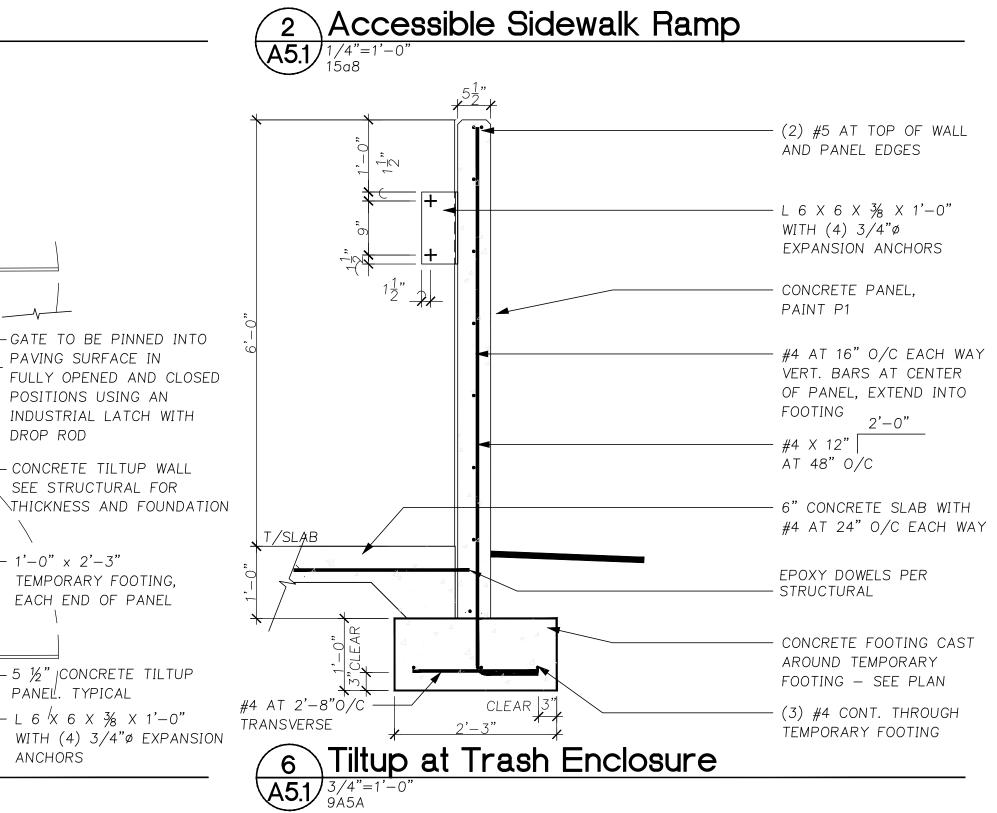
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Sheet

A 1 '1 1 1 P '





3" SMOOTH TROWELED JOINT, TYPICAL

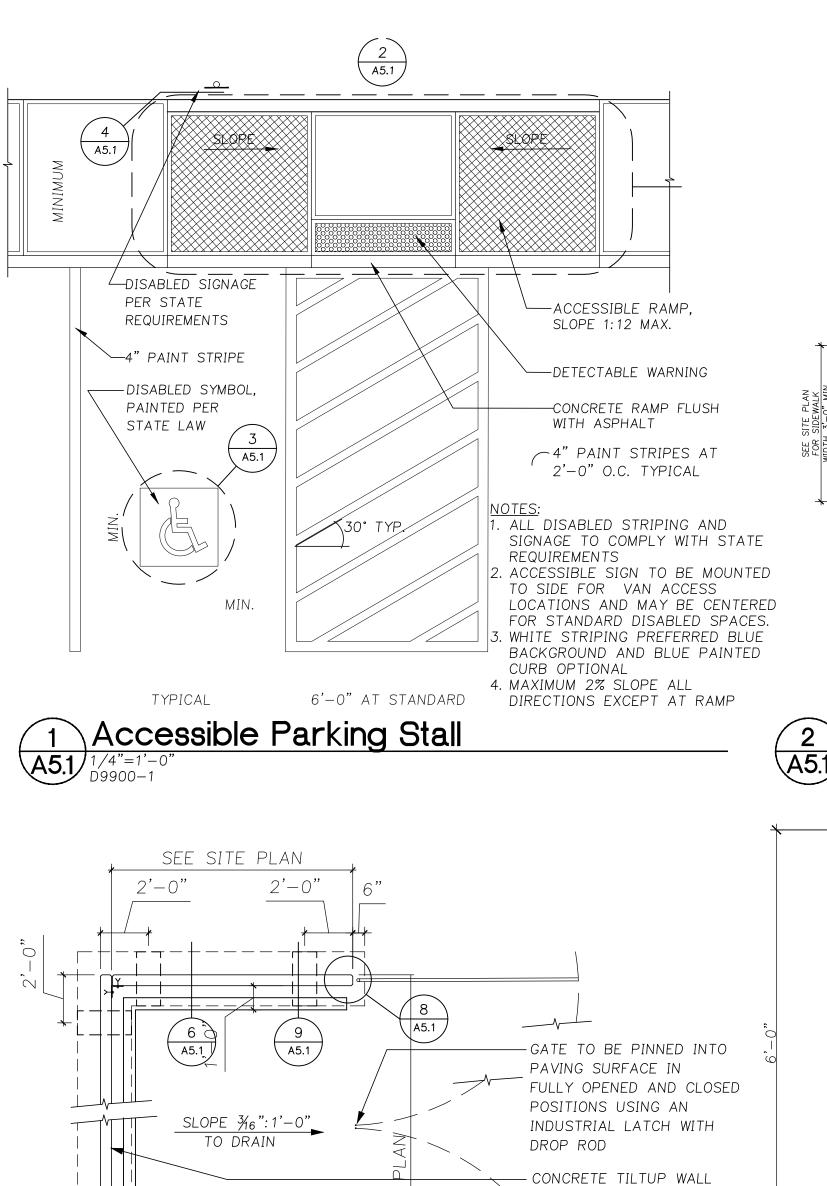STAMPED SLIP RESISTANT PATTERN

TACTILE WARNING WITH

CONTRASTING COLOR AT THROAT OF RAMP PER ANSI A117.1 SEC 406

WALK AND CURB

EVEN WITH PAVING

6'-0"

-WALK EVEN WITH

TOP OF CURB

SLOPING

-WALK AND CURB

(NET PATTERN SHOWN) PER ANSI A117.1 SEC 302


6" CURB LEVEL WITH SURFACE OF ADJACENT SIDEWALK


AND 705.5

PAVING___

\$10PE

6'-0"

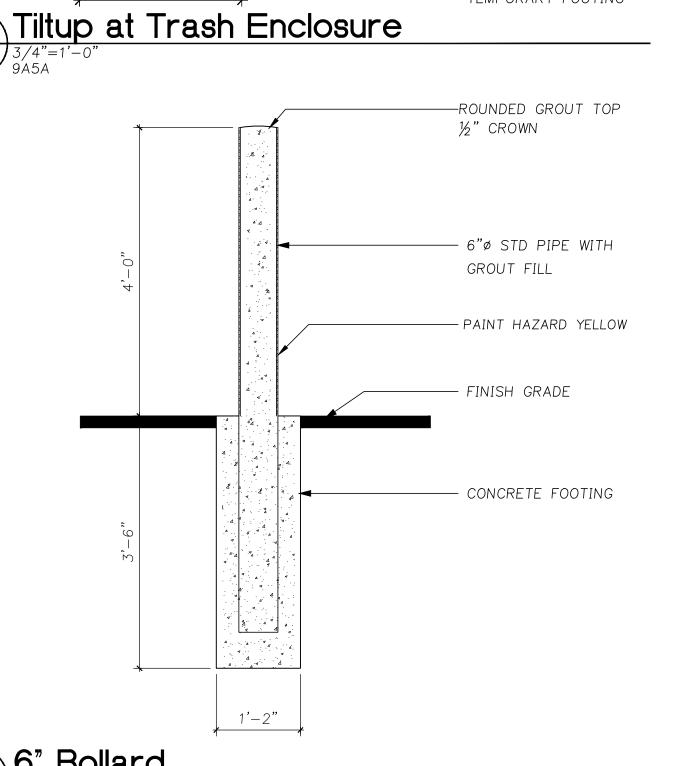

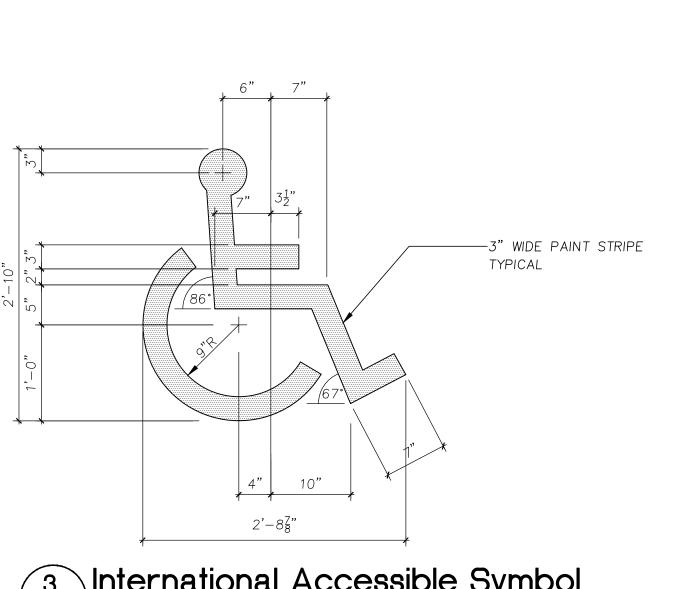

3 International Accessible Symbol

T/SLAB

SLOPED CURB TRANSITION

Gate at Trash Enclosure

5'-0"

PAVING

- PAINTED ACCESSIBLE ROUTE

STAMPED TACTILE PATTERN

WALK FLUSH WITH TOP OF CURB

LANDSCAPE—

— CAST-IN-PLACE CURB

PER UBC SECTION 1109.16 (NET PATTERN SHOWN)

BROOM FINISH

-GALV. STEEL GATE

CHAIN LINK GATE WITH

CEDAR SLATS AND FRAME

-CANE BOLTS FOR EACH LEAF


FOR CLOSED AND OPEN


-PIPE SLEEVE-EMBED 4"


FOR CLOSED AND OPEN


POSITIONS

POSITIONS

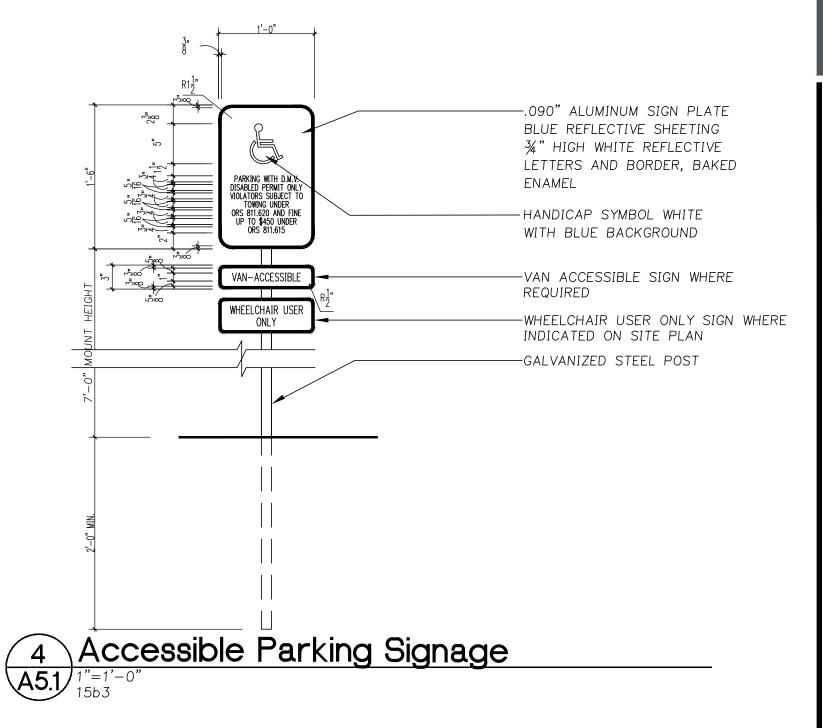

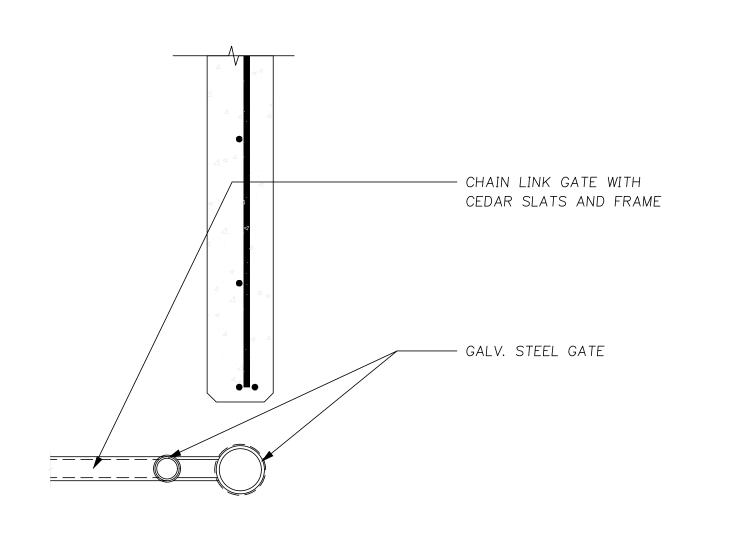

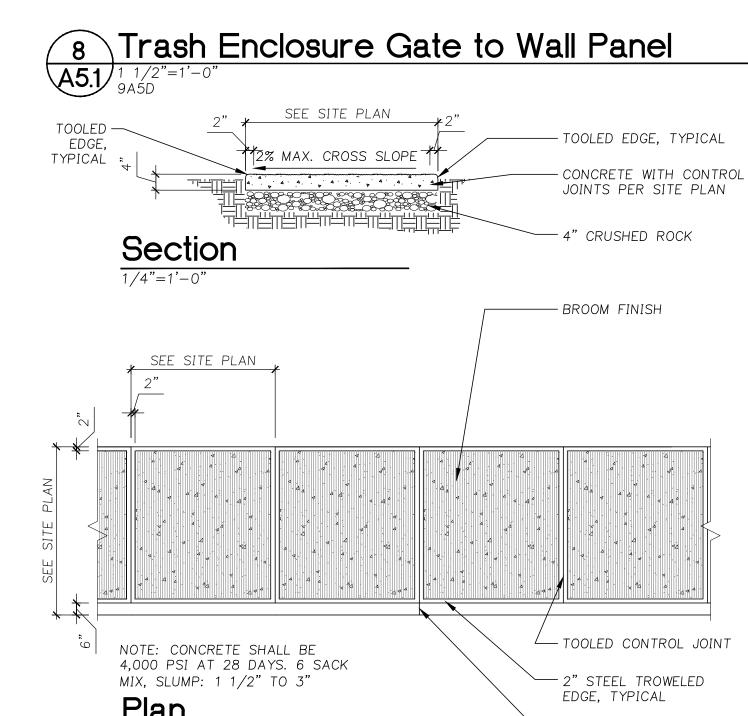

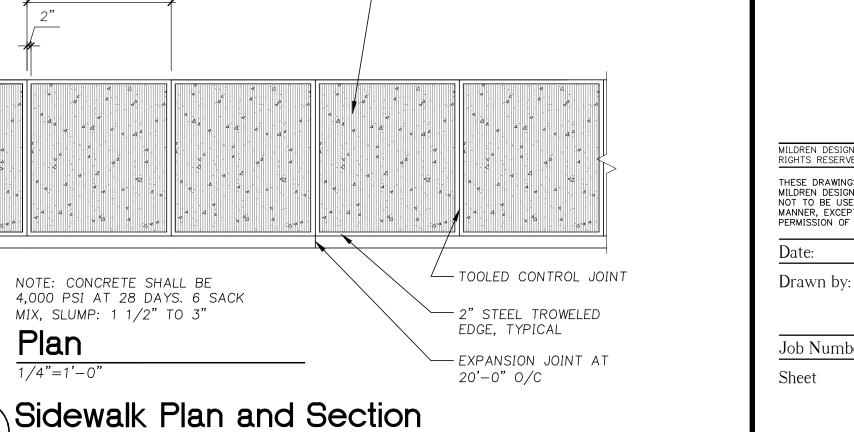





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Lu Pacific Development Building

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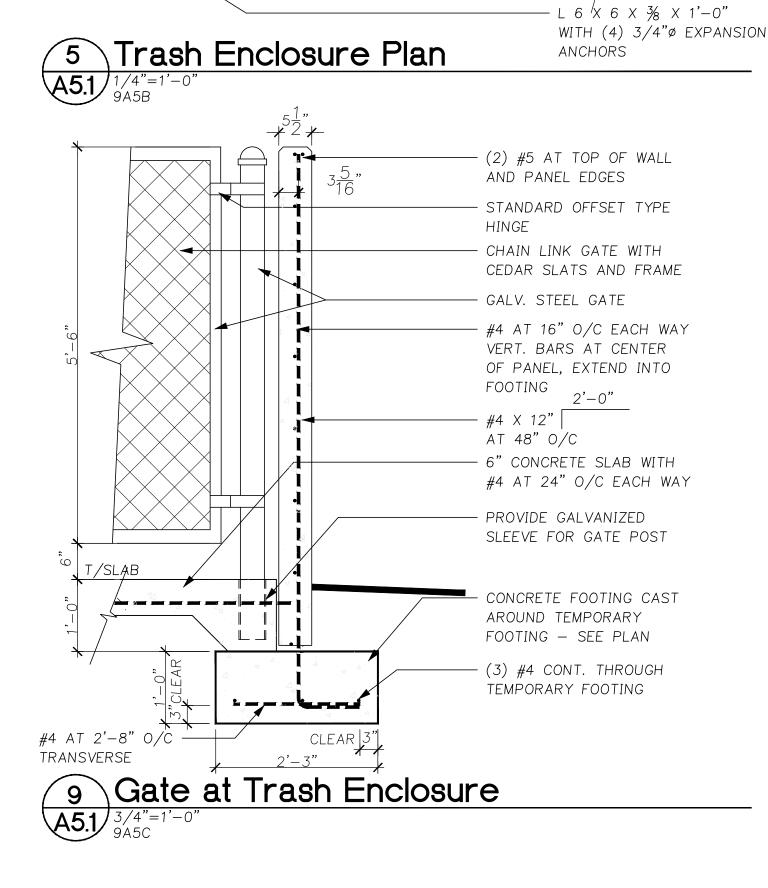
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Site Details

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TQL 117013 Job Number:



A5.1

2"-4" CONCRETE BUMPER AT

PERIMETER OF ENCLOSURE


 $-1'-0" \times 2'-3"$

PANEL. TYPICAL

TEMPORARY FOOTING,


EACH END OF PANEL

-5 ½" |CONCRETE TILTUP

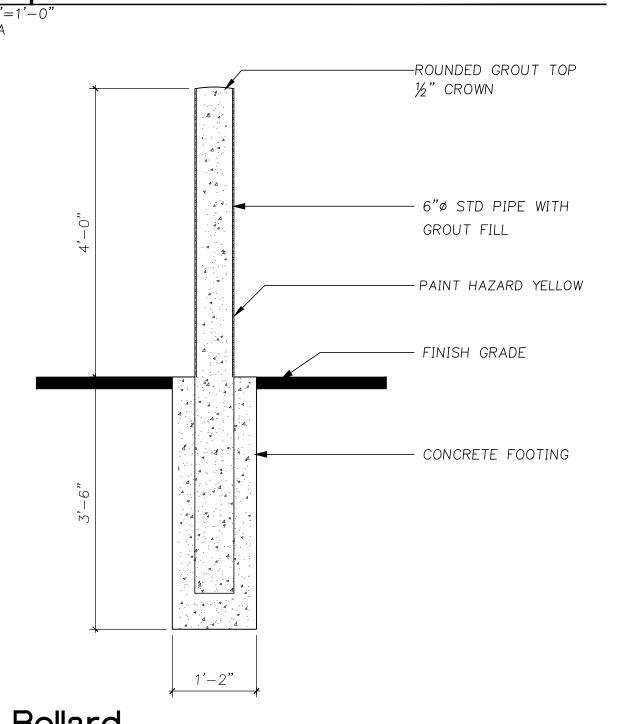


10 6" Bollard


Accessible Sidewalk Ramp

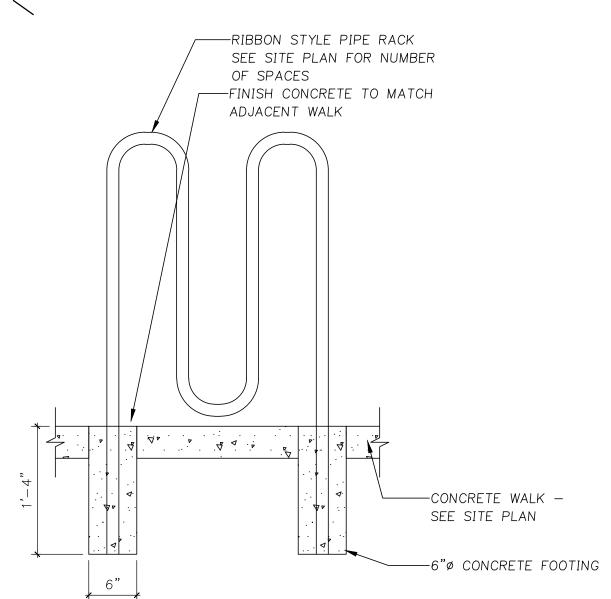


Metal Stair Section
A5.2 1 1/2"=1'-0"

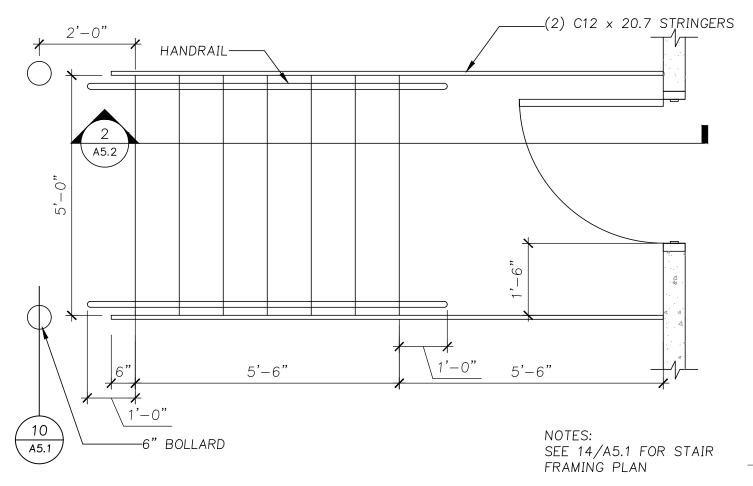

3 Metal Stair Section

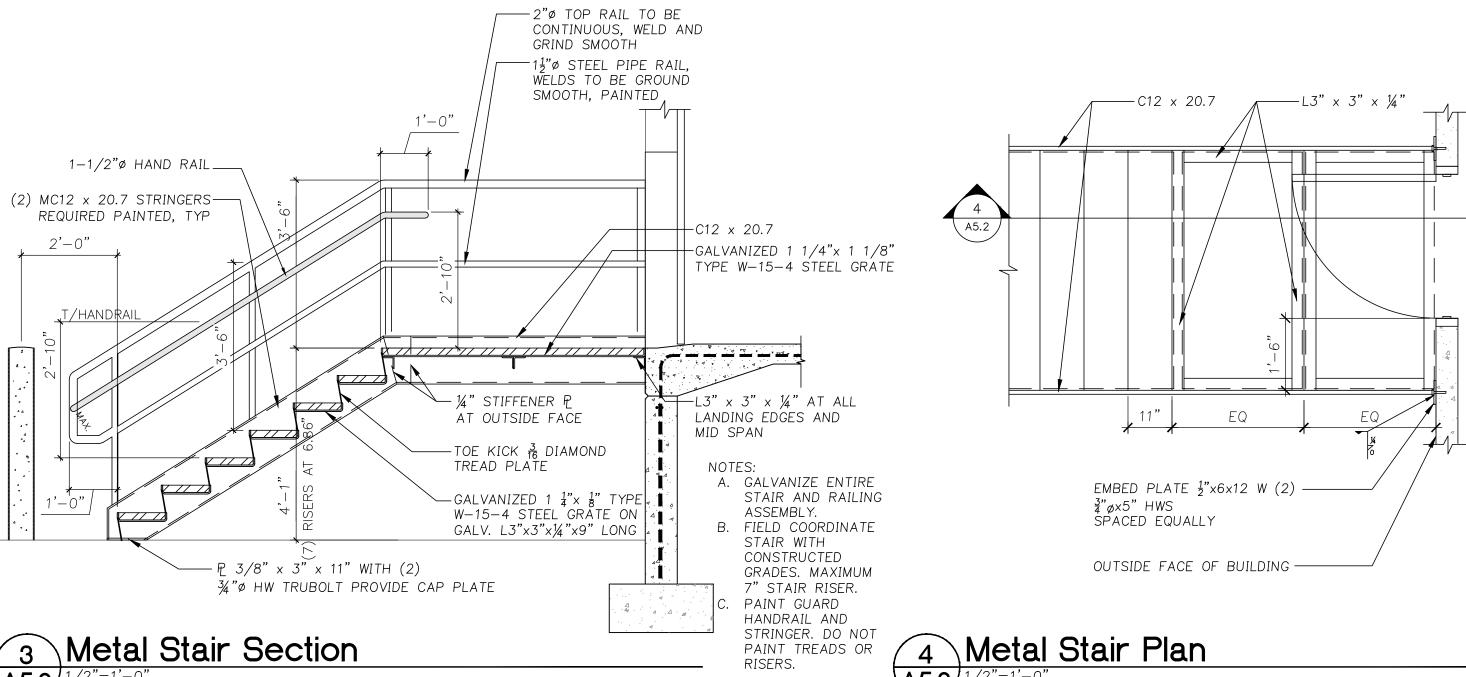

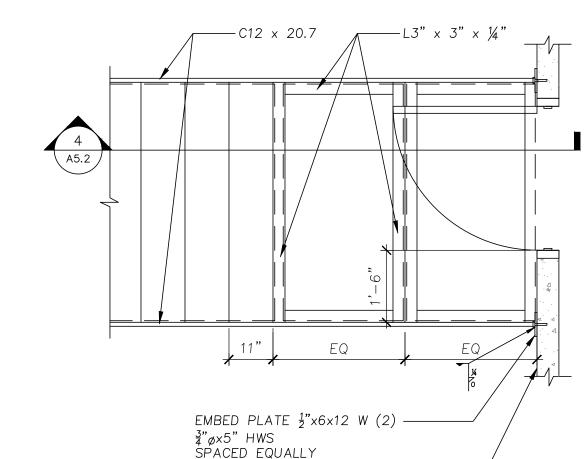

4 Metal Stair Plan

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Site Details

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117013 Job Number: Sheet

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