

RIVER RIDGE ADDITION

ARCHITECTURAL REVIEW PLANS

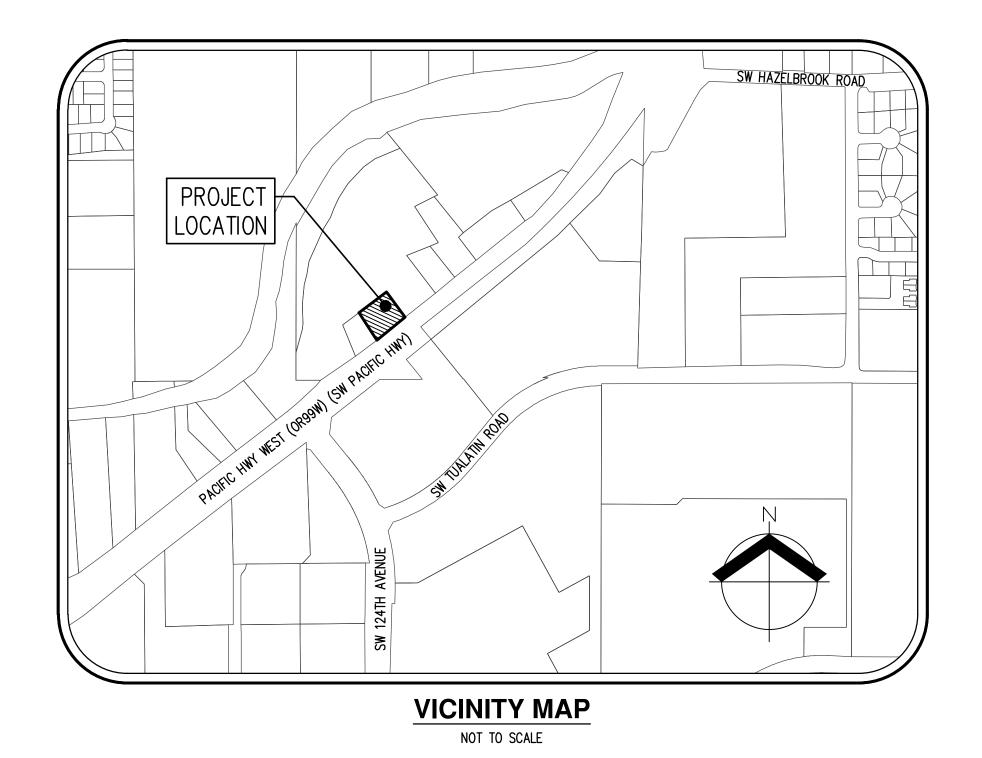

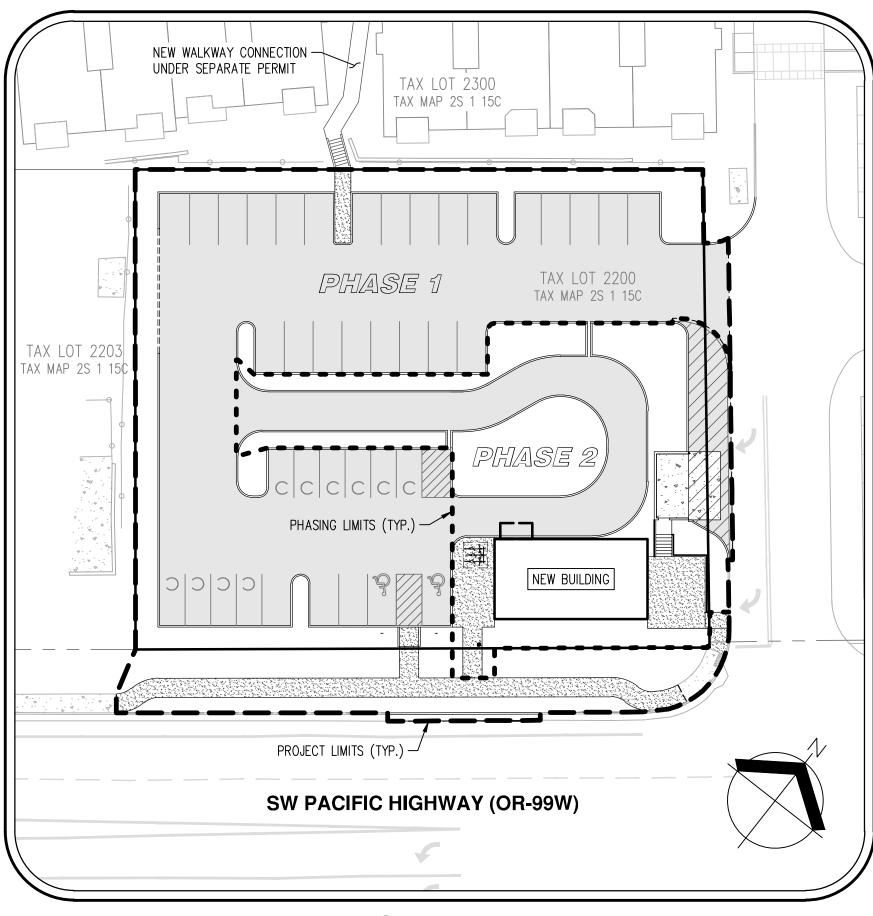

SITE MAP SCALE: 1" = 30'

PROJECT TEAM

APPLICANT

MOUNTAIN WEST INVESTMENT CORPORATION 201 FERRY STREET SE, SUITE 400 SALEM, OR 97301

ARCHITECTURE

BENNER STANGE ASSOCIATES ARCHITECTS, INC. 80 SE MADISON STREET, SUITE 430 PORTLAND, OR 97214

CIVIL ENGINEERING/SURVEYING/ARBORIST/ PLANNING/LANDSCAPE ARCHITECTURE

AKS ENGINEERING & FORESTRY, LLC. 12965 SW HERMAN ROAD, SUITE 100 TUALATIN, OR 97062 CONTACT: CHRIS GOODELL, AICP PHONE: 503.563.6151 FAX: 503.563.6152

LIGHTING/ELECTRICAL

CASCADE ELECTRICAL, LLC. PO BOX 160 BRUSH PRAIRIE, WA 98606

SHEET INDEX

PO1 - COVER SHEET WITH VICINITY AND SITE MAPS

PO2 - EXISTING CONDITIONS PLAN

PO3 - PRELIMINARY TREE PRESERVATION AND REMOVAL PLAN

PO4 - PRELIMINARY TREE PRESERVATION AND REMOVAL TABLE

PO5 - PRELIMINARY GRADING PLAN

PO6 - PRELIMINARY PHASE 1 GRADING PLAN

PO7 - PRELIMINARY COMPOSITE UTILITY PLAN

PO8 - PRELIMINARY PUBLIC FACILITIES PLAN

PO9 - PRELIMINARY LANDSCAPE PLAN

P10 - PRELIMINARY PHASE 1 LANDSCAPE PLAN

P11 - PRELIMINARY EASEMENT PLAN

P12 - PRELIMINARY CIRCULATION PLAN

P13 - PRELIMINARY LIGHTING PLAN

ARCHITECTURAL SITE PLAN

CONIFEROUS TREE STORM SEWER AREA DRAIN FIRE HYDRANT WATER BLOWOFF WATER METER WATER VALVE POWER PEDESTAL STREET LIGHT COMMUNICATIONS RISER MAILBOX **EXISTING BOUNDARY LINE** PROPERTY LINE CENTERLINE EDGE OF PAVEMENT EASEMENT FENCE LINE GRAVEL EDGE POWER LINE OVERHEAD WIRE COMMUNICATIONS GAS LINE SANITARY SEWER LINE

LEGEND

STORM SEWER CLEAN OUT

PROPOSED

DECIDUOUS TREE

PROPERTY DESCRIPTION:

LOCATED IN THE SOUTHWEST ONE-QUARTER OF SECTION 15, TOWNSHIP 2 SOUTH, RANGE 1 WEST, WILLAMETTE MERIDIAN, CITY OF TUALATIN, WASHINGTON COUNTY, OREGON.

(WASHINGTON COUNTY ASSESSOR'S MAP 2S 1 15C TAX LOT 2200).

PROJECT DESCRIPTION

CONSTRUCTION OF ON-SITE PARKING, DRIVE AISLES, A NEW COMMERCIAL BUILDING, A GARBAGE AND RECYCLING ENCLOSURE, AND WALKWAYS. THE EXISTING ACCESS TO PACIFIC HIGHWAY WEST WILL BE CLOSED AND NEW ACCESS WILL BE TAKEN FROM THE EXISTING RIVER RIDGE APARTMENTS DRIVEWAY.

TOTAL SITE AREA

±0.61 ACRES




PROPOSED

5

COVEF

DATE: 05/08/2019

JOB NUMBER

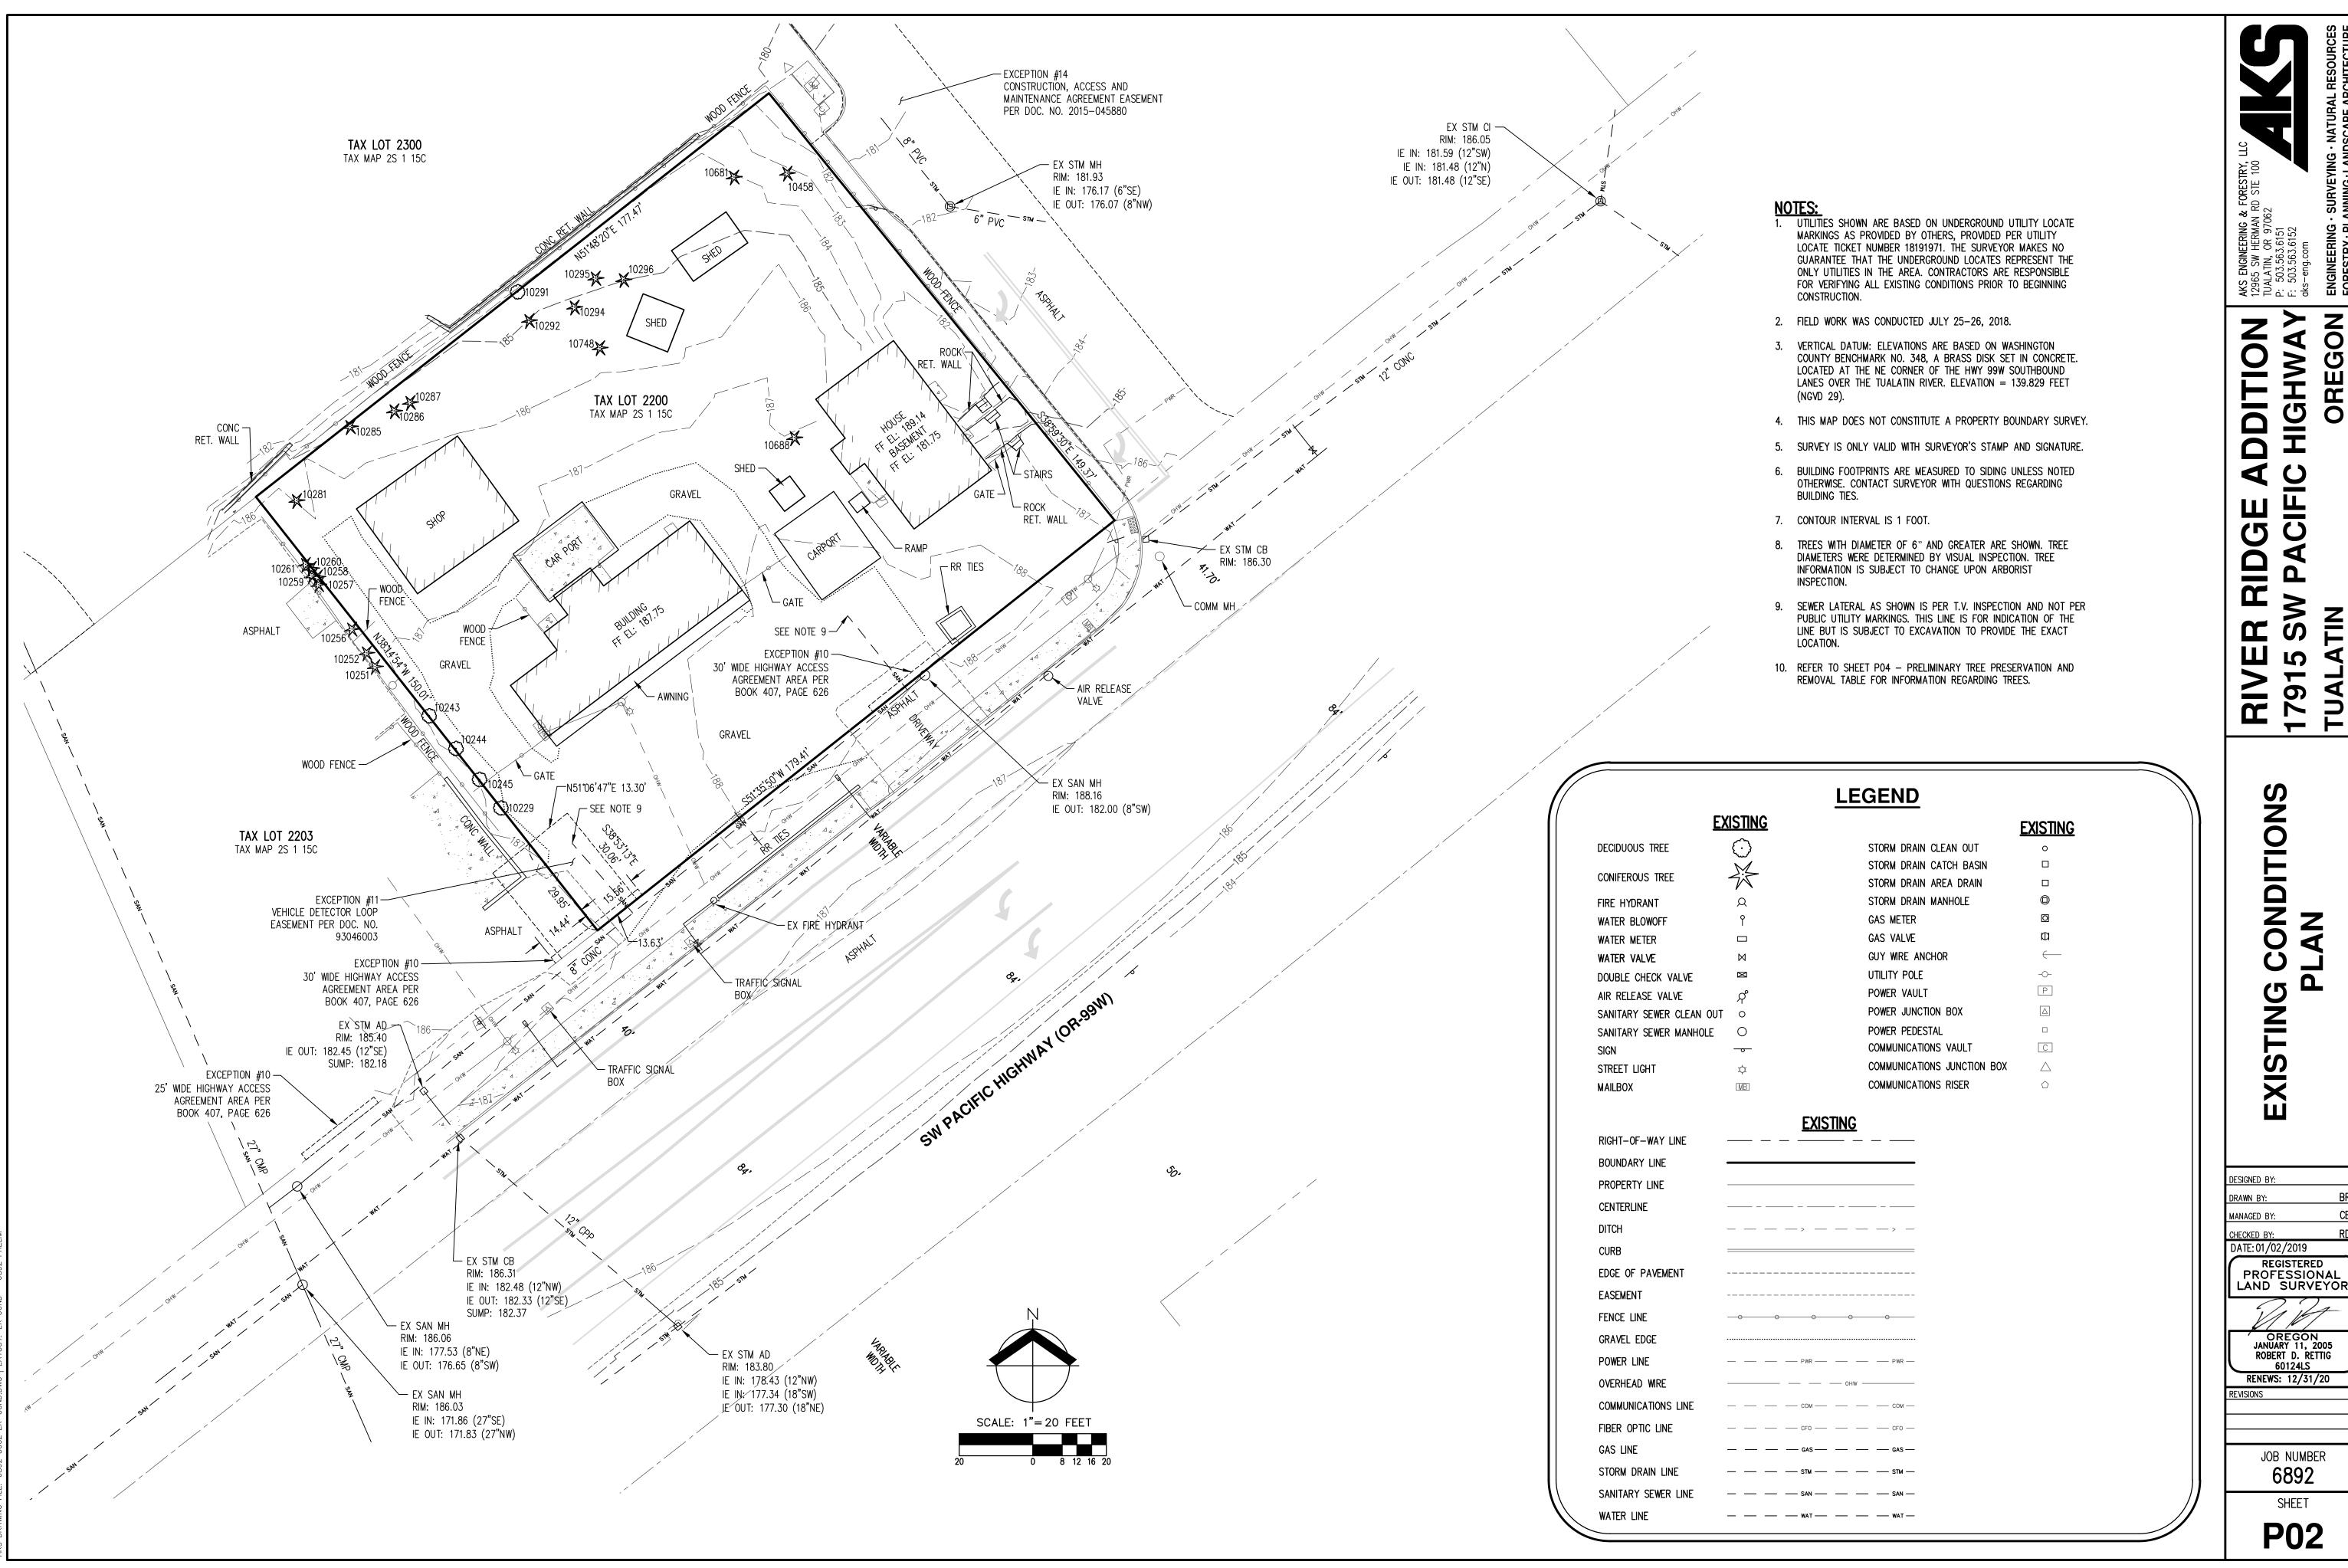



<u>0</u> ZZ

DATE: 01/02/2019 REGISTERED PROFESSIONAL

JANUARY 11, 2005 ROBERT D. RETTIG 60124LS RENEWS: 12/31/20

JOB NUMBER

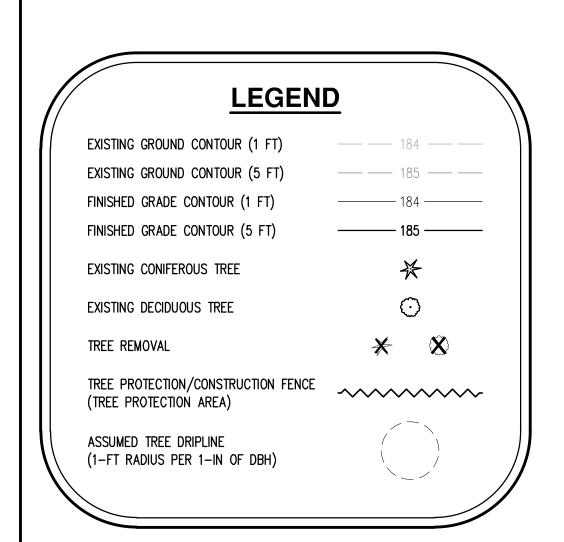


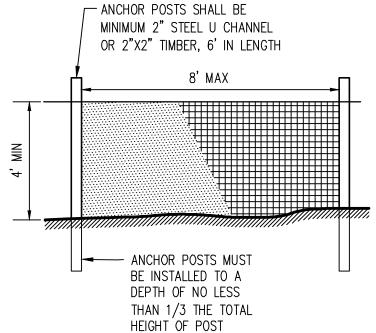

- 1. CHAIN LINK FENCE FOR TREE PROTECTION DEVICE OR
- 2. AVOID DAMAGE TO CRITICAL ROOT ZONE. DO NOT DAMAGE OR SEVER LARGE ROOTS WHEN INSTALLING POSTS.

 3. DEVICE SHALL BE MAINTAINED THROUGHOUT CONSTRUCTION.

- ENCROACHMENTS (GRADING, CONSTRUCTION, ETC.) INTO ASSUMED TREE ROOT ZONES OUTSIDE OF THE TREE PROTECTION AREA OF TREES TO BE PRESERVED AS SHOWN SHOULD NOT HAVE SIGNIFICANT NEGATIVE IMPACTS TO TREE HEALTH. THIS PLAN HAS BEEN REVIEWED BY A CERTIFIED ARBORIST PER TDC 73.250(2)(E).
- 2. GRADING ACTIVITIES SHALL NOT INCLUDE ALLOWING TREE ROOTS FROM PRESERVED TREES TO REMAIN EXPOSED PER TDC 73.250(2)(F).
- PER TDC 31.060, A TREE IS DEFINED AS AT LEAST EIGHT (8) INCHES IN DIAMETER AT BREAST HEIGHT (DBH). THEREFORE, ALL TREES WITH A DBH OF 8 INCHES OR GREATER ARE SHOWN. SOME ADDITIONAL TREES UNDER 8 INCHES IN DBH ARE SHOWN. SEE SHEET PO4 FOR ADDITIONAL INFORMATION.

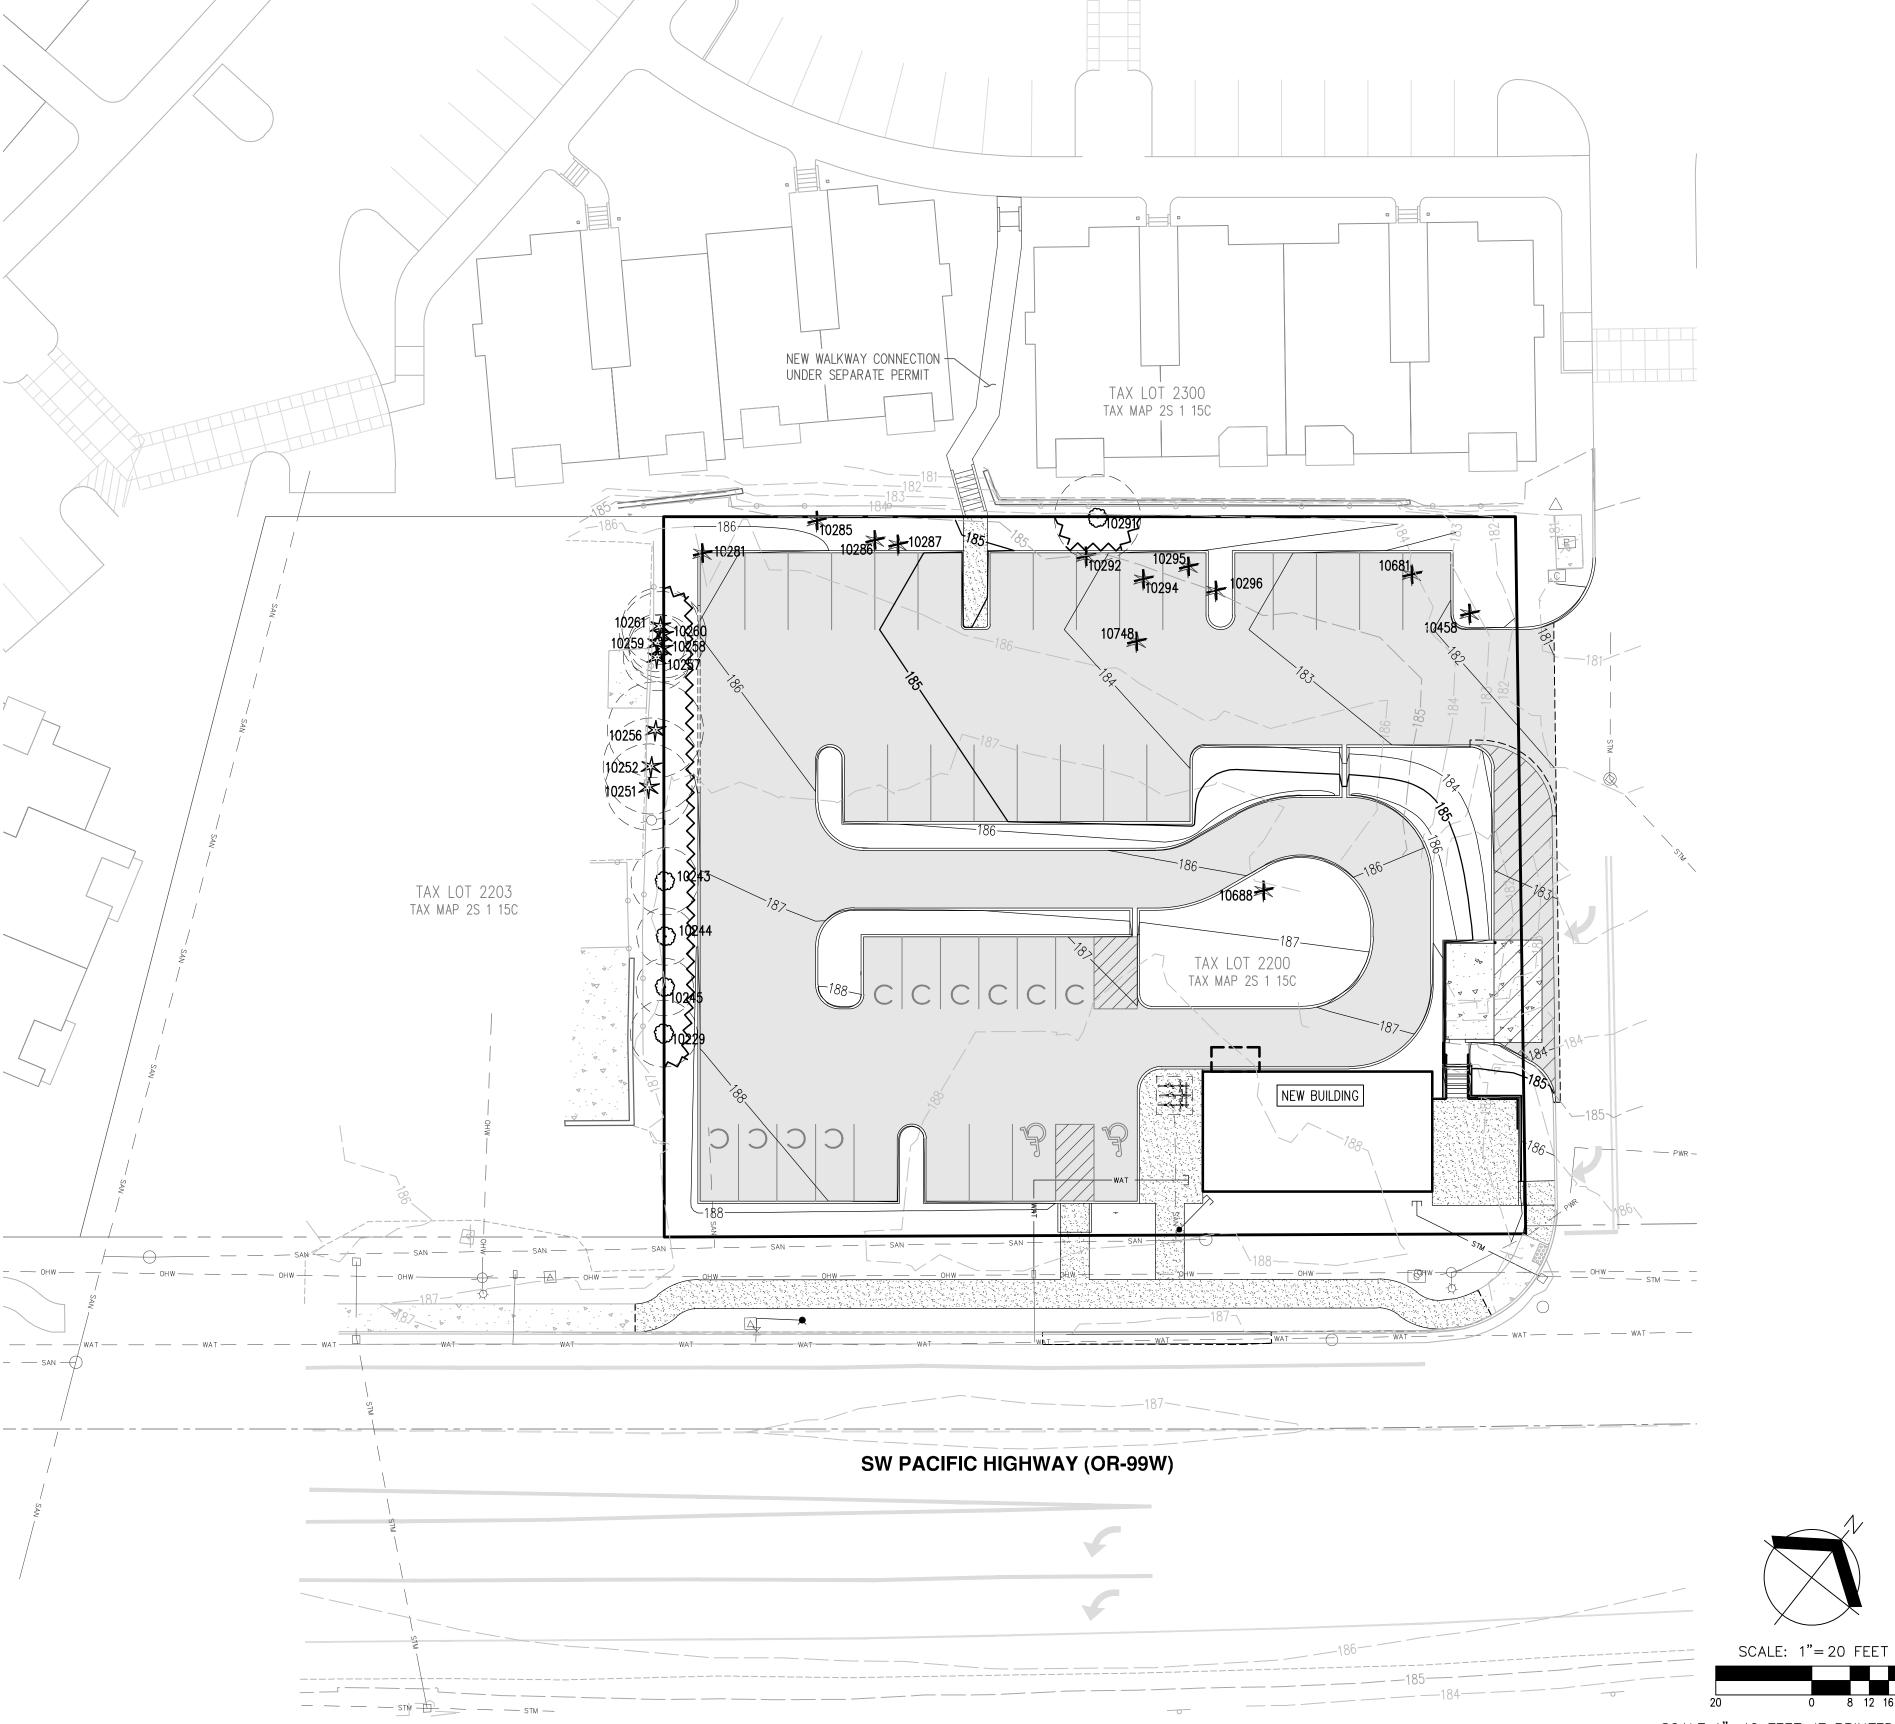



SCALE 1"=40 FEET IF PRINTED 11"X17" NOT TO SCALE IF PRINTED 8.5"X11" BRUCE R. BALDWIN CERTIFICATE NUMBER: PN-6666A EXPIRATION DATE: 12/31/20

DATE: 05/08/2019

DDITION

RIDGE

TREE

PRELIMIN

PRE

JOB NUMBER

SHEET

APPROVED EQUAL.

AKS Job No. 6892 - Evaluation Date: 10/23/2018

Tree #	DBH (in.)	Avg. Crown Radius (ft)	Tree Species Common Name (S <i>cientific name</i>)	Comments		Structure Rating**	Remove/Preserve	;
10229	7	10	Black Cottonwood (<i>Populus trichocarpa</i>)	OFFSITE; Codominant top	1	2	Preserve	***
10243	7	10	Black Cottonwood (<i>Populus trichocarpa</i>)	Codominant top	1	2	Preserve	***
10244	6	10	Black Cottonwood (<i>Populus trichocarpa</i>)		1	1	Preserve	***
10245	6	10	Black Cottonwood (<i>Populus trichocarpa</i>)	Codominant top	1	1	Preserve	***
10251	9	4	Arborvitae (<i>Thuja sp.</i>)	OFFSITE; Lean (N); Codominant top; Cavity on bole with visible decay	3	3	Preserve	
10252	10	2	Arborvitae (<i>Thuja sp.</i>)	OFFSITE; Lean (N); Codominant top; Nearing whole tree failure; Cavity on bole with visible decay	3	3	Preserve	
10256	10	5	Arborvitae (<i>Thuja sp.</i>)	OFFSITE; Lean (N); Codominant top; Nearing whole tree failure;	2	3	Preserve	
10257	6,7,7	4	Arborvitae (<i>Thuja sp.</i>)	OFFSITE; Codominant; All stems lean (S)	1	2	Preserve	***
10258	7	2	Arborvitae (<i>Thuja sp.</i>)	OFFSITE; Lean (E)	1	2	Preserve	***
10259	6	0	Arborvitae (<i>Thuja sp.</i>)	OFFSITE; Dead	3	3	Preserve	***
10260	9	4	Arborvitae (<i>Thuja sp.</i>)	OFFSITE; Lean (NW); Codominant top	1	2	Preserve	
10261	8	2	Arborvitae (<i>Thuja sp.</i>)	OFFSITE; Lean (N); Codominant top	1	2	Preserve	
10281	77	12	Giant Sequoia (Sequioadendron giganteum)	Canopy mostly one-sided (S)	1	1	Remove	
10285	6	2	Arborvitae (<i>Thuja sp.</i>)	Lean (N); Codominant top; Sparse canopy; Declining	3	2	Remove	***
10286	28	14	Douglas-fir (Pseudotsuga menziesii)	Canopy mostly one-sided (W)	1	1	Remove	
10287	22	12	Douglas-fir (Pseudotsuga menziesii)		1	1	Remove	
10291	9	12	Sweet Cherry (<i>Prunus avium</i>)	Topped; Codominant top; Lean (N); Limbs removed mechanically	2	2	Preserve	
10292	40	16	Douglas-fir (Pseudotsuga menziesii)		1	1	Remove	
10294	21	10	Douglas-fir (Pseudotsuga menziesii)	Some dead limbs; Sap flow	2	1	Remove	
10295	31	16	Douglas-fir (Pseudotsuga menziesii)	Slightlean (N); Some dead limbs	1	1	Remove	
10296	38	18	Douglas-fir (Pseudotsuga menziesii)	Some dead limbs; Slight lean (S)	1	1	Remove	
10458	62	14	Giant Sequoia (Sequioadendron giganteum)	Canopy mostly one-sided (W)	1	1	Remove	
10681	32	12	Douglas-fir (Pseudotsuga menziesii)	Some dead limbs; Sweep	2	2	Remove	
10688	6,6	5	American Holly (<i>Ilex opaca</i>)	Codominant; Cluster; Some dead limbs; Bore holes	2	2	Remove	***
10748	65	12	Giant Sequoia (Sequioadendron giganteum)	Pruning scars with good wondwood closure	1	1	Remove	

Total # of Existing Trees Inventoried = 25

Total # of Existing Onsite Trees = 16

Total # of Existing Onsite Regulated Trees to be Preserved = 1

Total # of Existing Onsite Regulated Trees to be Removed = 10

Total # of Existing Onsite Unregulated Trees to be Preserved = 3

Total # of Existing Onsite Unregulated Trees to be Removed = 2

Total # of Existing Offsite Trees = 9

Total # of Existing Offsite Regulated Trees to be Preserved = 5

Total # of Existing Offsite Regulated Trees to be Removed = 0

Total # of Existing Offsite Unregulated Trees to be Preserved = 4

Total # of Existing Offsite Unregulated Trees to be Removed = 0

*Health Rating:

1 = Good Health - A tree that exhibits typical foliage, bark, and root characteristics, for its respective species, shows no signs of infection or infestation, and has a high level of vigor and vitality.

2 = Fair Health - A tree that exhibits some abnormal health characteristics and/or shows some signs of infection or infestation, but may be reversed or abated with supplemental treatment.

3 = Poor Health - A tree that is in significant decline, to the extent that supplemental treatment would not likely result in reversing or abating its decline.

**Structure Rating:

1 = Good Structure - A tree that exhibits typical physical form characteristics, for its respective species, shows no signs of structural defects of the canopy, trunk, and/or root system.

2 = Fair Structure - A tree that exhibits some abnormal physical form characteristics and/or some signs of structural defects, which reduce the structural integrity of the tree, but are not indicative of imminent physical failure, and may be corrected using arboricultural abatement methods.

3 = Poor Structure - A tree that exhibits extensively abnormal physical form characteristics and/or significant structural defects that substantially reduces the structural viability of the tree, cannot feasibly be abated, and are indicative of imminent physical failure.

Regulated Trees: Tualatin Developmen

Tualatin Development code (TDC) 34.200 regulates tree removal. Per TDC 31.060, a tree is defined as at least eight (8) inches in diameter at breast height (DBH). Relevant trees with a DBH under 8 inches are also shown on this plan.

Arborist Disclosure Statement:

Arborists are tree specialists who use their education, knowledge, training, and experience to examine trees, recommend measures to enhance the health of trees, and attempt to reduce the risk of living near trees. The Client and Jurisdiction may choose to accept or disregard the recommendations of the arborist, or seek additional advice. Arborists cannot detect every condition that could possibly lead to the structural failure of a tree. Trees are living organisms that fail in ways we do not fully understand. Conditions are often hidden within trees and below ground. Arborists cannot guarantee that a tree will be healthy or safe under all circumstances, or for a specified period of time. Likewise, remedial treatments, like medicine, cannot be guaranteed. Trees can be managed, but they cannot be controlled. To live near trees is to accept some degree of risk. The only way to eliminate all risk associated with trees is to eliminate all trees. Neither this author nor AKS Engineering & Forestry, LLC have assumed any responsibility for liability associated with the trees on or adjacent to this site.

At the completion of construction, all trees should once again be reviewed. Land clearing and removal of adjacent trees can expose previously unseen defects and otherwise healthy trees can be damaged during construction.

***<u>NOTE:</u>

THESE TREES ARE UNDER 8" IN DBH AND THEREFORE ARE NOT REGULATED PER TDC 31.060



RIVER RIDGE ADDITION
7915 SW PACIFIC HIGHWAY

PRELIMINARY TREE
PRESERVATION ANI

DESIGNED BY: WJE

DRAWN BY: EDS


MANAGED BY: CEC

CHECKED BY: CEC

DATE: 05/08/2019

REVISIONS

JOB NUMBER **6892**

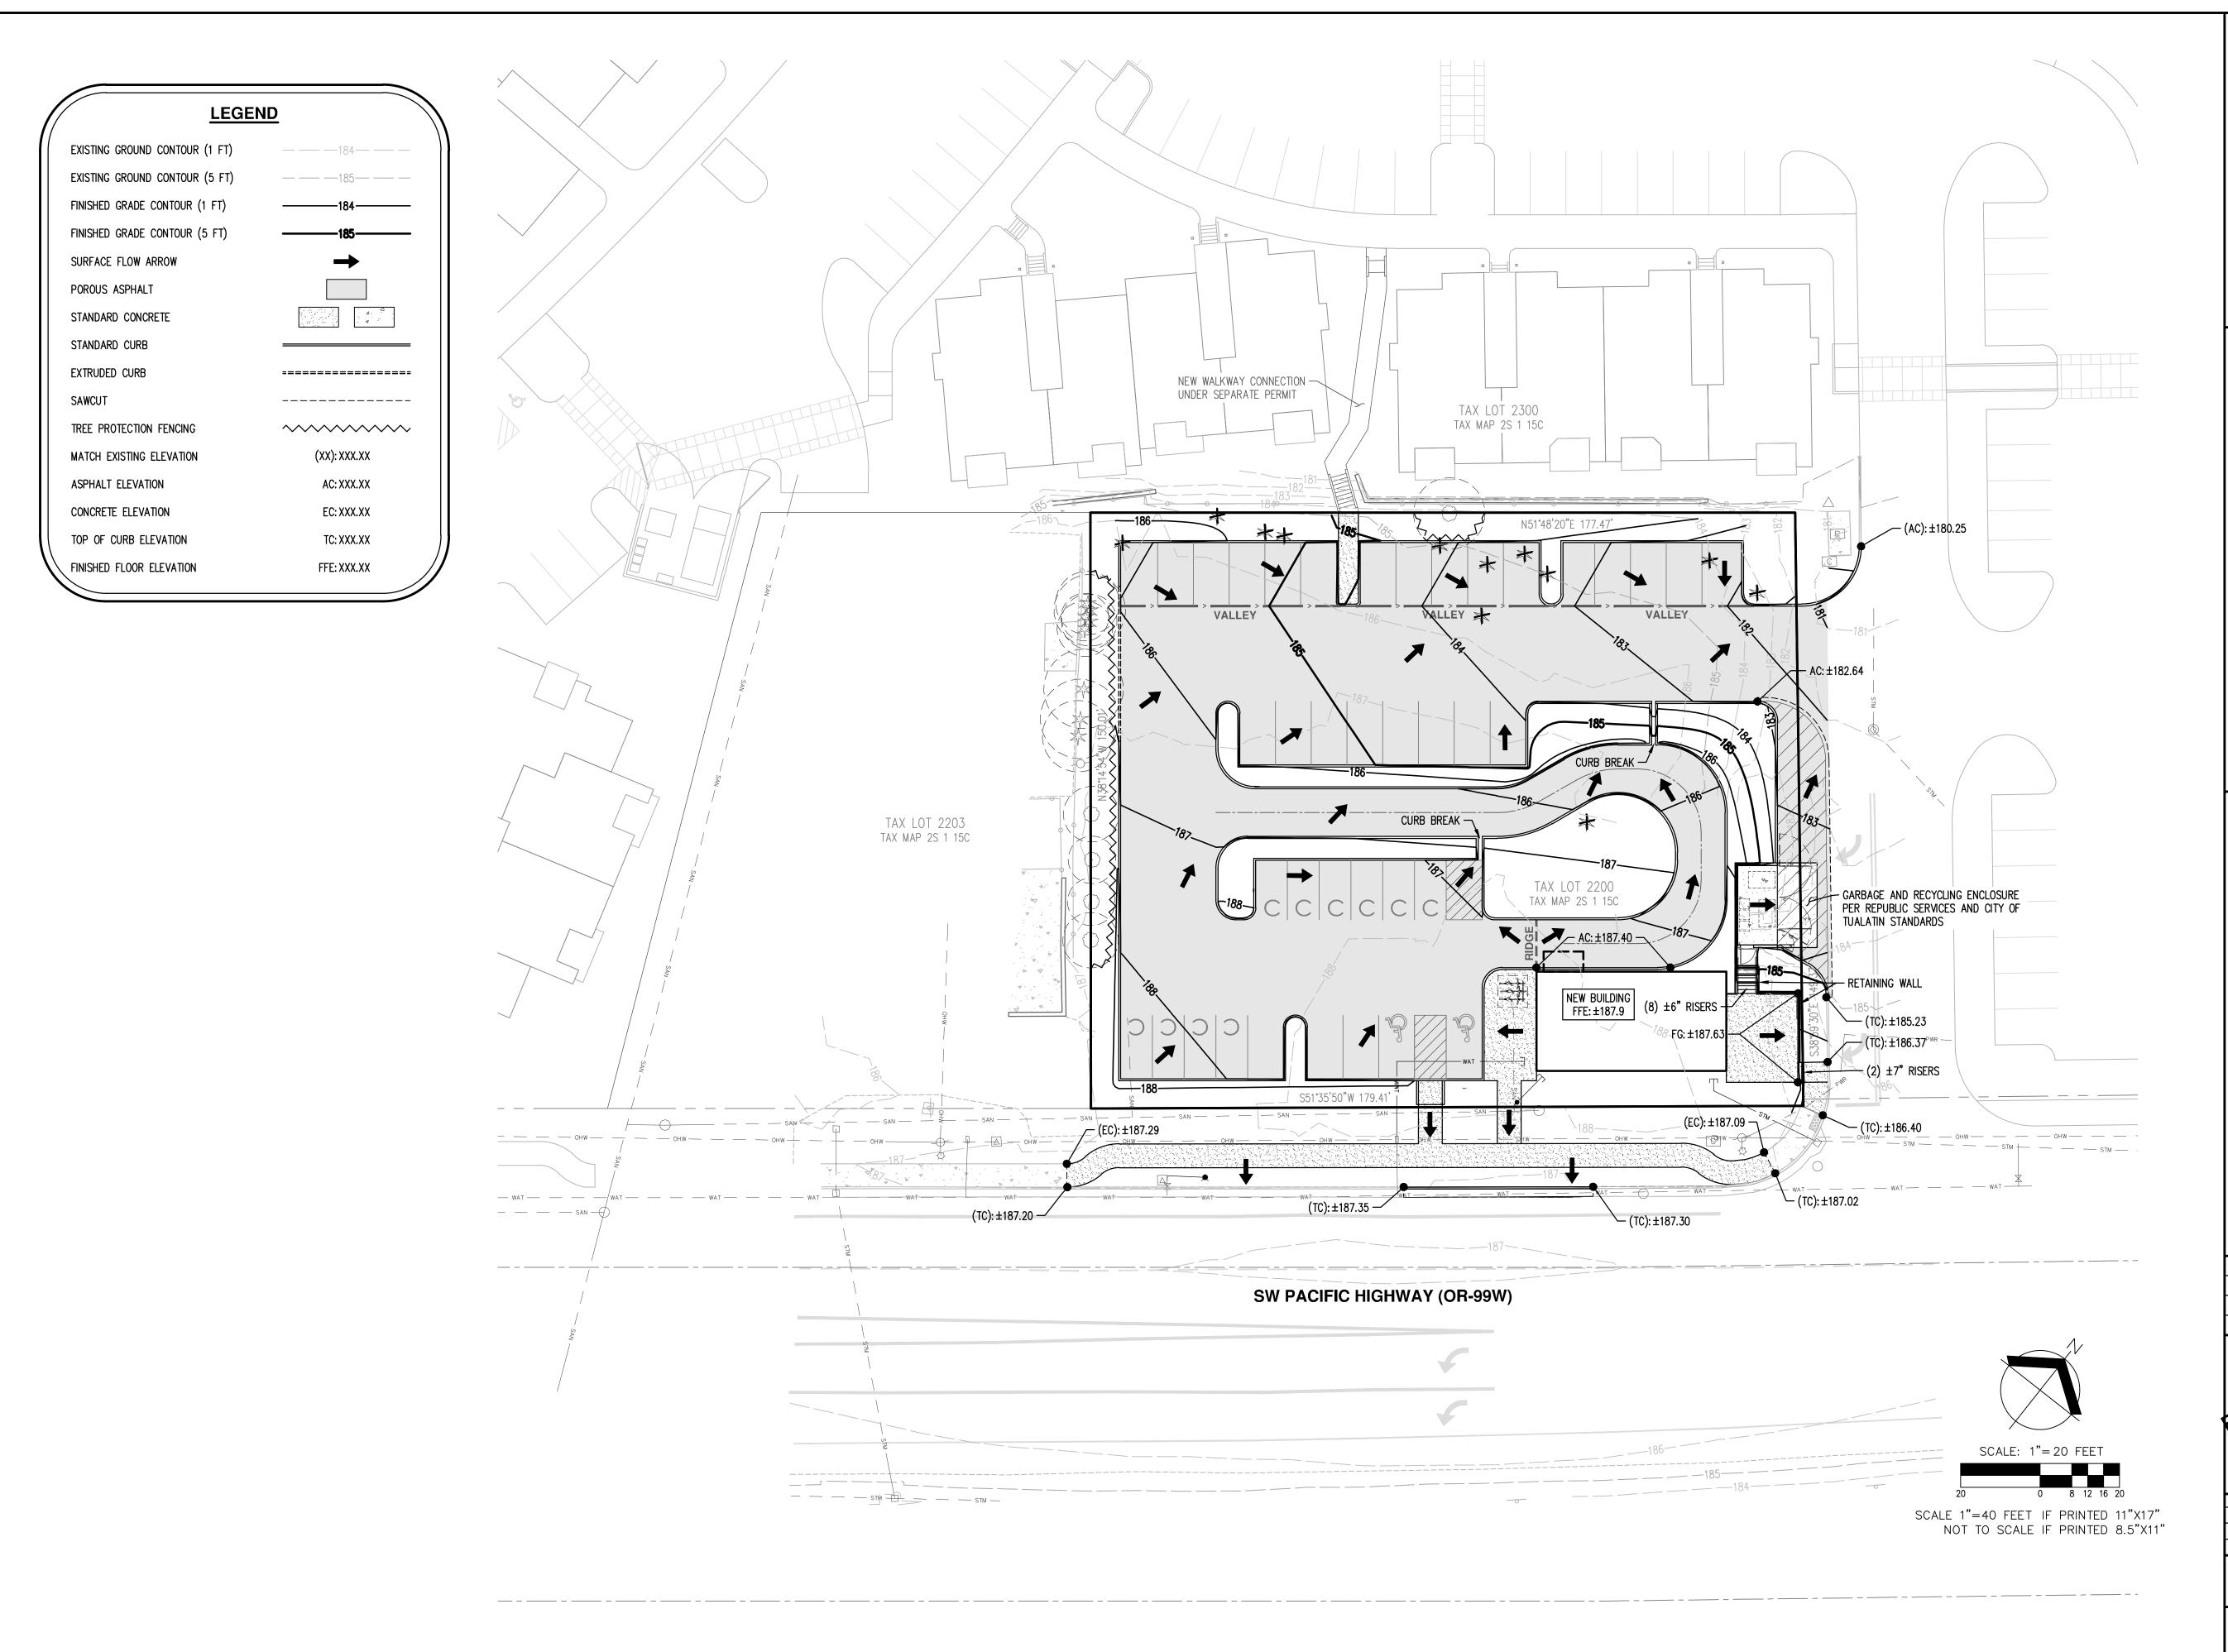

RIDGE ADDITION
12965 SITUALATI
SW PACIFIC HIGHWAY
12015 STATE
1201

PRELIMINARY GRADING PLAN

RIVEI 17915 (TUALA)

DESIGNED BY:

DRAWN BY:

MANAGED BY:

CHECKED BY:

CE

DATE: 05 /08 /2019

DATE: 05/08/2019

DATE: 05/08/2019

DATE: 05/08/2019


DATE: 05/08/2019

DATE: 05/08/2019

RENEWS: JUNE VISIONS

JOB NUMBER **6892**

SHEET

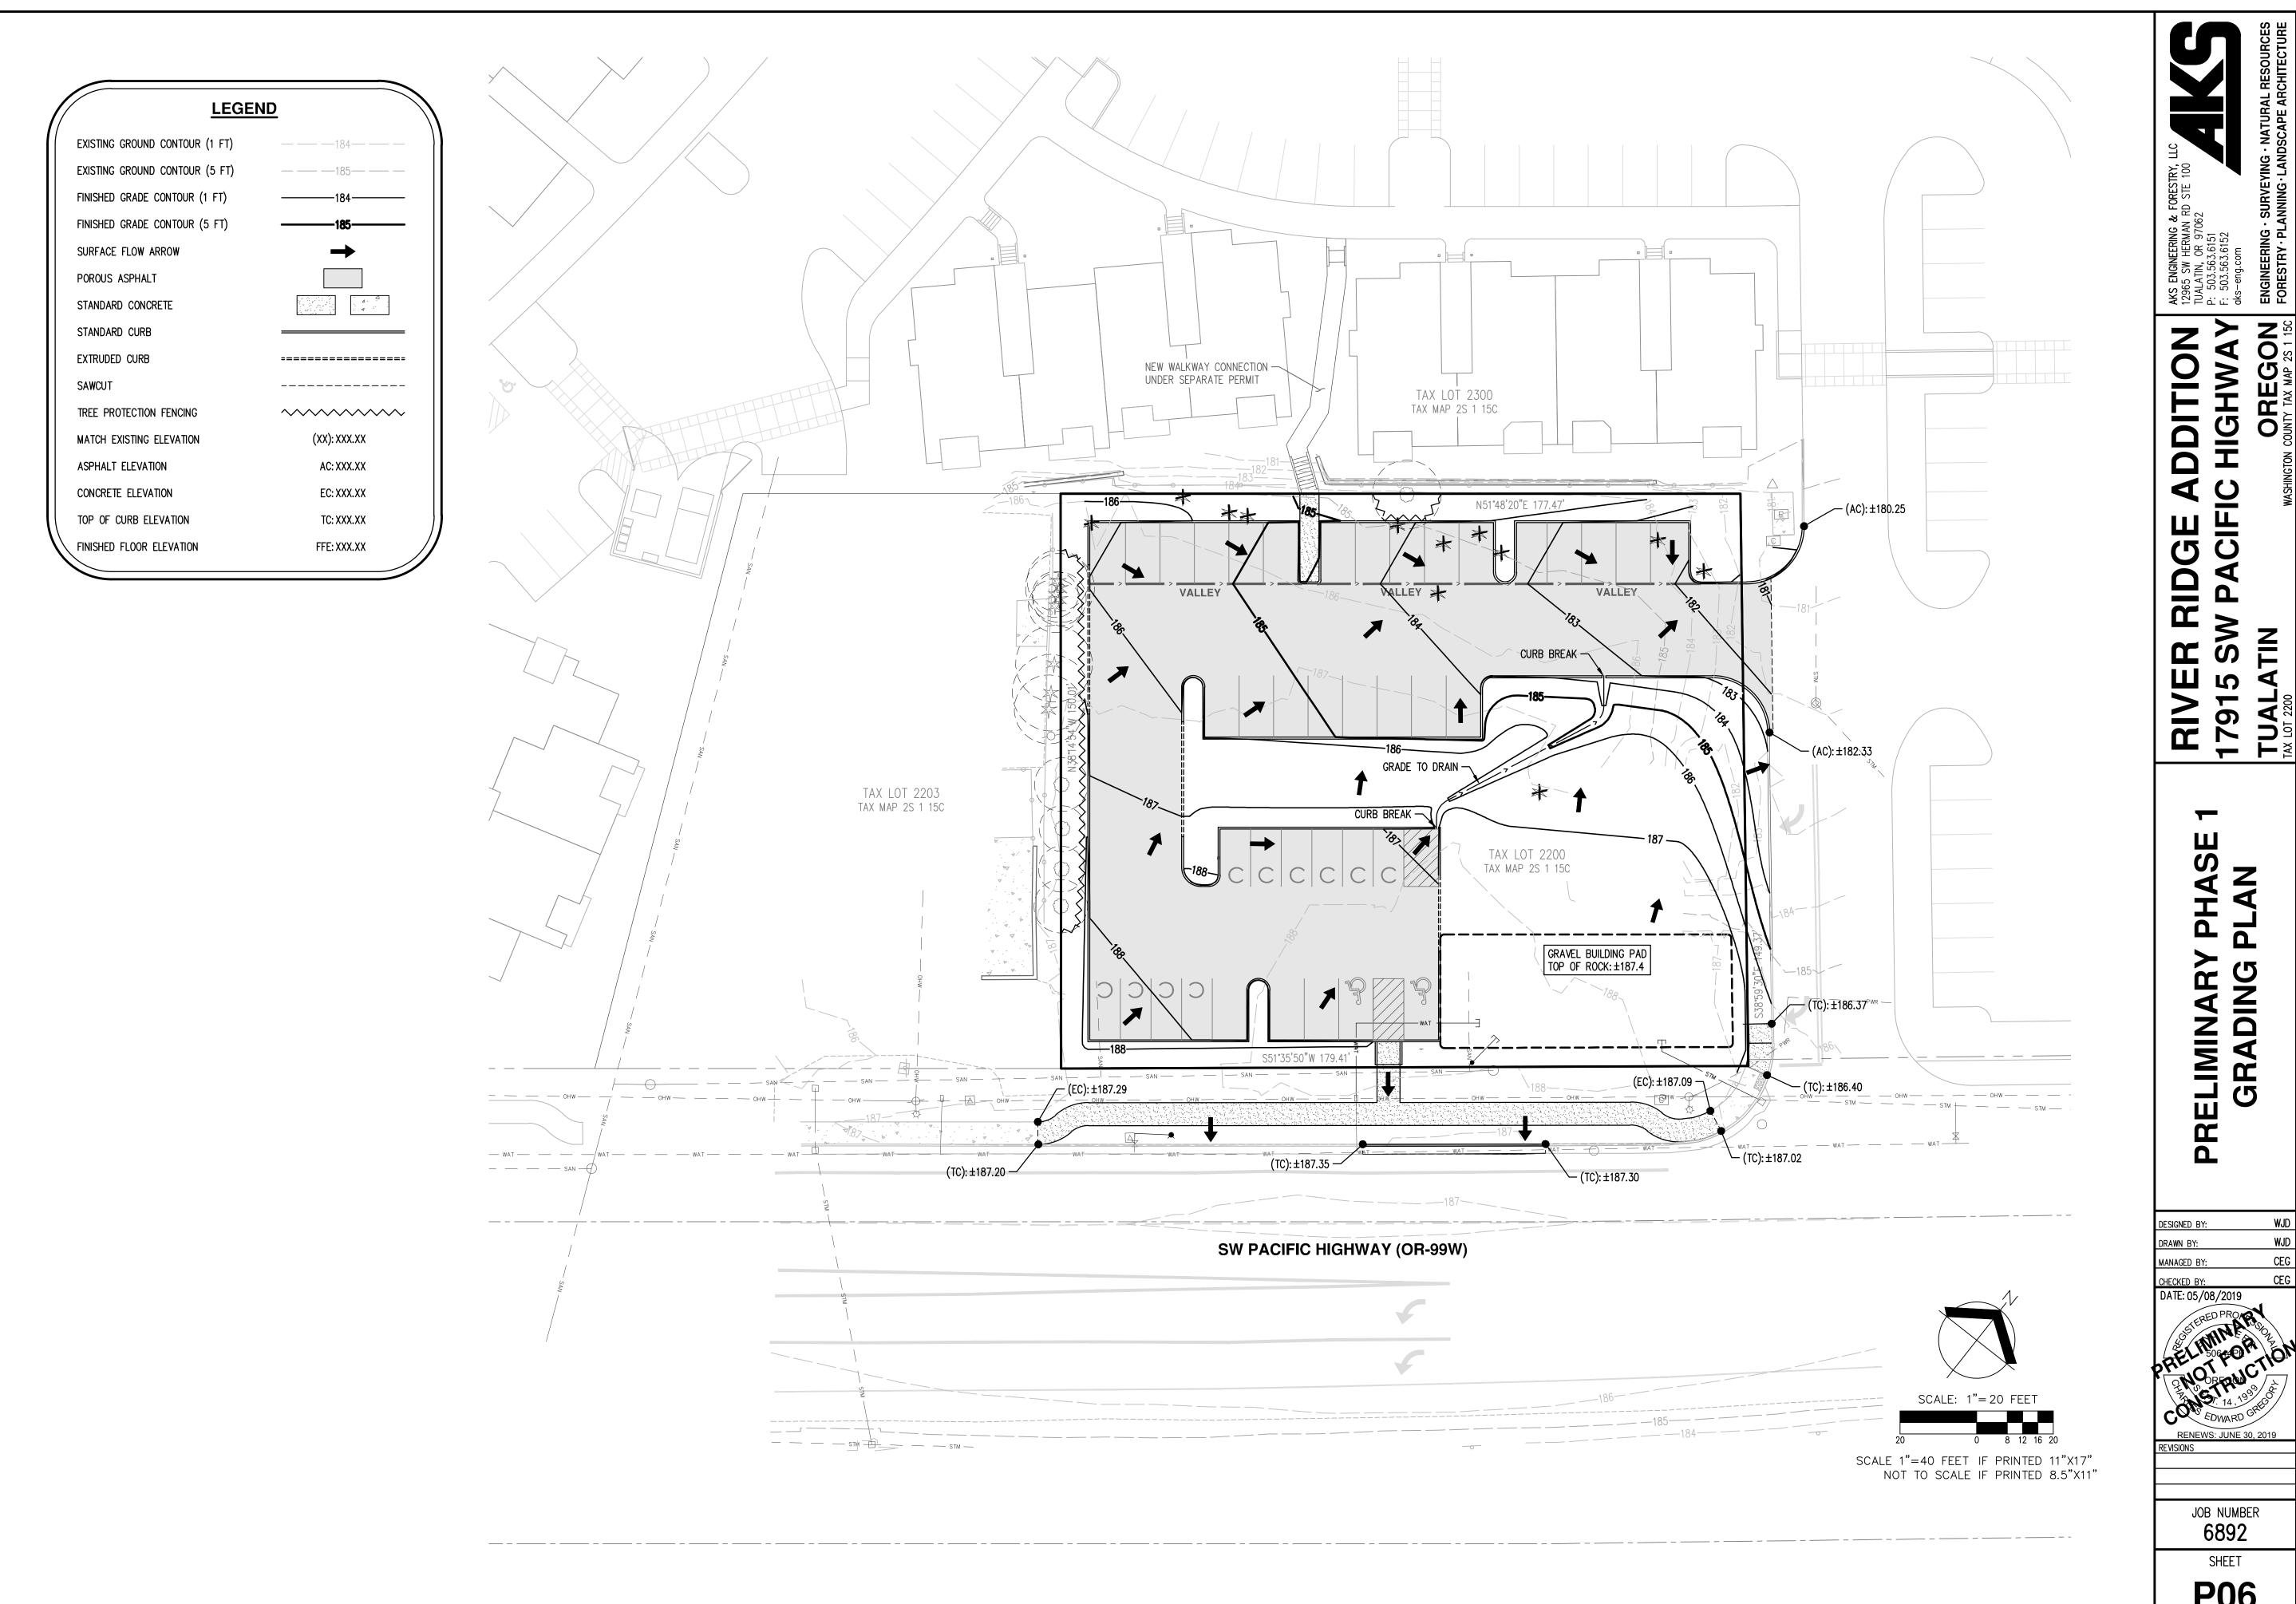


DDITION RIDGE

PRELIMINARY

DATE: 05/08/2019

JOB NUMBER 6892

SHEET

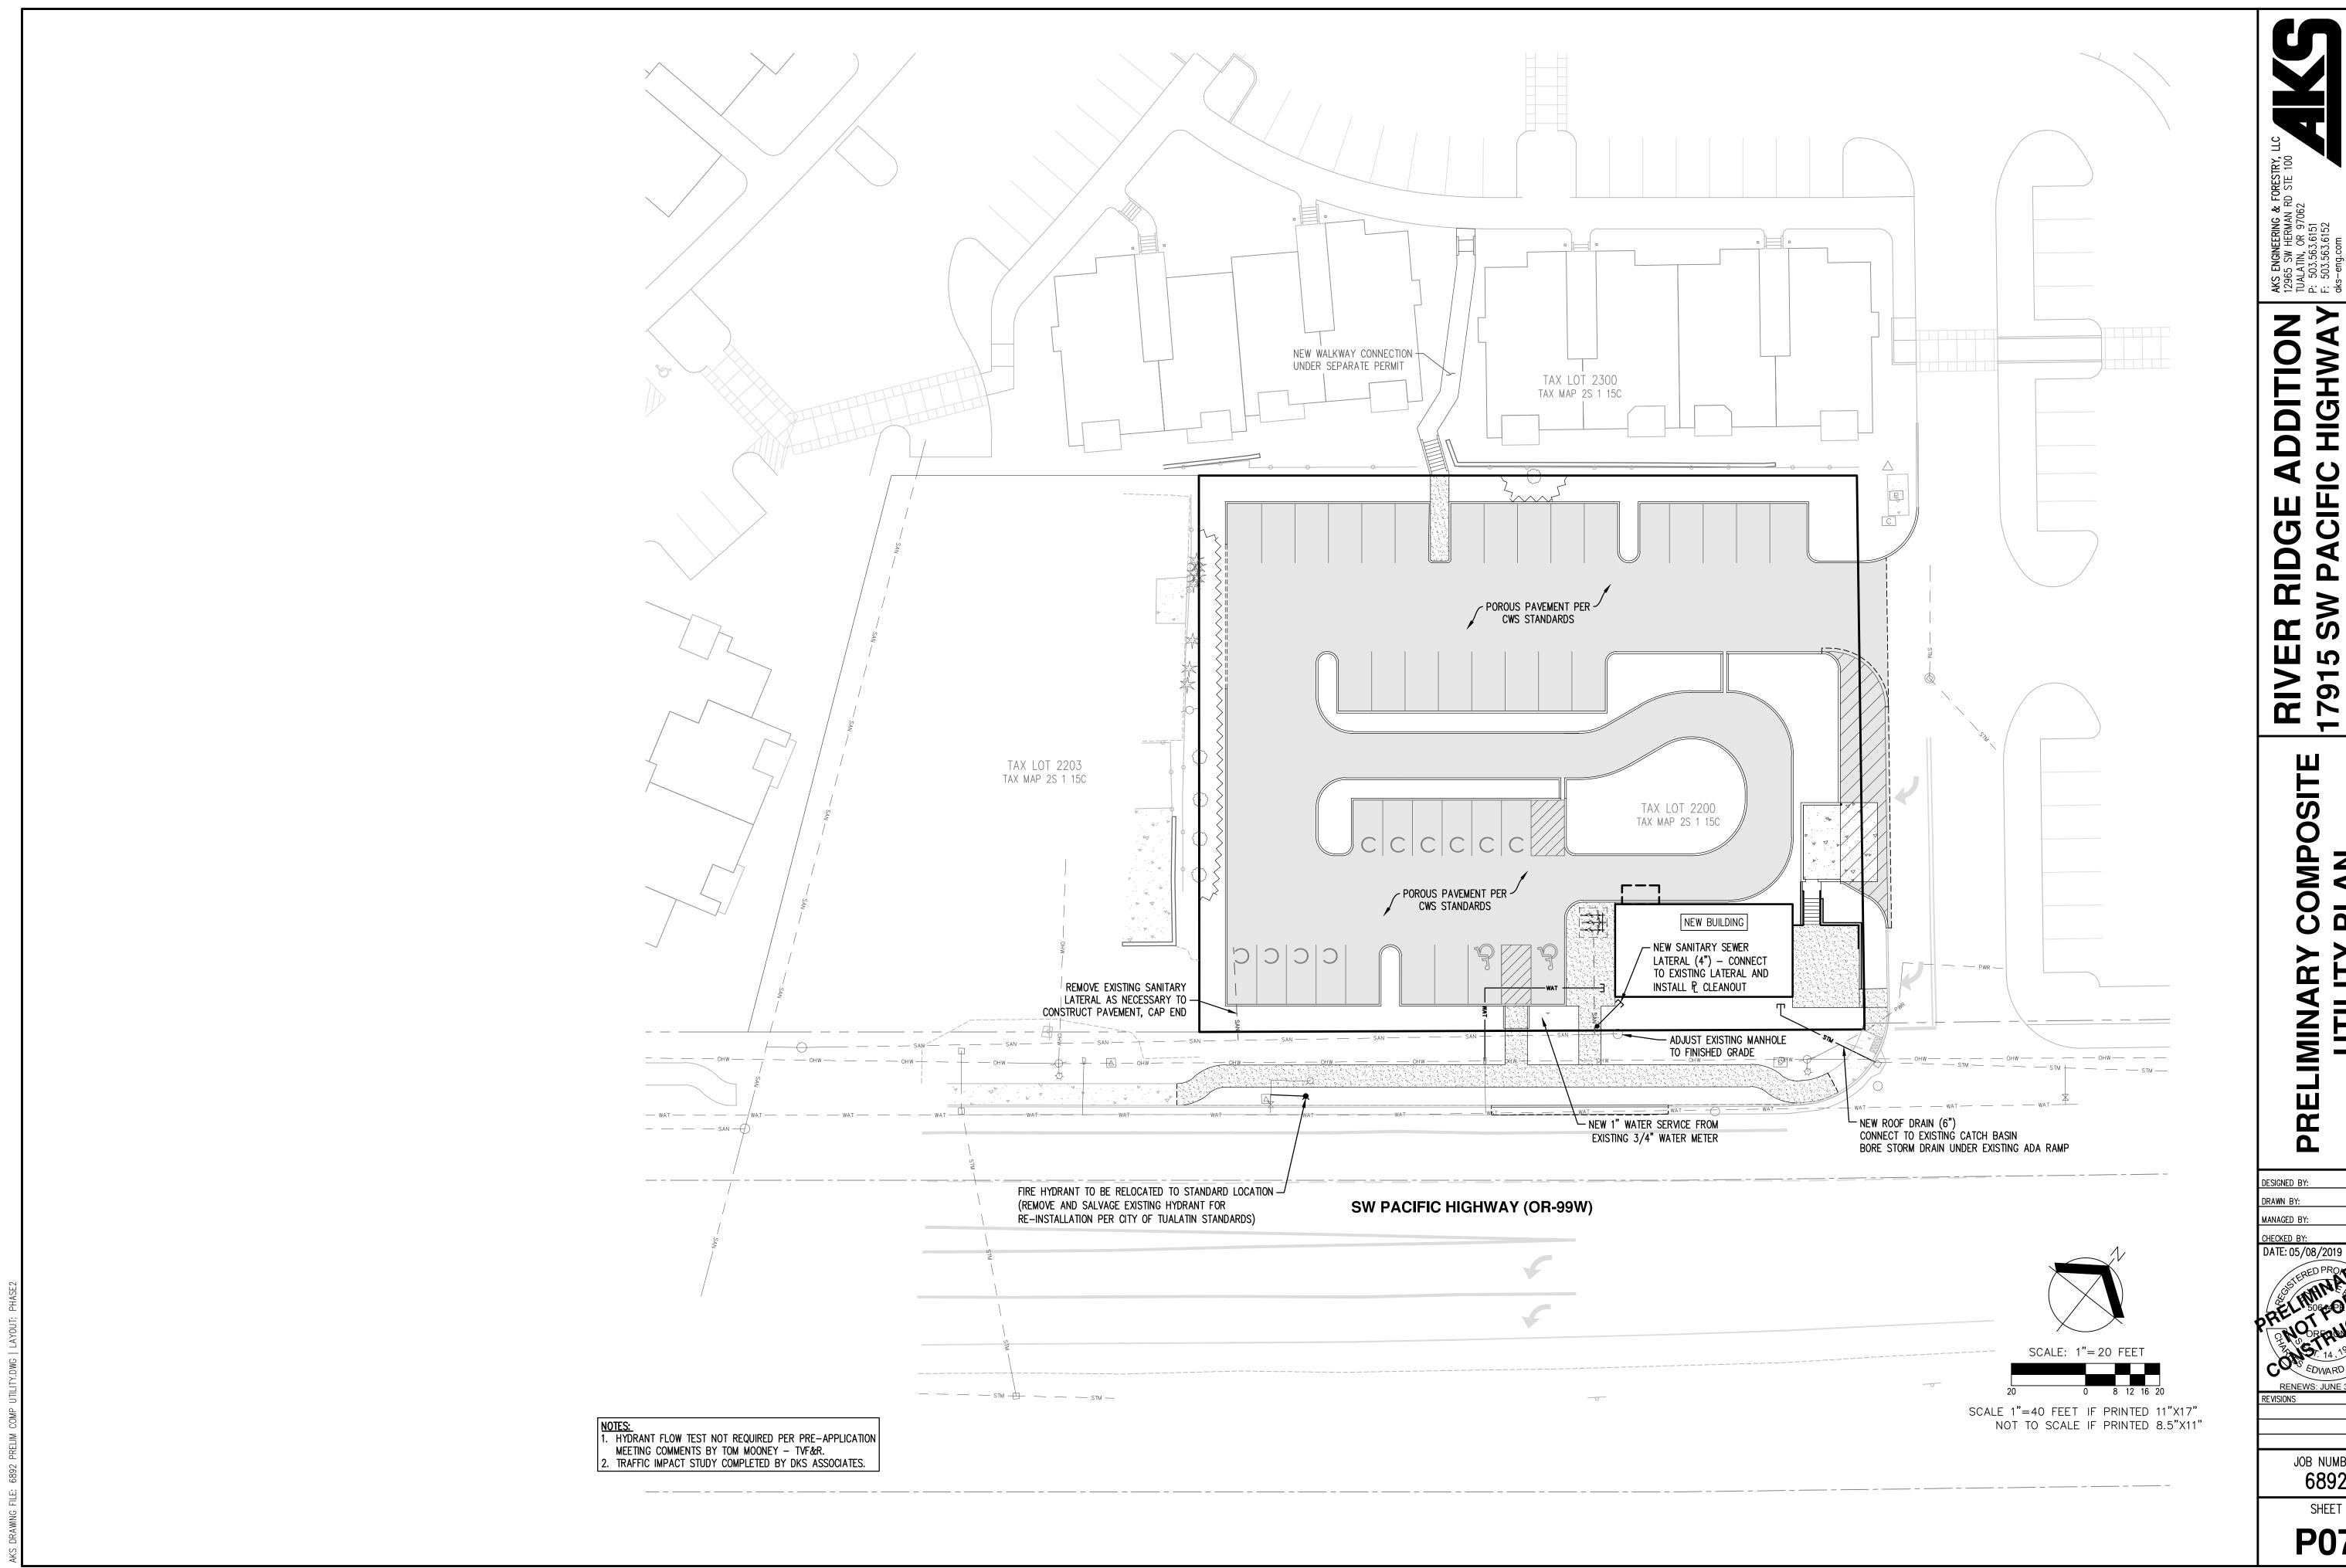


COMPOSITE

RELIMINARY UTILITY

JOB NUMBER

SHEET

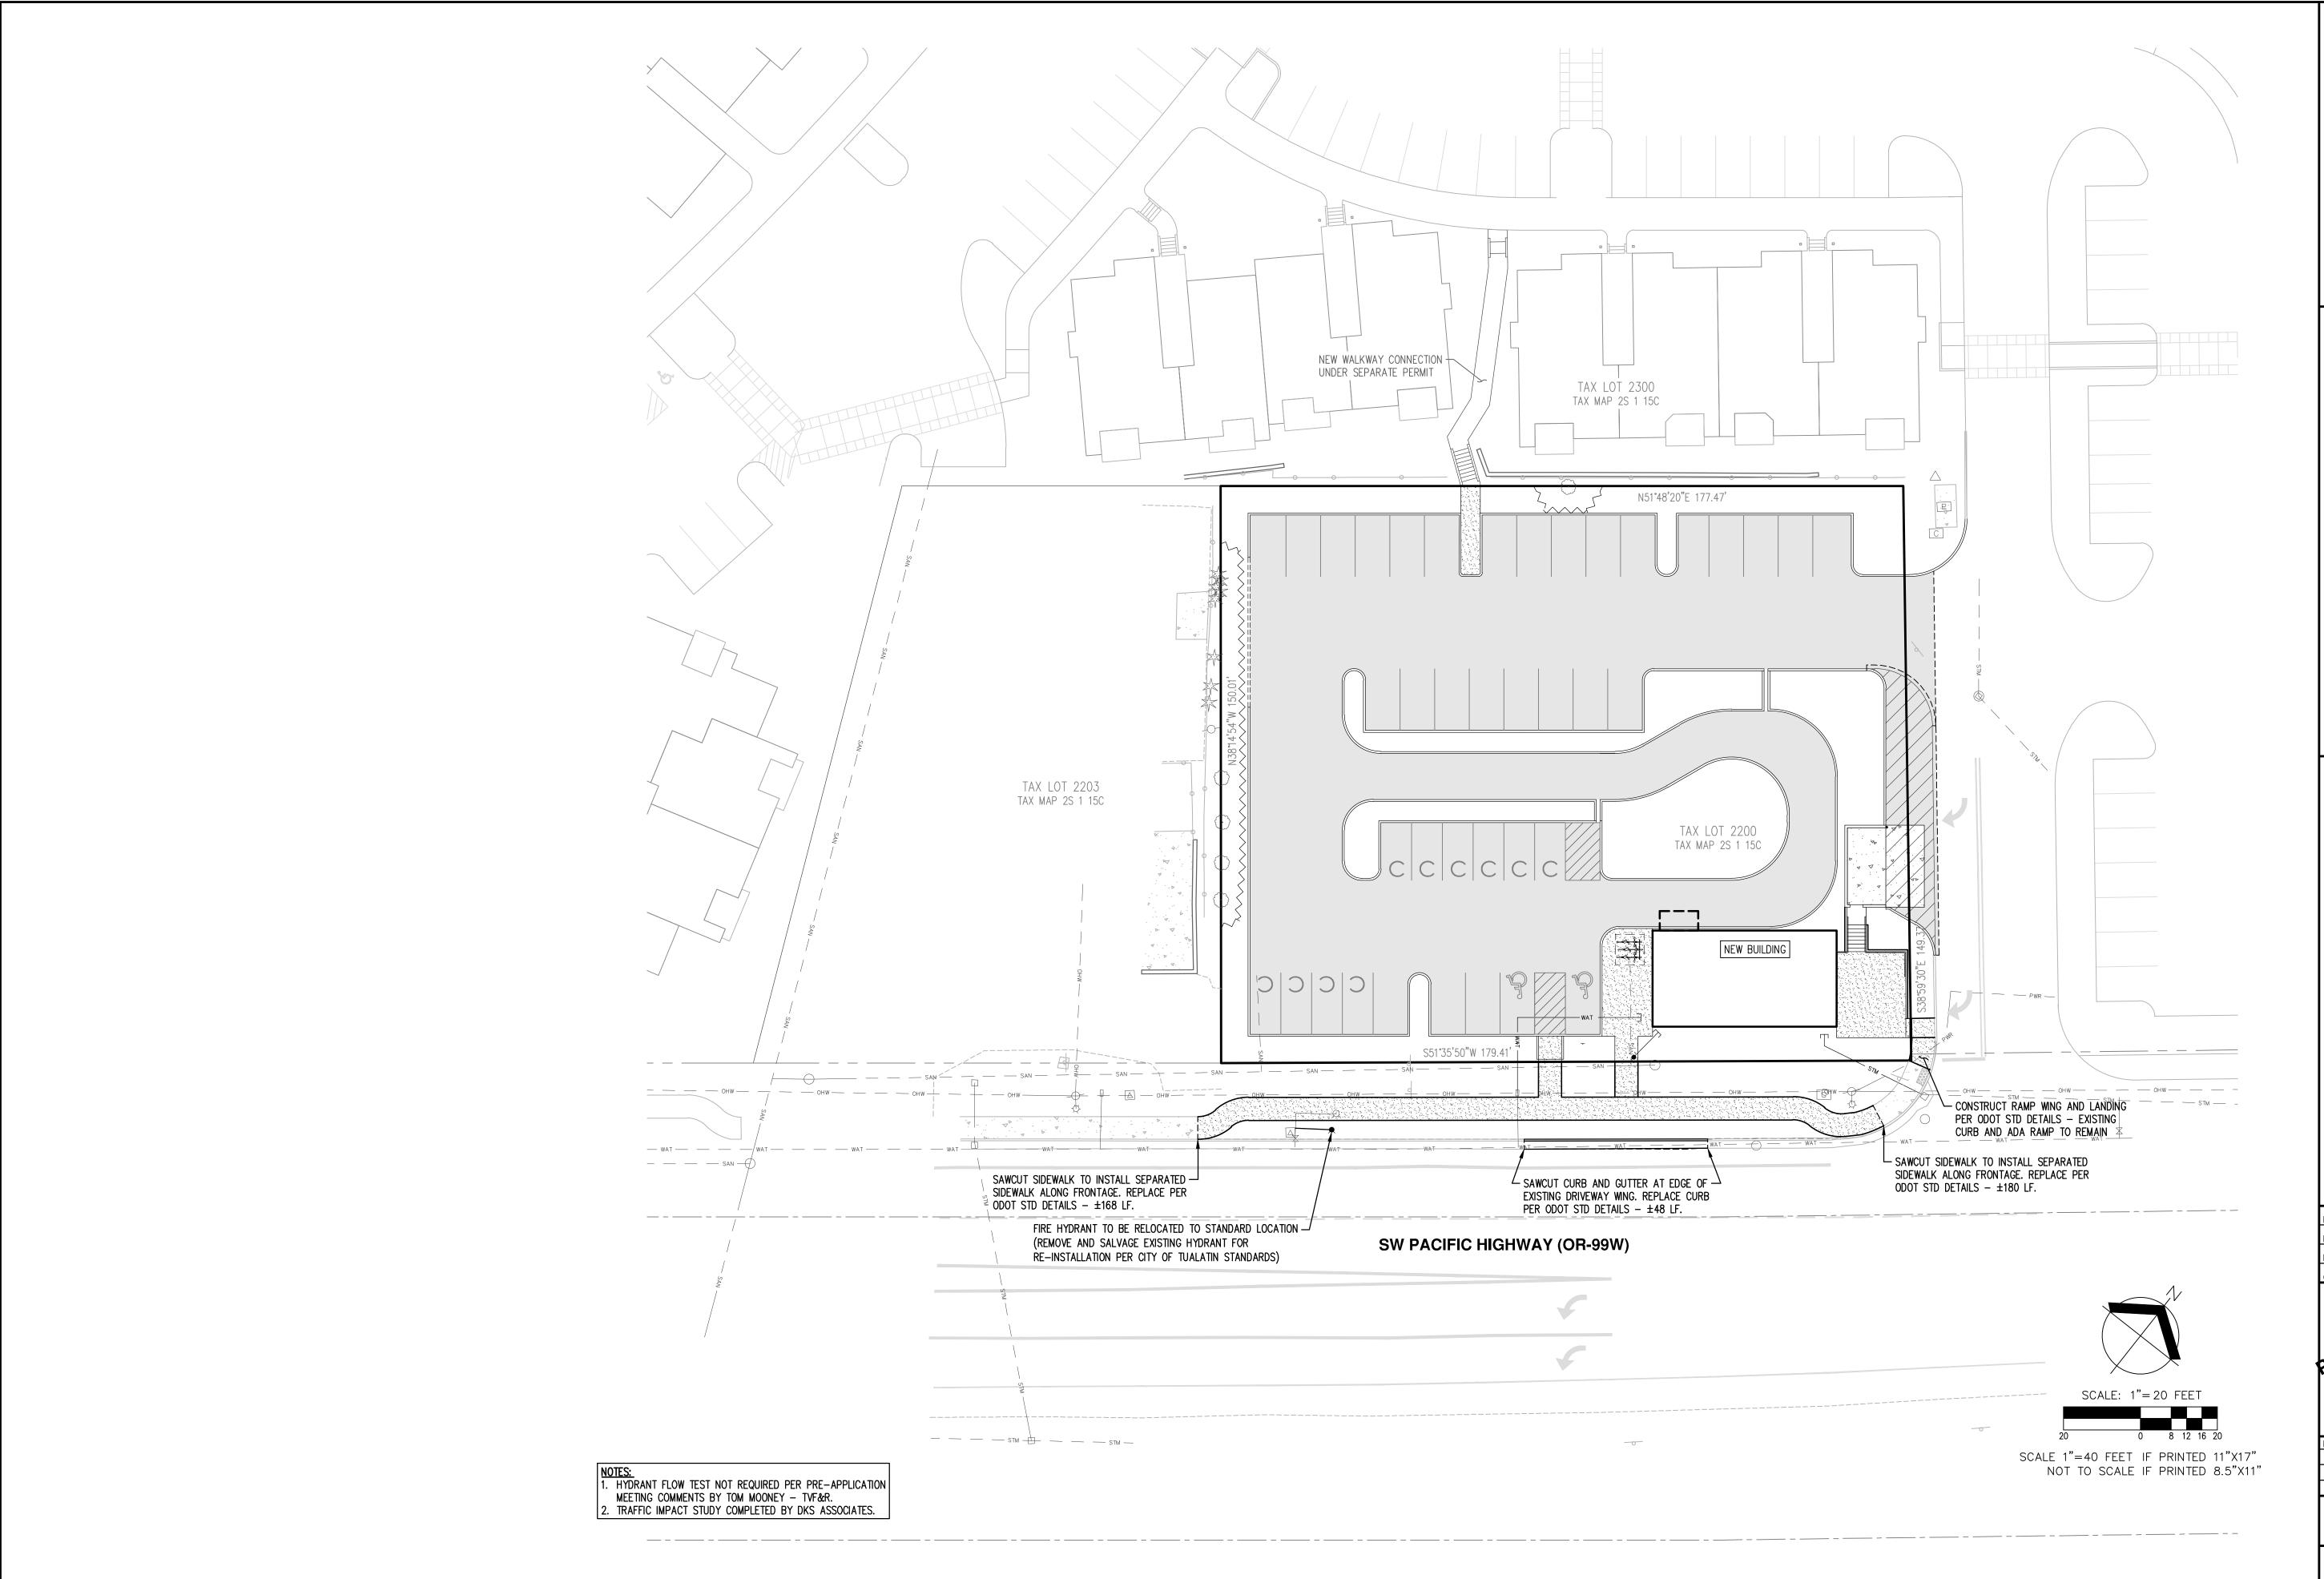

RIVER RIDGE ADDITIC 17915 SW PACIFIC HIGHW

> PRELIMINARY PUBLIC FACILITIES PLAN

ESIGNED BY: WO
RAWN BY: WO
IANAGED BY: CE
HECKED BY: CE

CHECKED BY: CEG

DATE: 05/08/2019

CEG

DATE: 05/08/2019


CEG

DATE: 05/08/2019

RENEWS: JUNE
EVISIONS

JOB NUMBER

SHEET

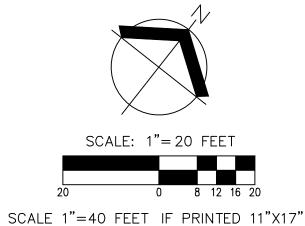

NOT TO SCALE IF PRINTED 8.5"X11"

CONCEPTIIAL PLANT KEY

CONCE	PTUA	L PLANT KEY					
TREES	QTY	BOTANICAL NAME	COMMON NAME	SIZE/CONTAINER	<u>SPACING</u>		
<u>.</u>	8	ACER CIRCINATUM	VINE MAPLE	6° HT. B&B MULTI-TRUNK	AS SHOWN		
	9	ACER RUBRUM 'BOWHALL'	BOWHALL MAPLE	2" CAL. B&B	AS SHOWN		
	7	ACER RUBRUM 'RED SUNSET'	RED SUNSET MAPLE	2" CAL. B&B	AS SHOWN		
	4	CHAMAECYPARIS NOOTKATENSIS 'PENDULA'	WEEPING NOOTKA FALSE CYPRESS	6' HT. B&B	AS SHOWN		
And a feet of the state of the	3	CUPRESSUS GLABRA 'BLUE ICE'	BLUE ICE CYPRESS	6' HT. B&B	AS SHOWN		
	4	FRAXINUS EXCELSIOR 'GOLDEN DESERT'	GOLDEN DESERT ASH	2" CAL. B&B	AS SHOWN		
	4	PYRUS CALLERYANA 'CHANTICLEER'	CHANTICLEER PEAR	2" CAL. B&B	AS SHOWN		
STREET TREES	QTY	BOTANICAL NAME	COMMON NAME	SIZE/CONTAINER	<u>SPACING</u>		
	5	CARPINUS BETULUS 'FASTIGIATA'	PYRAMIDAL EUROPEAN HORNBEAN	2" CAL. B&B	AS SHOWN		
<u>SHRUBS</u>	<u>QTY</u>	BOTANICAL NAME	COMMON NAME	SIZE/CONTAINER	<u>SPACING</u>		
♦	15	CORNUS SERICEA 'KELSEYI'	KELSEY DOGWOOD	2 GAL CONT.	30" o.c.		
•	154	PRUNUS LAUROCERASUS 'OTTO LUYKEN'	LUYKENS LAUREL	2 GAL CONT.	36" o.c.		
Θ	36	ROSA X 'FLOWER CARPET RED'	FLOWER CARPET ROSE	1 GAL CONT	30" o.c.		
O	44	VIBURNUM DAVIDII	DAVID VIBURNUM	2 GAL CONT.	36" o.c.		
®	12	VIBURNUM TINUS 'SPRING BOUQUET'	SPRING BOUQUET LAURESTINUS	2 GAL CONT.	36" o.c.		
<u>GRASSES</u>	<u>QTY</u>	BOTANICAL NAME	COMMON NAME	SIZE/CONTAINER	<u>SPACING</u>		
\odot	37	MISCANTHUS SINENSIS 'MORNING LIGHT'	EULALIA GRASS	1 GAL CONT.	36" o.c.		
©	68	PENNISETUM ALOPECUROIDES 'HAMELN'	HAMELN DWARF FOUNTAIN GRASS	1 GAL CONT.	30" o.c.		
GROUND COVERS	<u>QTY</u>	BOTANICAL NAME	COMMON NAME	SIZE/CONTAINER	<u>SPACING</u>		
	158	COTONEASTER DAMMERI 'LOWFAST'	LOWFAST BEARBERRY COTONEASTER	1 GAL CONT	36" o.c.		
\(\psi\) \(\	APPROX. 3,103 SF LAWN — NORTHWEST SUPREME LAWN SEED MIX (OR APPROVED EQUAL) SUNMARK SEEDS — LOLIUM PERENNE VAR DASHER 3 (DASHER 3 PERENNIAL RYEGRASS) 35% — LOLIUM PERENNE VAR CUTTER II (CUTTER II PERENNIAL RYEGRASS) 35%						

- LOLIUM PERENNE VAR CUTTER II (CUTTER II PERENNIAL RYEGRASS) 35% - FESTUCA RUBRA VAR GARNET (GARNET CREEPING RED FESCUE) 15%

- FESTUCA RUBRA SPP FALLAX VAR WINDWARD (WINDWARD CHEWINGS FESCUE) 15%

APPLY AT A RATE OF 8 LBS. PER 1,000 SF OR AS RECOMMENDED BY SUPPLIER.

GENERAL LANDSCAPE NOTES

- 1. CONTRACTOR IS RESPONSIBLE FOR VERIFYING PLANT & MATERIAL QUANTITIES. IF DISCREPANCIES OCCUR, DESIGN INTENT PREVAILS OVER QUANTITIES LISTED. FIELD ADJUST PLANTINGS AS REQUIRED TO AVOID CONFLICTS WITH ABOVE AND BELOW GROUND UTILITIES, EXISTING VEGETATION AND TREE CANOPIES, ETC.
- 2. ALL PLANTINGS SHALL CONFORM TO TUALATIN DESIGN STANDARDS AND TO THE AMERICAN NURSERY STANDARDS ANSI Z60.1. ALL TREES ON SITE SHALL MEET THE AMERICAN ASSOCIATION OF NURSERYMEN (AAN) STANDARDS FOR NURSERY STOCK (ANSI Z60.1) GRADE NO. 1 OR BETTER, BEING HEALTHY NURSERY GROWN STOCK WITH WELL-FORMED, SYMMETRICAL BRANCHING STRUCTURE. ALL TREES SHALL HAVE A SINGLE STRAIGHT TRUNK, A WELL-DEVELOPED LEADER WITH TOPS AND ROOTS CHARACTERISTIC OF THE SPECIES, CULTIVAR, OR VARIETY, AND BE FREE OF INSECTS, DISEASES, MECHANICAL INJURY, AND OTHER OBJECTIONABLE FEATURES WHEN PLANTED. PLANT IN ACCORDANCE WITH BEST-PRACTICE INDUSTRY STANDARDS ADOPTED BY THE OREGON LANDSCAPE CONTRACTORS BOARD (OLCB).
- PLANT SPECIES, SIZES, LOCATIONS, QUANTITIES, ETC. MAY BE SUBSTITUTED OR REVISED BY THE LANDSCAPE ARCHITECT PRIOR TO FINAL INSTALLATION DUE TO SITE CONDITIONS, AVAILABILITY, ETC. WHERE ALLOWED BY TUALATIN DESIGN STANDARDS.
- CONTRACTOR SHALL BE RESPONSIBLE FOR PROTECTING EXISTING VEGETATION (INCLUDING DAMAGE TO TREE ROOT ZONES OR CANOPY) DURING THE COURSE OF THEIR WORK.
- 5. SOIL PREPARATION: ALL PLANTING AREAS SHALL HAVE SUFFICIENT SOIL DEPTH AND FERTILITY TO SUPPORT HEALTHY PLANT GROWTH. FINISH GRADE OF NEW PLANTING AREAS SHALL SEAMLESSLY MEET EXISTING GRADE OF SURROUNDING PLANTING AREAS AND PROVIDE POSITIVE DRAINAGE. IF ADDITIONAL TOPSOIL IS REQUIRED TO MAKE UP REQUIRED AMOUNTS, IMPORTED TOPSOIL MAY BY USED. ANY IMPORTED TOPSOIL SHALL BE FREE OF ROOTS, WEEDS/WEED SEEDS, CLAY LUMPS, DEBRIS, ROCKS, LARGE WOODY MATERIAL, AND OTHER EXTRANEOUS, NON-ORGANIC MATERIAL HARMFUL TO PLANT GROWTH. SOIL PLACEMENT SHALL NOT OCCUR IN CONDITIONS THAT COULD RESULT IN OVER-COMPACTION OR EROSION AND MUST BE IN FRIABLE (WORKABLE) CONDITION WHEN PLACED.
- 6. STREET TREES SHALL, WHERE APPLICABLE, BE CENTERED IN THE PLANTING STRIP BETWEEN CURB AND SIDEWALK. FIELD ADJUST IF NECESSARY TO MAINTAIN MINIMUM 3' FROM SIDEWALKS, 5' FROM DRIVEWAY INTERSECTIONS, 5' FROM FIRE HYDRANTS, 10' FROM MANHOLES AND CATCH BASINS, 5' FROM WATER METERS AND UTILITY BOXES, 20' FROM STREET LIGHTS.
- 7. TREES AND LANDSCAPING BOTH WITHIN AND BEHIND THE PUBLIC RIGHT-OF-WAY SHALL BE MAINTAINED TO PROVIDE 8' OF CLEARANCE OVER SIDEWALKS AND 13' OF CLEARANCE OVER STREET AREAS.
- 8. IRRIGATION SHALL BE AUTOMATIC UNDERGROUND SYSTEM 'DESIGN-BUILD' BY LANDSCAPE CONTRACTOR.
- 9. LANDSCAPE BOULDERS: THREE TO FOUR MAN SIZE (AVERAGE DIMENSIONS 28"-48"), LOCAL BASALT OR GRANITE. BURY BOTTOM THIRD OF BOULDER FOR STABILITY.

GE GE

N

DATE: 05/08/2019

JOB NUMBER

SIZE/CONTAINER SPACING

2" CAL. B&B AS SHOWN

2" CAL. B&B AS SHOWN

2" CAL. B&B AS SHOWN

JOB NUMBER

SHEET

PLANT SCHEDULE - PHASE 1 GRASSES GROUND COVERS

BOTANICAL NAME

ACER RUBRUM 'BOWHALL'

ACER RUBRUM 'RED SUNSET'

CARPINUS BETULUS 'FASTIGIATA'

BOTANICAL NAME

VIBURNUM DAVIDII

BOTANICAL NAME

PENNISETUM ALOPECUROIDES 'HAMELN'

COTONEASTER DAMMERI 'LOWFAST'

FRAXINUS EXCELSIOR 'GOLDEN DESERT' GOLDEN DESERT ASH

PRUNUS LAUROCERASUS 'OTTO LUYKEN' LUYKENS LAUREL

COMMON NAME

BOWHALL MAPLE

RED SUNSET MAPLE

COMMON NAME

COMMON NAME

DAVID VIBURNUM

COMMON NAME

10.773 SF NATIVE ECO-TURF SEED MIX (OR APPROVED EQUAL) SUNMARK SEEDS

- LOLIUM PERENNE VAR CUTTER II (CUTTER II PERENNIAL RYEGRASS) 35%

- FESTUCA RUBRA SPP FALLAX VAR WINDWARD (WINDWARD CHEWINGS FESCUE) 15%

APPLY AT A RATE OF 8 LBS. PER 1,000 SF OR AS RECOMMENDED BY SUPPLIER.

- FESTUCA RUBRA VAR GARNET (GARNET CREEPING RED FESCUE) 15%

- HORDEUM BRACHYANTHERUM (MEADOW BARLEY) 40%

- BROMUS CARINATUS (CALIFORNIA BROME) 35% - FESTUCA RUBRA RUBRA (NATIVE RED FESCUE) 20%

- DESCHAMPSIA CESPITOSA (TUFTED HAIRGRASS) 3% - AGROSTIS EXERATA (SPIKE BENTGRASS) 2%


APPLY AT A RATE OF 1 LB. PER 1,000 SF OR AS RECOMMENDED BY SUPPLIER.

GENERAL LANDSCAPE NOTES


- 1. CONTRACTOR IS RESPONSIBLE FOR VERIFYING PLANT & MATERIAL QUANTITIES. IF DISCREPANCIES OCCUR, DESIGN INTENT PREVAILS OVER QUANTITIES LISTED. FIELD ADJUST PLANTINGS AS REQUIRED TO AVOID CONFLICTS WITH ABOVE AND BELOW GROUND UTILITIES, EXISTING VEGETATION AND TREE CANOPIES, ETC.
- 2. ALL PLANTINGS SHALL CONFORM TO TUALATIN DESIGN STANDARDS AND TO THE AMERICAN NURSERY STANDARDS ANSI Z60.1. ALL TREES ON SITE SHALL MEET THE AMERICAN ASSOCIATION OF NURSERYMEN (AAN) STANDARDS FOR NURSERY STOCK (ANSI Z60.1) GRADE NO. 1 OR BETTER, BEING HEALTHY NURSERY GROWN STOCK WITH WELL-FORMED, SYMMETRICAL BRANCHING STRUCTURE. ALL TREES SHALL HAVE A SINGLE STRAIGHT TRUNK, A WELL-DEVELOPED LEADER WITH TOPS AND ROOTS CHARACTERISTIC OF THE SPECIES, CULTIVAR, OR VARIETY, AND BE FREE OF INSECTS, DISEASES, MECHANICAL INJURY, AND OTHER OBJECTIONABLE FEATURES WHEN PLANTED. PLANT IN ACCORDANCE WITH BEST-PRACTICE INDUSTRY STANDARDS ADOPTED BY THE OREGON LANDSCAPE CONTRACTORS BOARD (OLCB).
- 3. PLANT SPECIES, SIZES, LOCATIONS, QUANTITIES, ETC. MAY BE SUBSTITUTED OR REVISED BY THE LANDSCAPE ARCHITECT PRIOR TO FINAL INSTALLATION DUE TO SITE CONDITIONS, AVAILABILITY, ETC. WHERE ALLOWED BY TUALATIN DESIGN STANDARDS. 4. CONTRACTOR SHALL BE RESPONSIBLE FOR PROTECTING EXISTING VEGETATION (INCLUDING DAMAGE TO TREE ROOT ZONES OR CANOPY)
- DURING THE COURSE OF THEIR WORK. 5. SOIL PREPARATION: ALL PLANTING AREAS SHALL HAVE SUFFICIENT SOIL DEPTH AND FERTILITY TO SUPPORT HEALTHY PLANT GROWTH.
- FINISH GRADE OF NEW PLANTING AREAS SHALL SEAMLESSLY MEET EXISTING GRADE OF SURROUNDING PLANTING AREAS AND PROVIDE POSITIVE DRAINAGE. IF ADDITIONAL TOPSOIL IS REQUIRED TO MAKE UP REQUIRED AMOUNTS, IMPORTED TOPSOIL MAY BY USED. ANY IMPORTED TOPSOIL SHALL BE FREE OF ROOTS, WEEDS/WEED SEEDS, CLAY LUMPS, DEBRIS, ROCKS, LARGE WOODY MATERIAL, AND OTHER EXTRANEOUS, NON-ORGANIC MATERIAL HARMFUL TO PLANT GROWTH. SOIL PLACEMENT SHALL NOT OCCUR IN CONDITIONS THAT COULD RESULT IN OVER-COMPACTION OR EROSION AND MUST BE IN FRIABLE (WORKABLE) CONDITION WHEN PLACED.
- 6. STREET TREES SHALL, WHERE APPLICABLE, BE CENTERED IN THE PLANTING STRIP BETWEEN CURB AND SIDEWALK. FIELD ADJUST IF NECESSARY TO MAINTAIN MINIMUM 3' FROM SIDEWALKS, 5' FROM DRIVEWAY INTERSECTIONS, 5' FROM FIRE HYDRANTS, 10' FROM MANHOLES AND CATCH BASINS, 5' FROM WATER METERS AND UTILITY BOXES, 20' FROM STREET LIGHTS.
- 7. TREES AND LANDSCAPING BOTH WITHIN AND BEHIND THE PUBLIC RIGHT-OF-WAY SHALL BE MAINTAINED TO PROVIDE 8' OF CLEARANCE OVER SIDEWALKS AND 13' OF CLEARANCE OVER TREE AREAS.
- 8. IRRIGATION SHALL BE AUTOMATIC UNDERGROUND SYSTEM 'DESIGN-BUILD' BY LANDSCAPE CONTRACTOR.

LANDSCAPE CALCULATIONS


TOTAL SITE AREA: ±26,571 SF (±0.61 ACRES) TOTAL LANDSCAPE AREA: ±7,200 SF (27%) PARKING LOT LANDSCAPE ISLANDS AREA: ±547 SF PARKING LOT TREES: 5

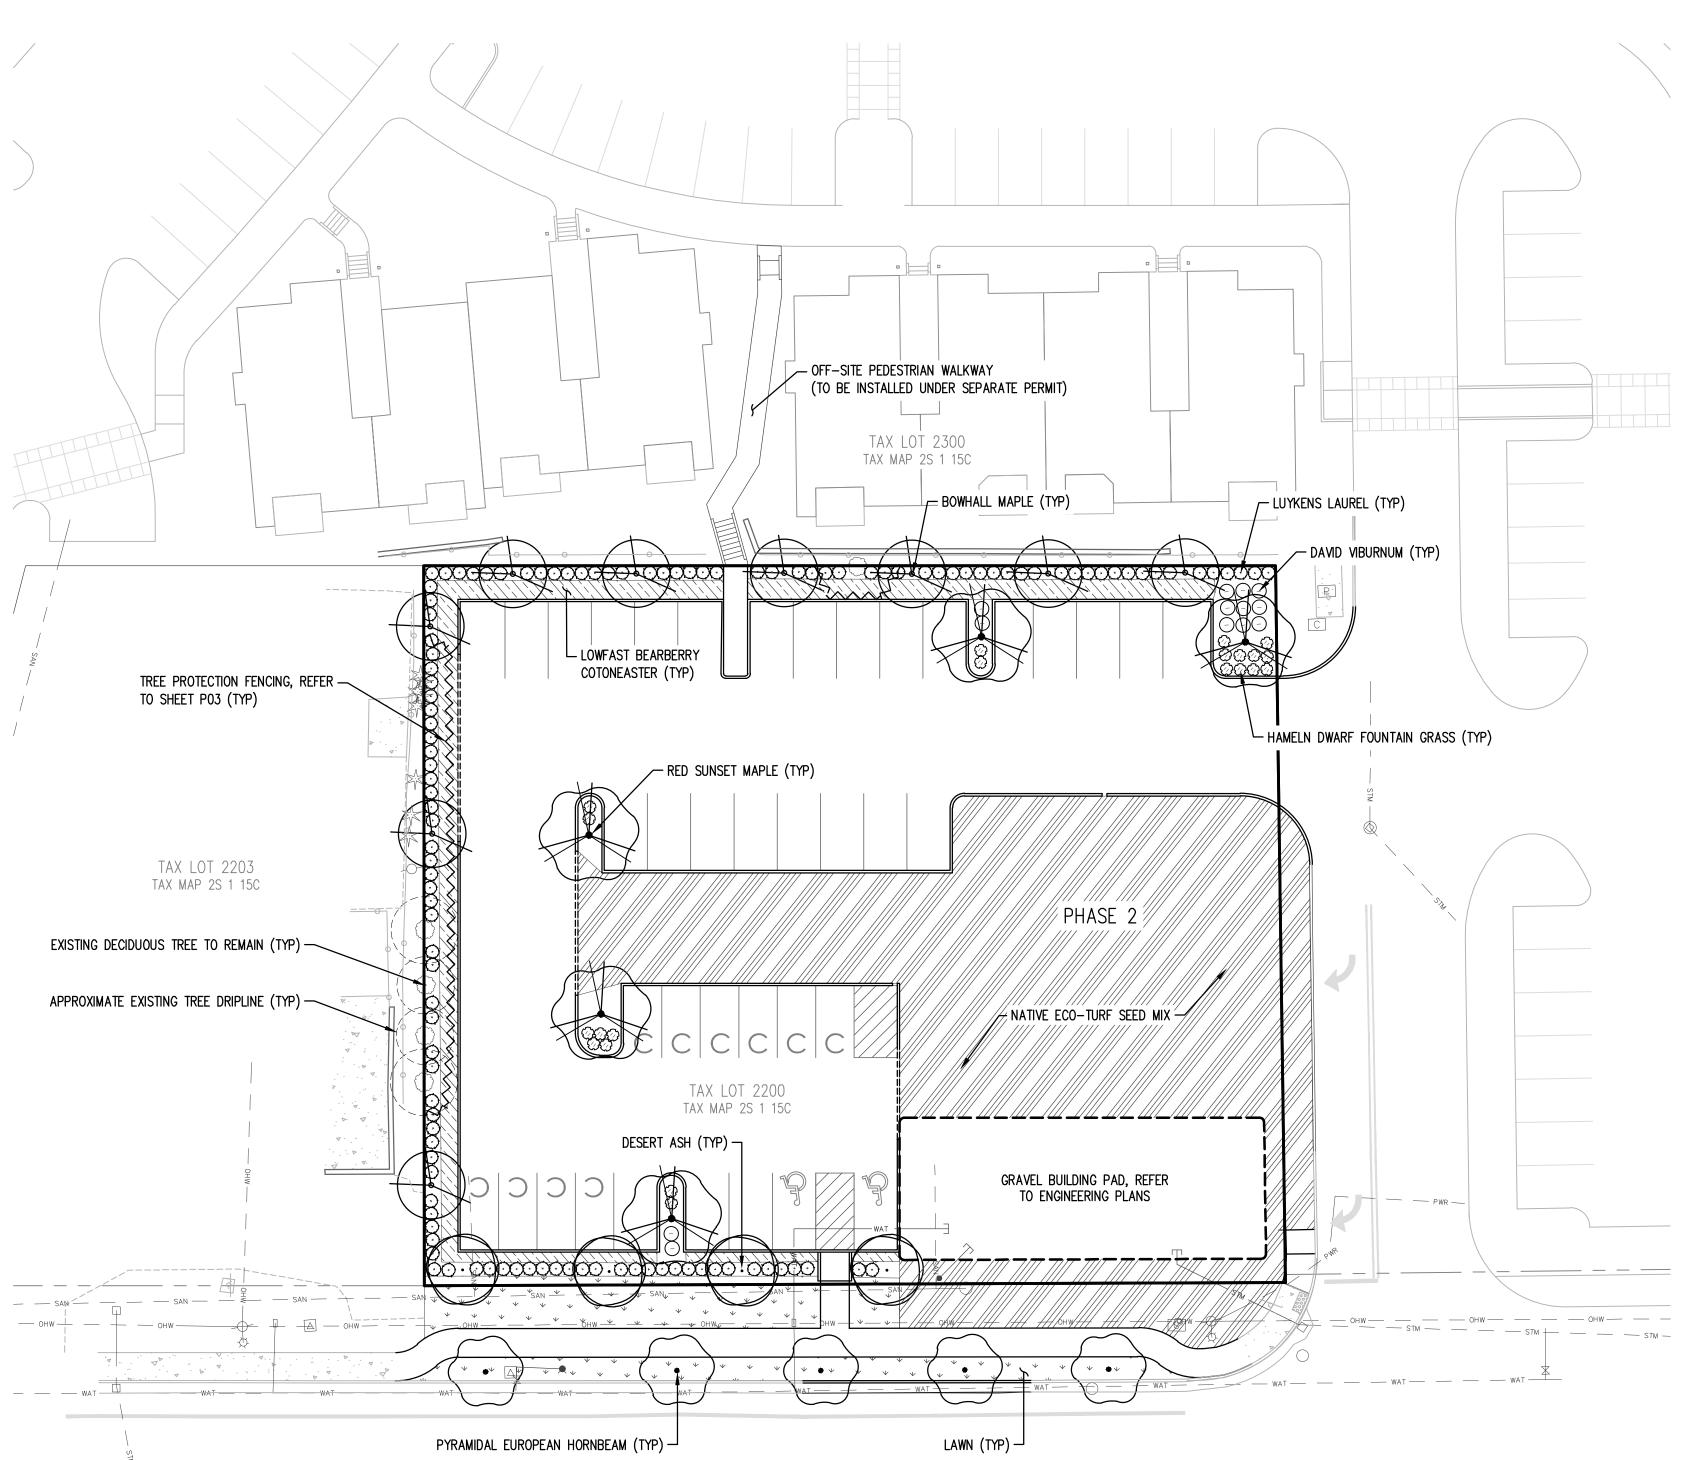


SW PACIFIC HIGHWAY (OR-99W)

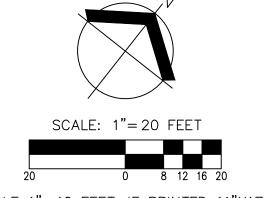



SCALE 1"=40 FEET IF PRINTED 11"X17" NOT TO SCALE IF PRINTED 8.5"X11"

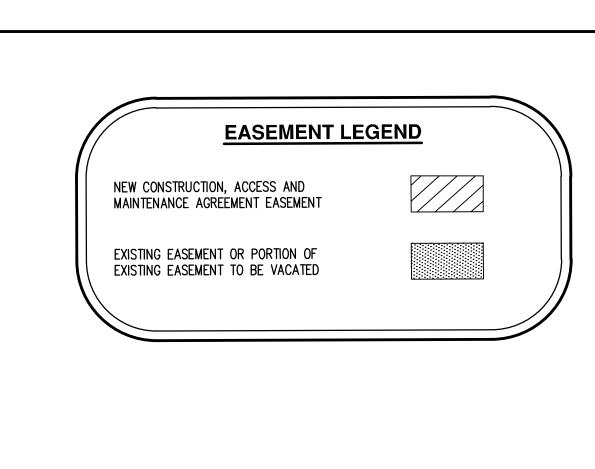

EXISTING CONSTRUCTION, ACCESS AND MAINTENANCE AGREEMENT EASEMENT PER DOC. NO. 2015-045880

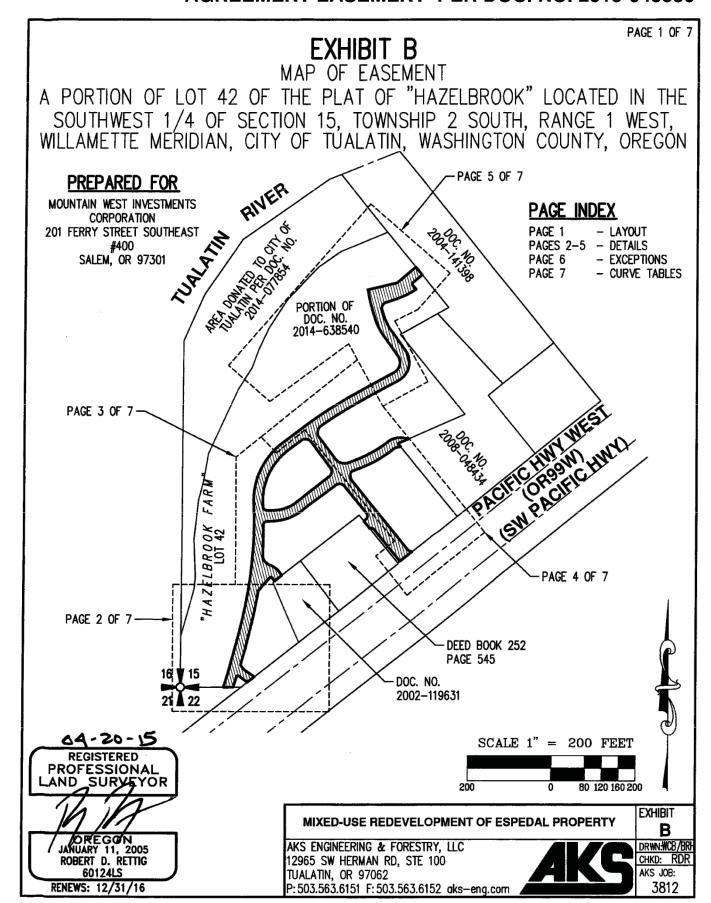

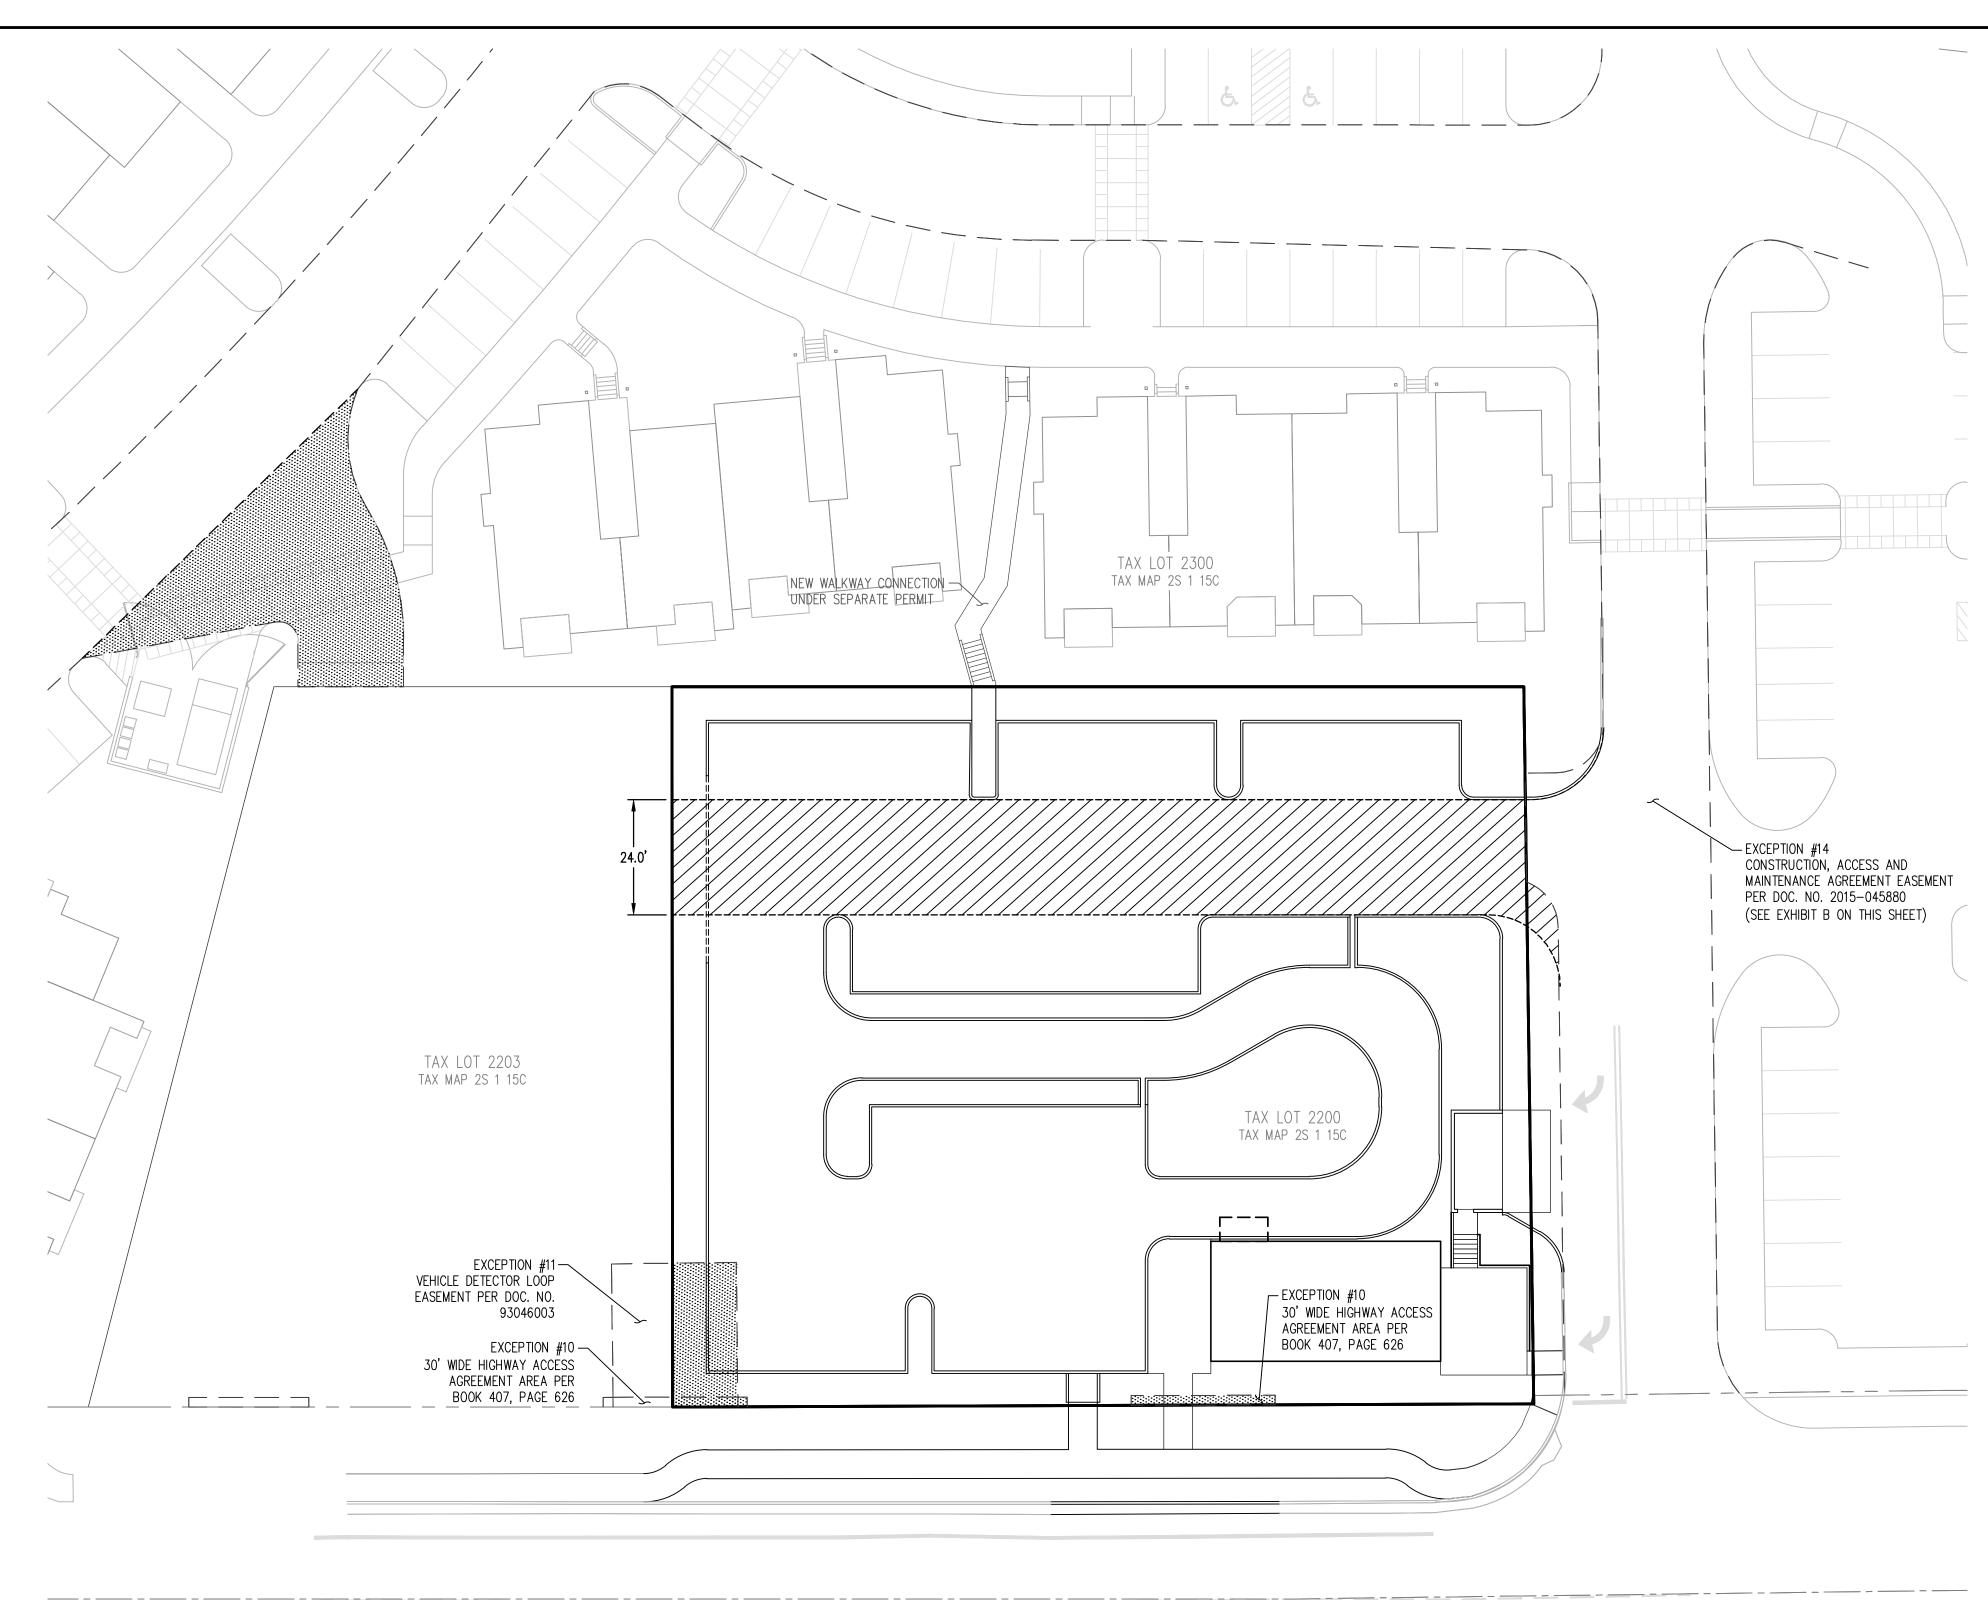

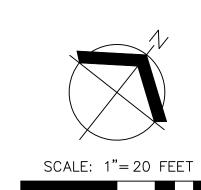

SCALE 1"=40 FEET IF PRINTED 11"X17"
NOT TO SCALE IF PRINTED 8.5"X11"

DATE: 05/08/2019

DDITION

RIDGE

RIVE

179°


PRELIMIN/ ASEMENT

JOB NUMBER

SHEET

P11


SW PACIFIC HIGHWAY (OR-99W)

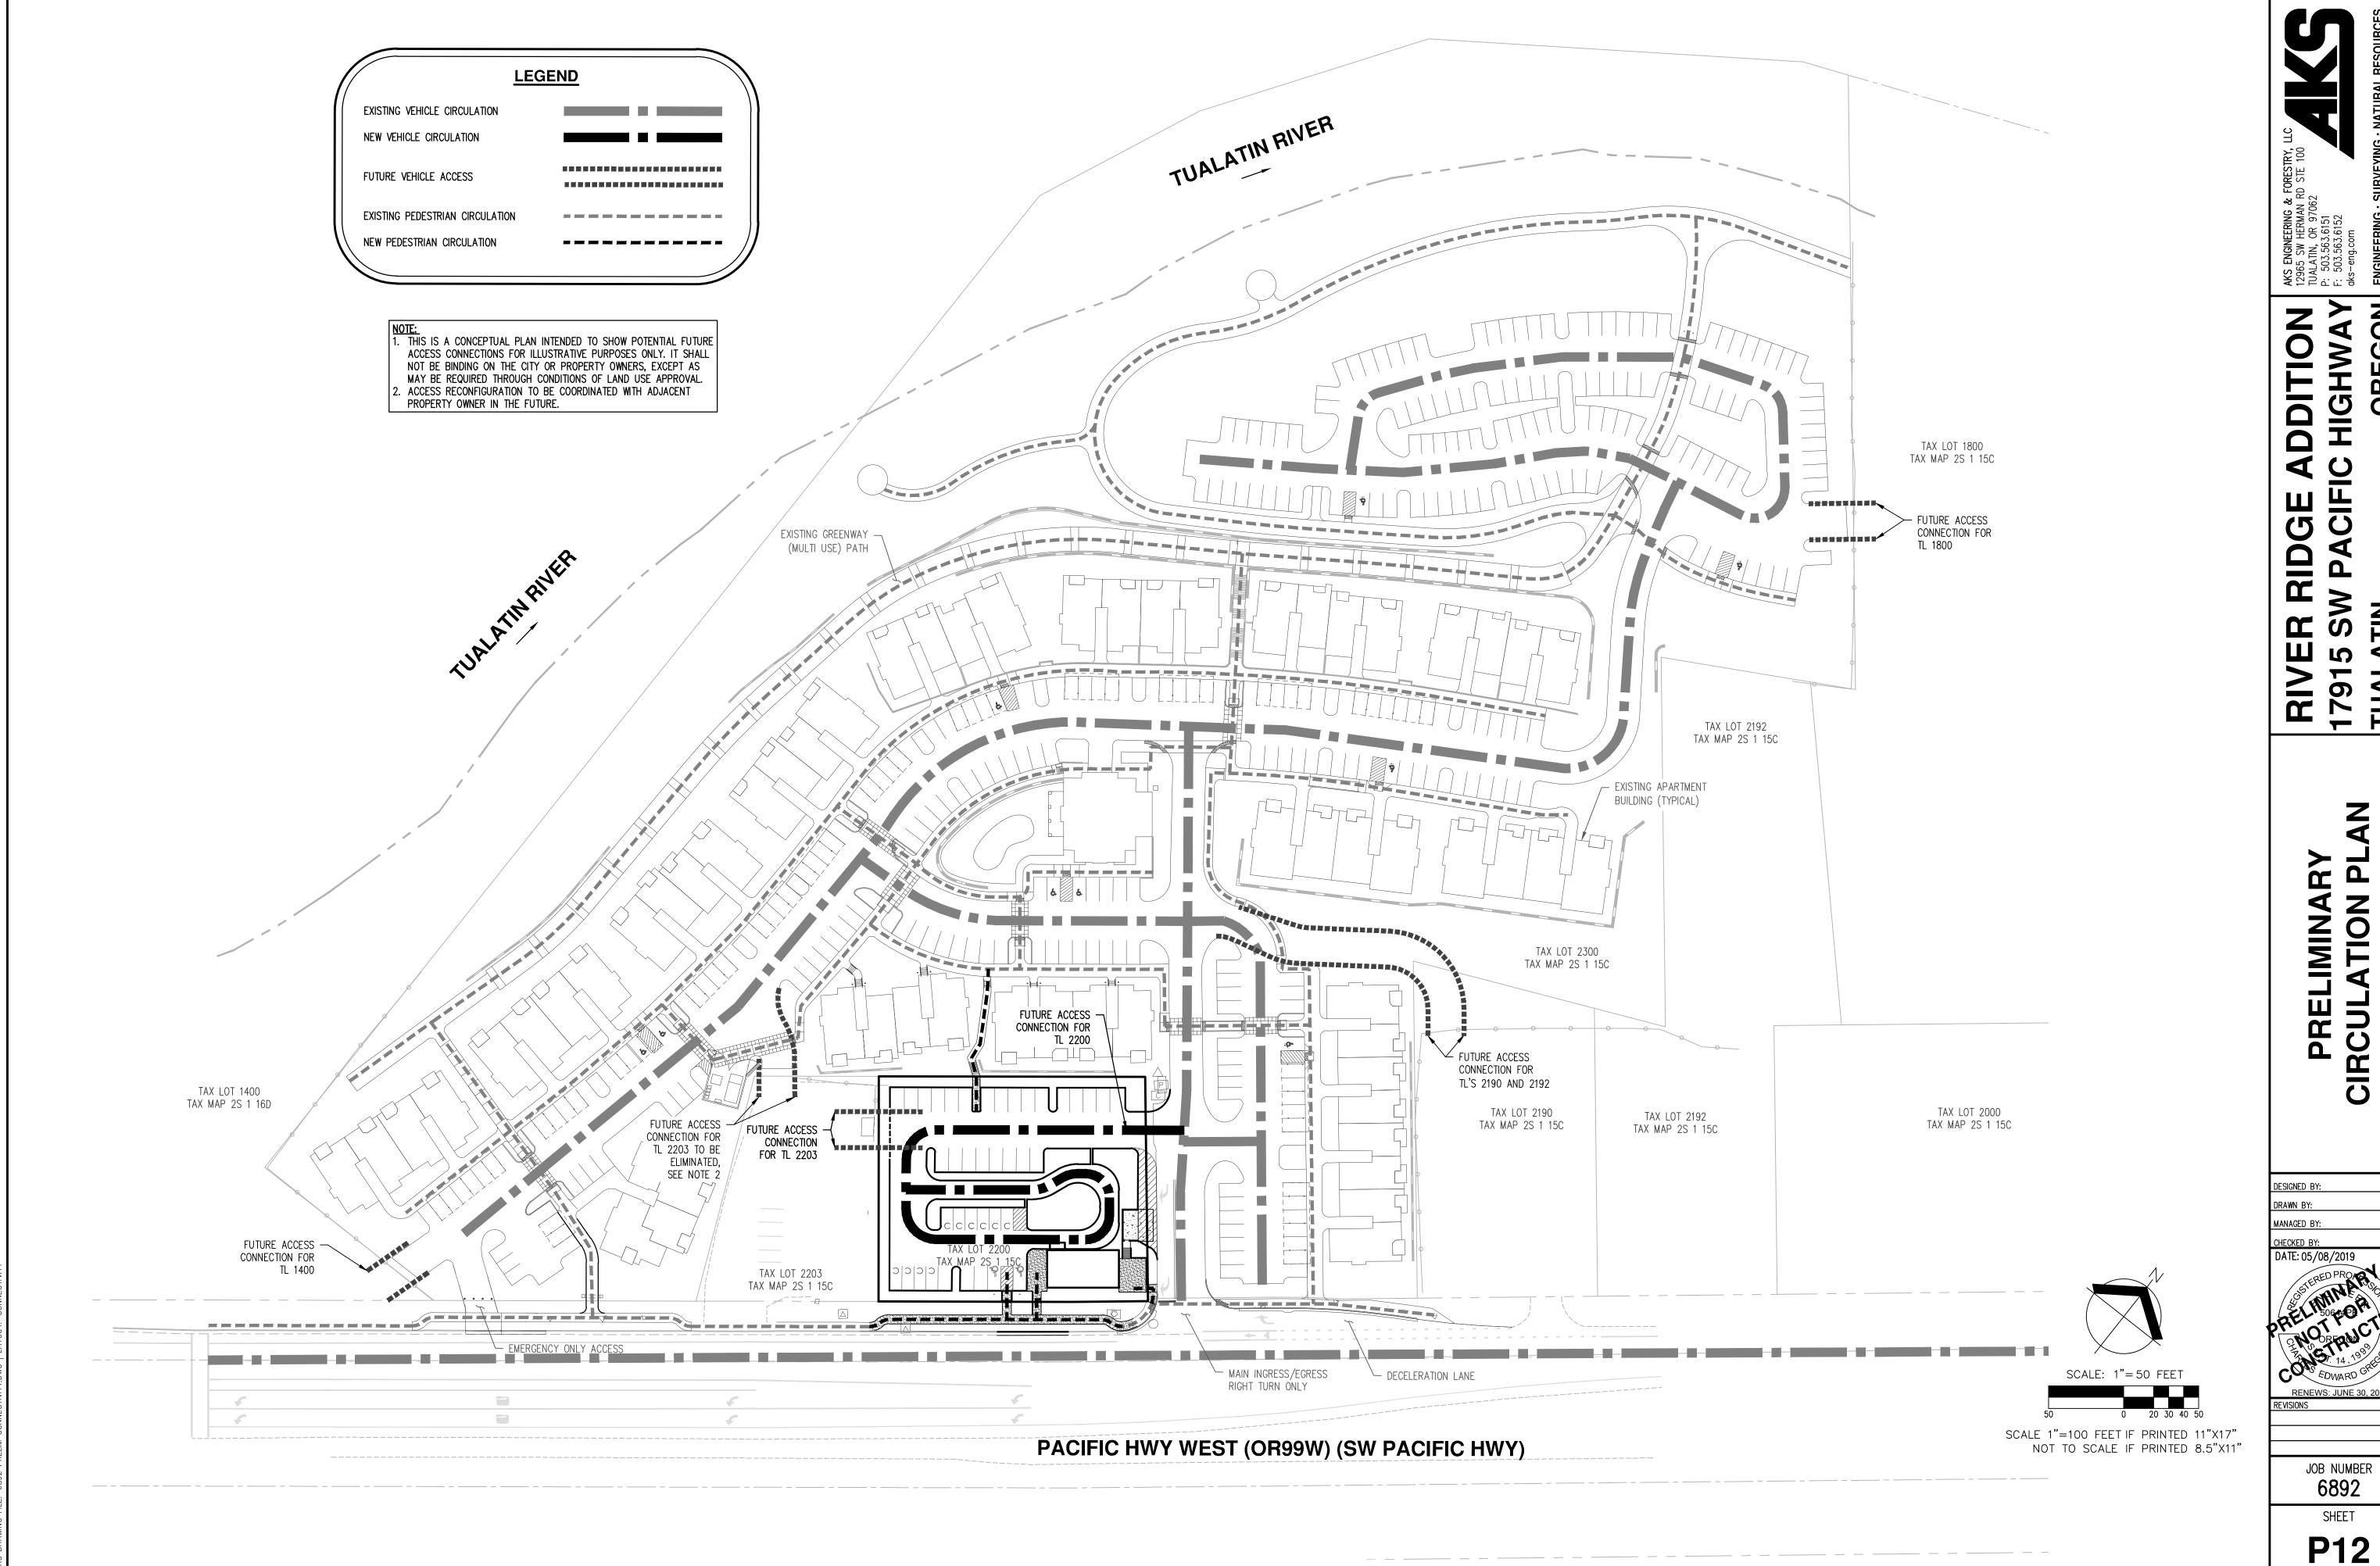


PRELIMINA RCULATION

DATE: 05/08/2019

JOB NUMBER 6892

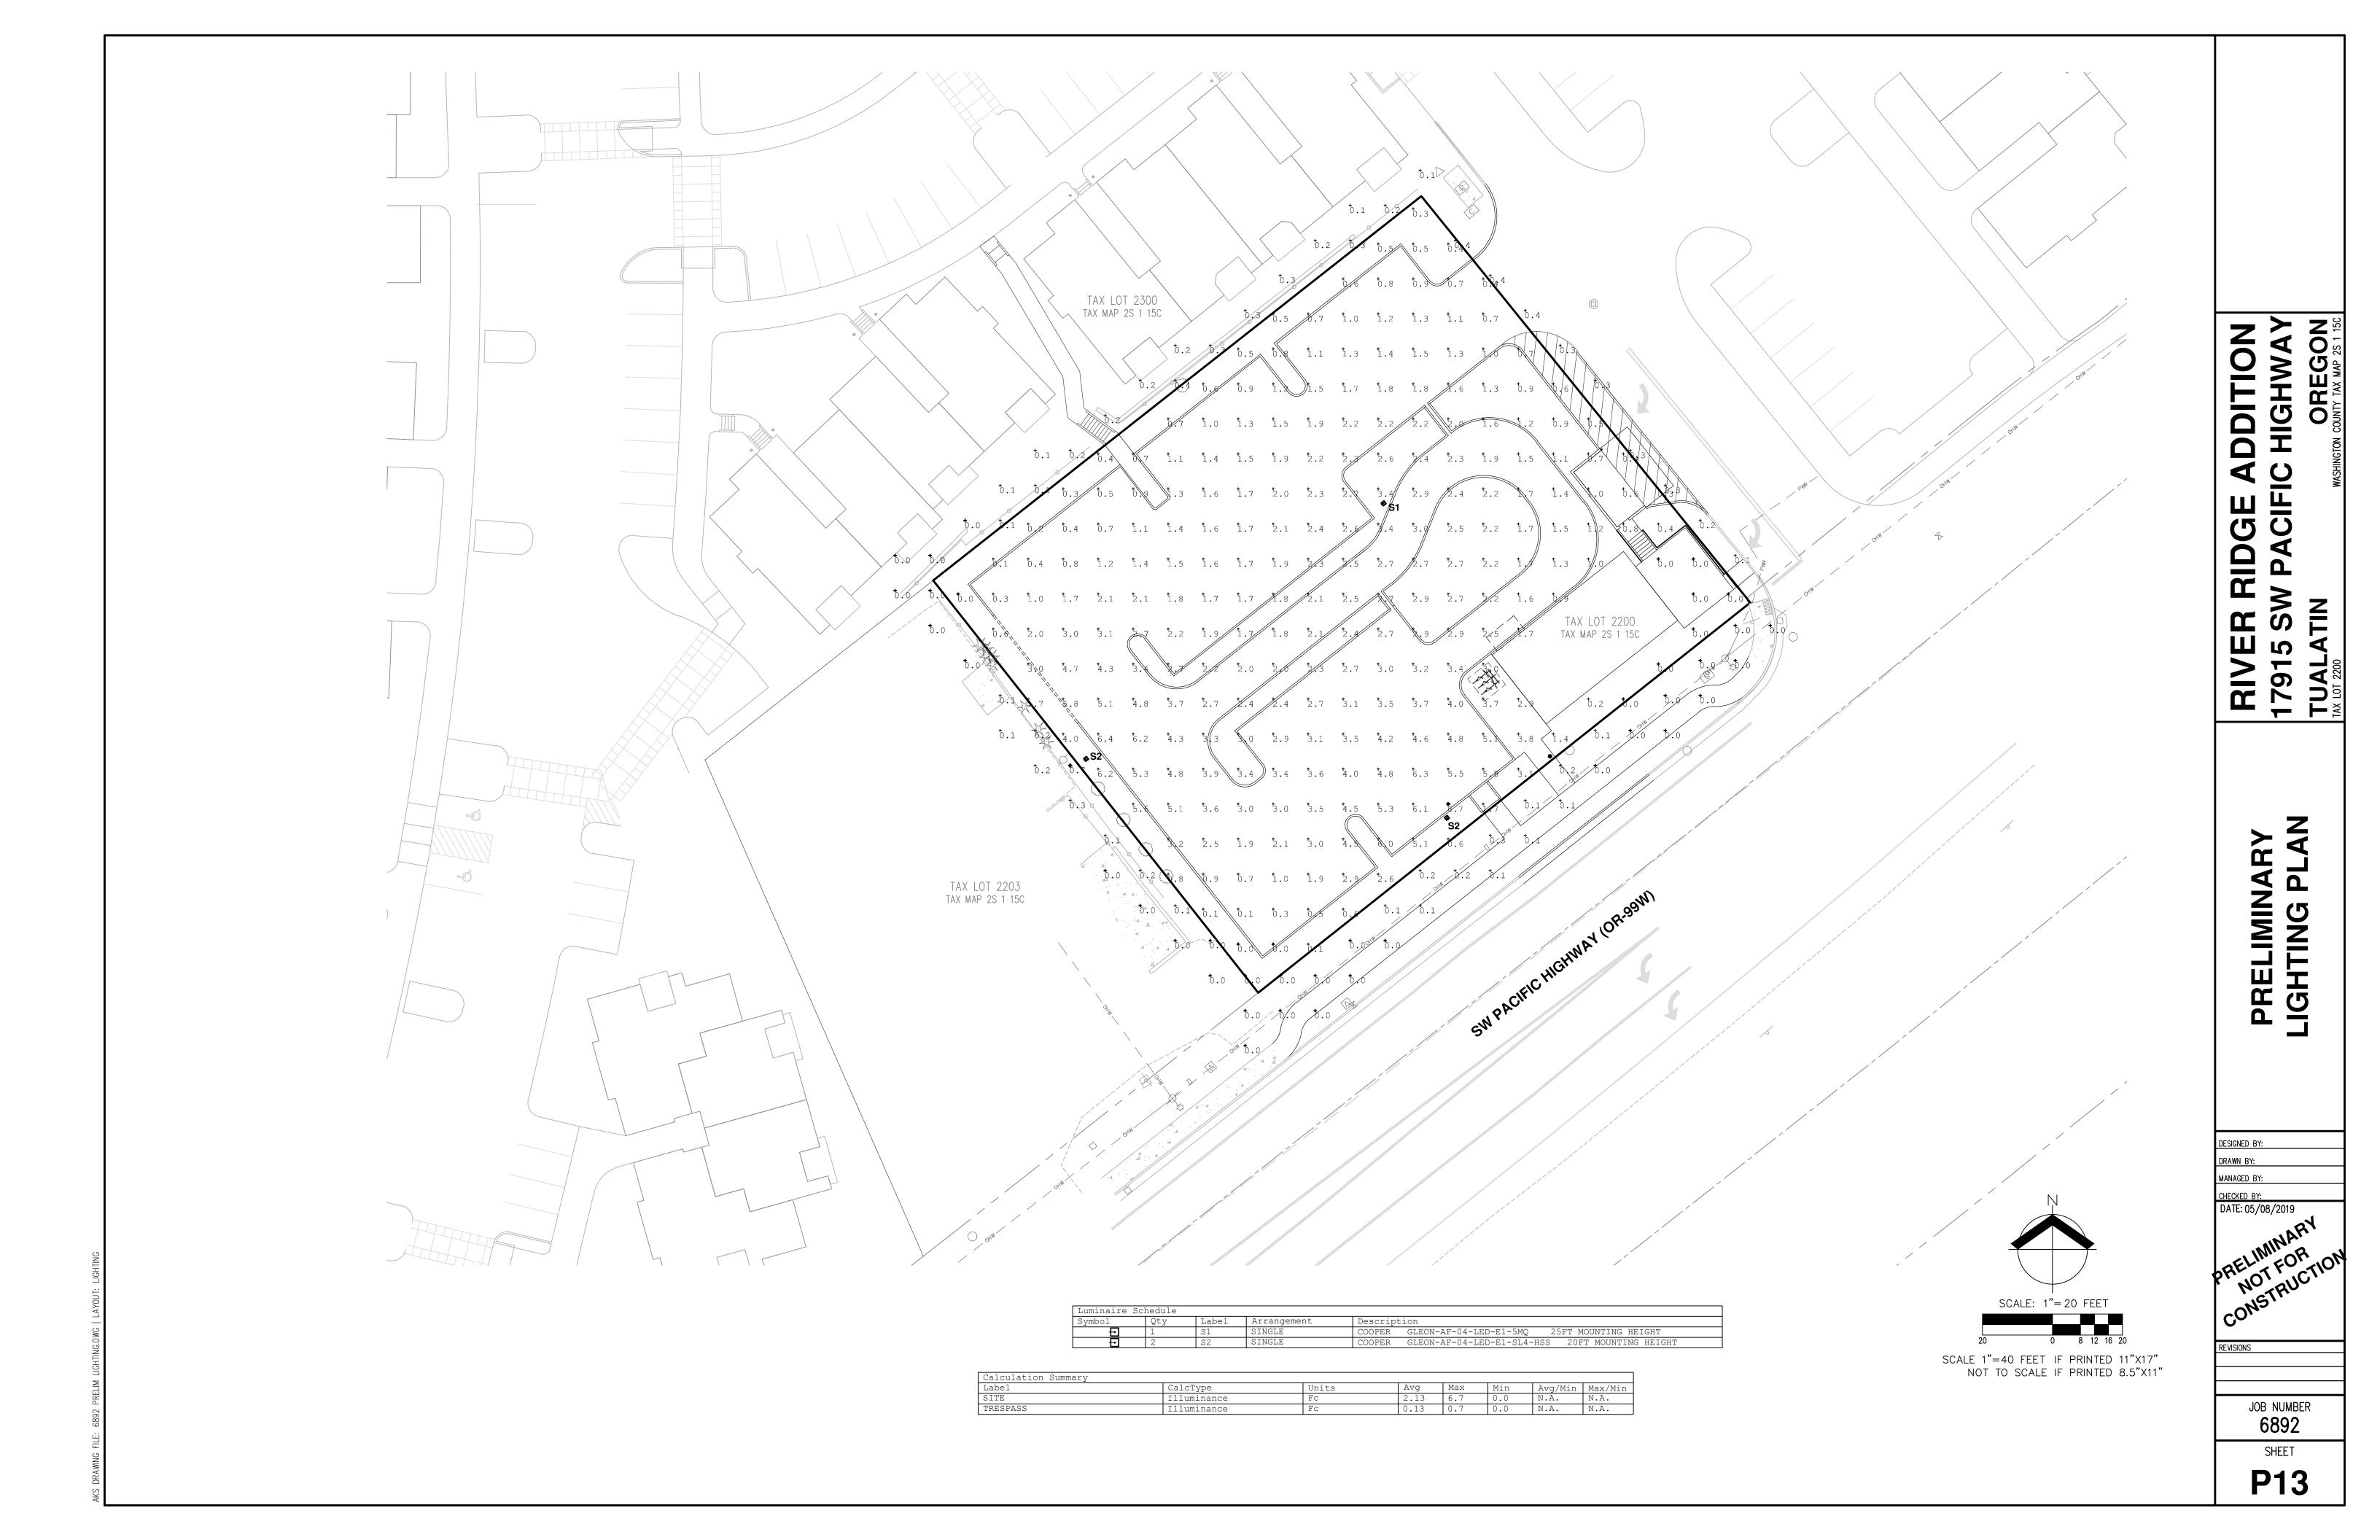

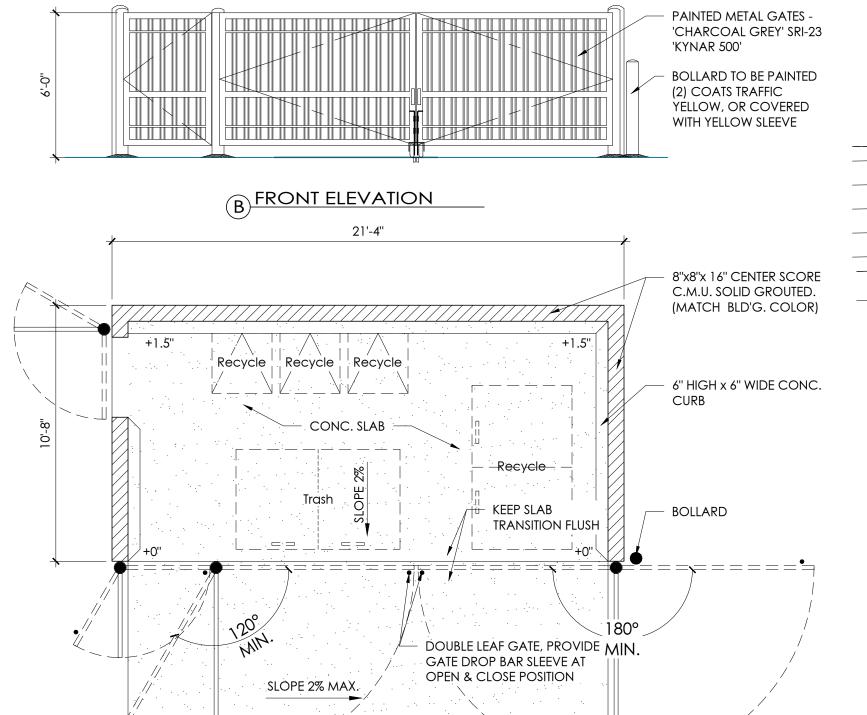

TRASH ENCLOSURE



BICYCLE RACK/SHELTER

CIT		A 7	- A	
21	D	ΑI	IA	

PLANNING DISTRICT : CG

PAVEMENT AREA:

SITE AREA: 26,711 S.F. (0.61 ACRES) SITE COVERAGE: 4.5% PLANNED LANDSCAPE AREA: ±7,200 S.F. PARKING LOT LANDSCAPE AREA: ±1,414 S.F.

±16,551 S.F.

BUILDING

PAD:

AREA

1,200 S.F.

TOTAL BUILDING AREA:

STANDARD PARKING PROVIDED:

COMPACT PARKING PROVIDED:

HANDICAP PARKING PROVIDED:

27 SPACES

(25.6%)


10 SPACES

2 SPACES

TOTAL PARKING FOR RETAIL AND APARTMENT USE PROVIDED:

BICYCLE PARKING PROVIDED: 3 SPACES

39 SPACES

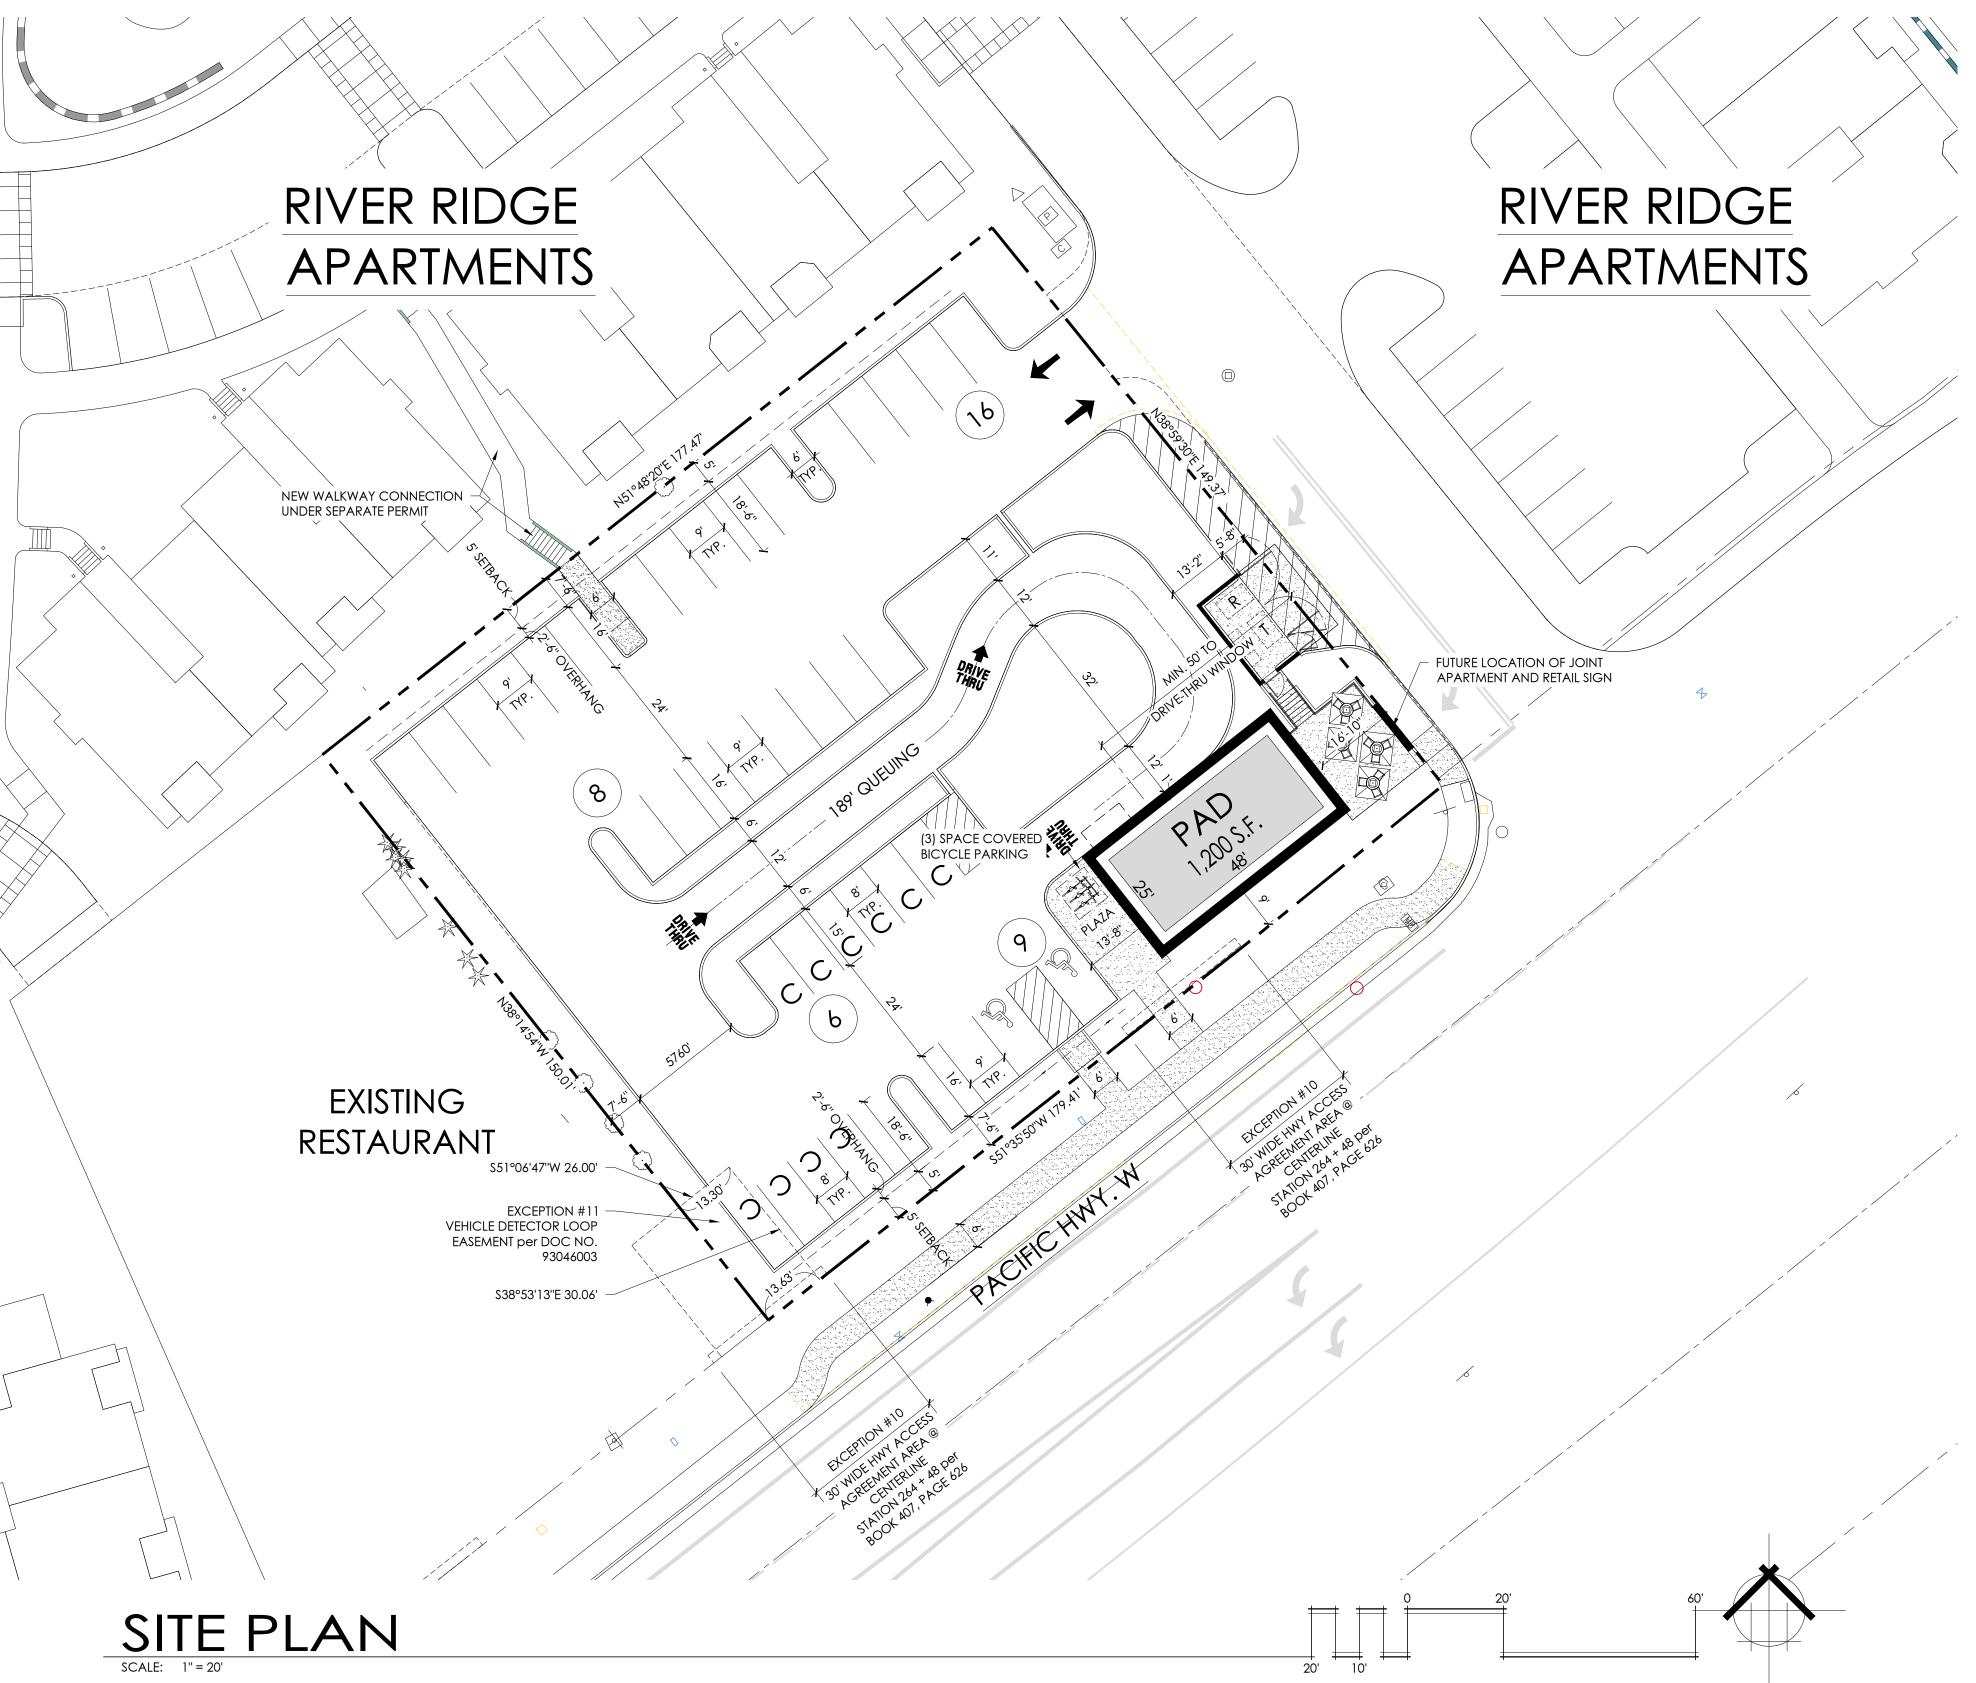

VER RIDGE ADDITION cific HWY 99 W | Tualatin, Oregon

PROJECT NO.
18-120
DRAWN BY:

CHECKED BY

JB

DATE:


March 27, 2019 REVISION:

18-120sd13




BENNER STANGE ASSOCIATES ARCHITECTS, INC.

THE WATERMAN BUILDING 80 SE MADISON STREET SUITE 430 PORTLAND, OR 97214 503-670-0234 FAX 503-670-0235 bsa@bsaarch.com

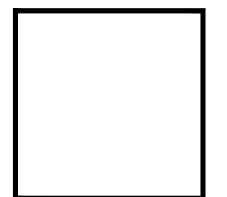

ANY REPRODUCTION AND/OR MODIFICATION IN ANY FORM OF THIS DOCUMENT IS PROHIBITED WITHOUT THE WRITTEN PERMISSION OF BENNER STANGE ASSOCIATES ARCHITECTS, INC

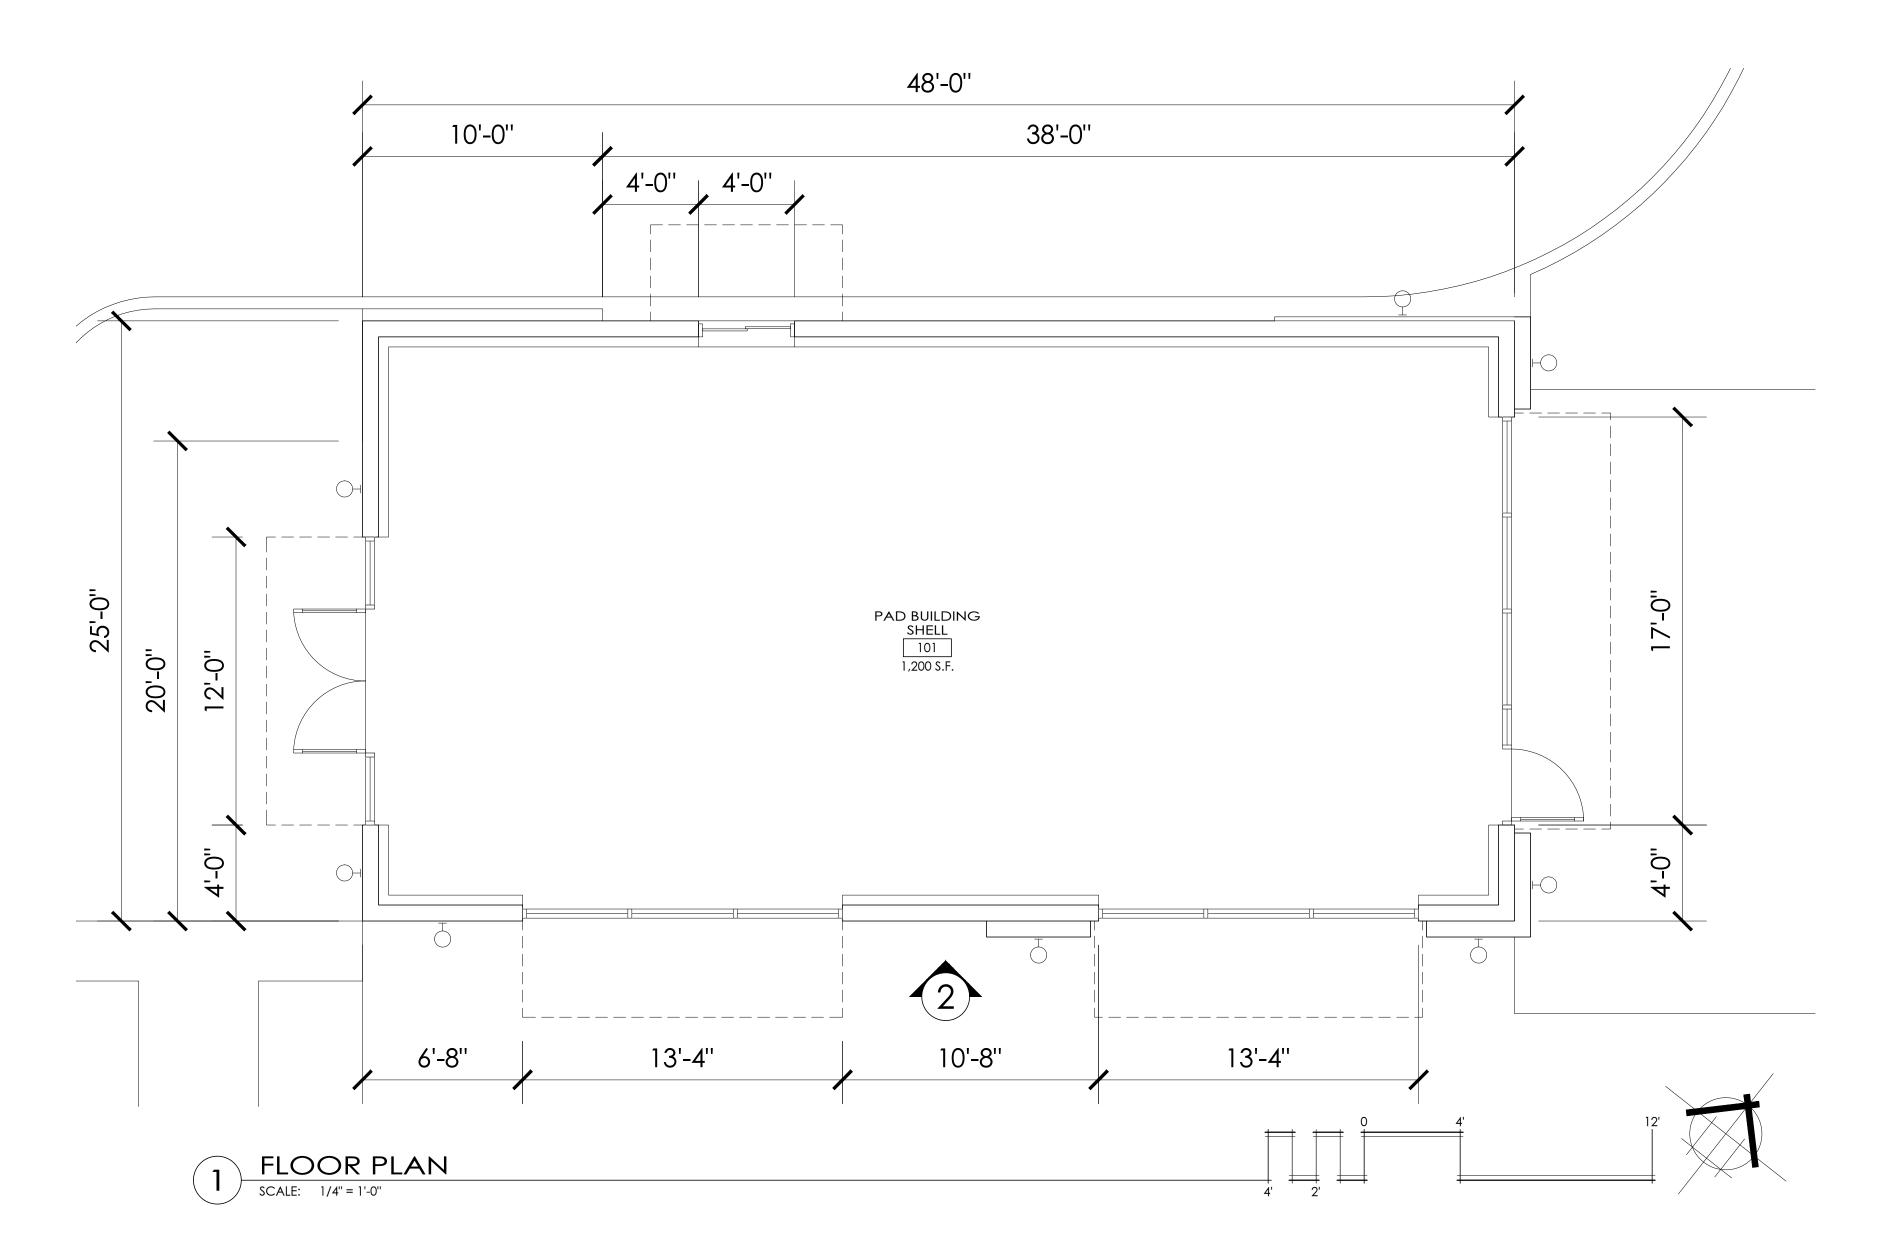



PERSPECTIVE VIEW

N.T.S.



3 PERSPECTIVE VIEW

RIVER RIDGE ADDITION

Pacific HWY 99 W | Tualatin, Oregon

MOUNTAIN WEST

DRAWN BY:

CHECKED BY:

DATE:
March 27, 2019

REVISION:


x18120 pl1



A R C H I T E C T S , INC.

THE WATERMAN BUILDING
80 SE MADISON STREET
SUITE 430
PORTLAND, OR 97214
503-670-0234
FAX 503-670-0235
bsa@bsaarch.com

FLOOR PLAN

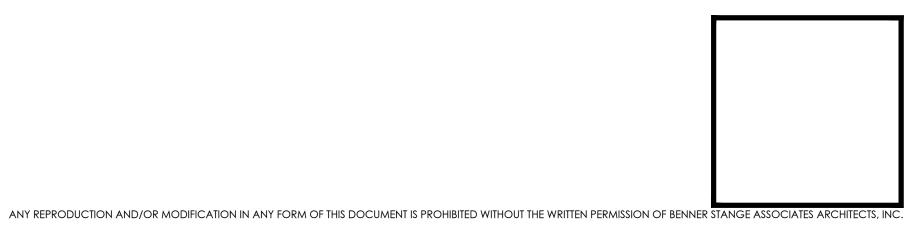





PROJECT NO. 18-120

DRAWN BY:

CHECKED BY:

DATE:

March 27, 2019

REVISION: 18-120_elev

BENNER STANGE **ASSOCIATES** ARCHITECTS, INC.

THE WATERMAN BUILDING 80 SE MADISON STREET SUITE 430 PORTLAND, OR 97214 503-670-0234 FAX 503-670-0235

bsa@bsaarch.com

EXTERIOR ELEVATIONS



F.\ 2018 RSA Projects\ 18_120 Pivers Pidae Pad - Tualatin OP\ 03 Design Development\ PENDEPINGS\ 18_120 FI EV dwa

RIVER RIDGE ADDIIION

Pacific HWY 99 W | Tualatin, Oregon

18-120 DRAWN BY :

CHECKED BY:

JB DATE: April 11, 2019 REVISION:

18-120_elev



BENNER STANGE ASSOCIATES ARCHITECTS, INC.

THE WATERMAN BUILDING 80 SE MADISON STREET SUITE 430 PORTLAND, OR 97214 503-670-0234 FAX 503-670-0235 bsa@bsaarch.com

EXTERIOR ELEVATIONS

DD3

ANY REPRODUCTION AND/OR MODIFICATION IN ANY FORM OF THIS DOCUMENT IS PROHIBITED WITHOUT THE WRITTEN PERMISSION OF BENNER STANGE ASSOCIATES ARCHITECTS, INC.