

Service Provider Letter

CWS File Number	
18-000	1889

This form and the attached conditions will serve as your Service Provider Letter in accordance with Clean Water Services Design and Construction Standards (R&O 17-5).

Junsaiction:	uaiatin	Review Type:	No impact
Site Address	12505 SW Herman RD	SPL Issue Date:	July 20, 2019
/ Location:	Tualatin, OR 97062	SPL Expiration Dat	July 20, 2018 e: July 19, 2020
	Tualatiff, OR 97002	SPL Expiration Dat	e. July 19, 2020
Applicant Infor	mation:	Owner Information:	:
Name	,	Name	
Company	AAI ENGINEERING INC	CompanyBl	EHBAHANY PROPERTIES LLC
Address	4875 SW GRIFFITH DR	Address 12	2505 SW HERMAN RD
	BEAVERTON OR 97005		UALATIN OR 97062
Phone/Fax	(503) 620-3030	Phone/Fax	
E-mail:	andisheha@aaieng.com	E-mail:	
-	Tax lot ID		Development Activity
2S121DD001		Commercial addi	
201210000		The second secon	scape medians and restriping.
•	•		vacabo moditano tana rootiiping.
9	-		
-			
Pre	-Development Site Conditions:	Post D	Development Site Conditions:
Sensitive Area P	resent: X On-Site X Off-S	ite Sensitive Area Pres	ent: X On-Site X Off-Site
Vegetated Corric	for Width: variable: 5-30	Vegetated Corridor	Width: variable: 5-30
Vegetated Corrid	lor Condition: Degraded		
Enhancement o	f Remaining		18
Vegetated Corri		Square Footage to	be enhanced: 1,428
	Encroachments into	Pre-Development Vegetated Co	prridor
T		To bevelopment vegetated of	
	n of Encroachment:		Square Footage:
none			0
	Mitio	ation Requirements:	
T 0	· · · · · · · · · · · · · · · · · · ·	auon noquiromonio	O., El /D. // /O. /
Type/Location			Sq. Ft./Ratio/Cost
n/a			0
Conditions A	Attached X Development Figures At	tached (2) X Planting Plan A	Attached Geotech Report Required
This Service	Provider Letter does NOT	eliminate the need to ev	valuate and protect water qualit
	eas if they are subsequently		

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In order to comply with Clean Water Services water quality protection requirements the project must comply with the following conditions:

- 1. No structures, development, construction activities, gardens, lawns, application of chemicals, uncontained areas of hazardous materials as defined by Oregon Department of Environmental Quality, pet wastes, dumping of materials of any kind, or other activities shall be permitted within the sensitive area or Vegetated Corridor which may negatively impact water quality, except those allowed in R&O 17-5, Chapter 3.
- 2. Prior to any site clearing, grading or construction the Vegetated Corridor and water quality sensitive areas shall be surveyed, staked, and temporarily fenced per approved plan. During construction the Vegetated Corridor shall remain fenced and undisturbed except as allowed by R&O 17-5, Section 3.06.1 and per approved plans.
- 3. If there is any activity within the Sensitive Area, the applicant shall gain authorization for the project from the Oregon Department of State Lands (DSL) and US Army Corps of Engineers (USACE). The applicant shall provide Clean Water Services or its designee (appropriate city) with copies of all DSL and USACE project authorization permits.
- 4. An approved Oregon Department of Forestry Notification is required for one or more trees harvested for sale, trade, or barter, on any non-federal lands within the State of Oregon.
- 5. **Prior to ground disturbance an erosion control permit is required from the City.**Appropriate Best Management Practices (BMP's) for Erosion Control, in accordance with Clean Water Services' Erosion Prevention and Sediment Control Planning and Design Manual, shall be used prior to, during, and following earth disturbing activities.
- 6. Prior to construction, a Stormwater Connection Permit from Clean Water Services or its designee is required pursuant to Ordinance 27, Section 4.B.
- 7. Activities located within the 100-year floodplain shall comply with R&O 17-5, Section 5.10.
- 8. Removal of native, woody vegetation shall be limited to the greatest extent practicable.
- 9. If applicable, the water quality swale and detention pond shall be planted with Clean Water Services approved native species, and designed to blend into the natural surroundings.
- 10. Should final development plans differ significantly from those submitted for review by Clean Water Services, the applicant shall provide updated drawings, and if necessary, obtain a revised Service Provider Letter.

SPECIAL CONDITIONS

- 11. For Vegetated Corridors up to 50 feet wide, the applicant shall enhance the entire Vegetated Corridor to meet or exceed good corridor condition as defined in R&O 17-5, Section 3.14.2, Table 3-3.
- 12. Prior to any site clearing, grading or construction, the applicant shall provide Clean Water Services with a Vegetated Corridor enhancement/restoration plan. Enhancement/restoration of the Vegetated Corridor shall be provided in accordance with R&O 17-5, Appendix A, and shall include planting specifications for all Vegetated Corridor, including any cleared areas larger than 25 square feet in Vegetated Corridor rated ""good.""
- 13. Prior to installation of plant materials, all invasive vegetation within the Vegetated Corridor shall be removed per methods described in Clean Water Services' Integrated Vegetation and Animal Management Guidance, 2003. During removal of invasive vegetation care shall be taken to minimize impacts to existing native tree and shrub species.
- 14. Clean Water Services shall be notified 72 hours prior to the start and completion of enhancement/restoration activities. Enhancement/restoration activities shall comply with the guidelines provided in Planting Requirements (R&0 17-5, Appendix A).
- 15. Maintenance and monitoring requirements shall comply with R&O 17-5, Section 2.12.2. If at any time during the warranty period the landscaping falls below the 80% survival level, the owner shall reinstall all deficient planting at the next appropriate planting opportunity and the two year maintenance period shall begin again from the date of replanting.

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- 16. Performance assurances for the Vegetated Corridor shall comply with R&O 17-5, Section 2.07.2, Table 2-1 and Section 2.11, Table 2-2.
- 17. Clean Water Services shall require an easement over the Sensitive Area and Vegetated Corridor conveying storm and surface water management to Clean Water Services or the City that would prevent the owner of the Vegetated Corridor from activities and uses inconsistent with the purpose of the corridor and any easements therein.

FINAL PLANS

- 18. Final construction plans shall include landscape plans. In the details section of the plans, a description of the methods for removal and control of exotic species, location, distribution, condition and size of plantings, existing plants and trees to be preserved, and installation methods for plant materials is required. Plantings shall be tagged for dormant season identification and shall remain on plant material after planting for monitoring purposes.
- 19. A Maintenance Plan shall be included on final plans including methods, responsible party contact information, and dates (minimum two times per year, by June 1 and September 30).
- 20. Final construction plans shall clearly depict the location and dimensions of the sensitive area and the Vegetated Corridor (indicating good, marginal, or degraded condition). Sensitive area boundaries shall be marked in the field.
- 21. Protection of the Vegetated Corridors and associated sensitive areas shall be provided by the installation of permanent fencing and signage between the development and the outer limits of the Vegetated Corridors. Fencing and signage details to be included on final construction plans.

This Service Provider Letter is not valid unless CWS-approved site plan is attached.

Please call (503) 681-3639 with any questions.


Laurie Bunce

Environmental Plan Review

Attachments (4)

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		4
	4.	
	4	



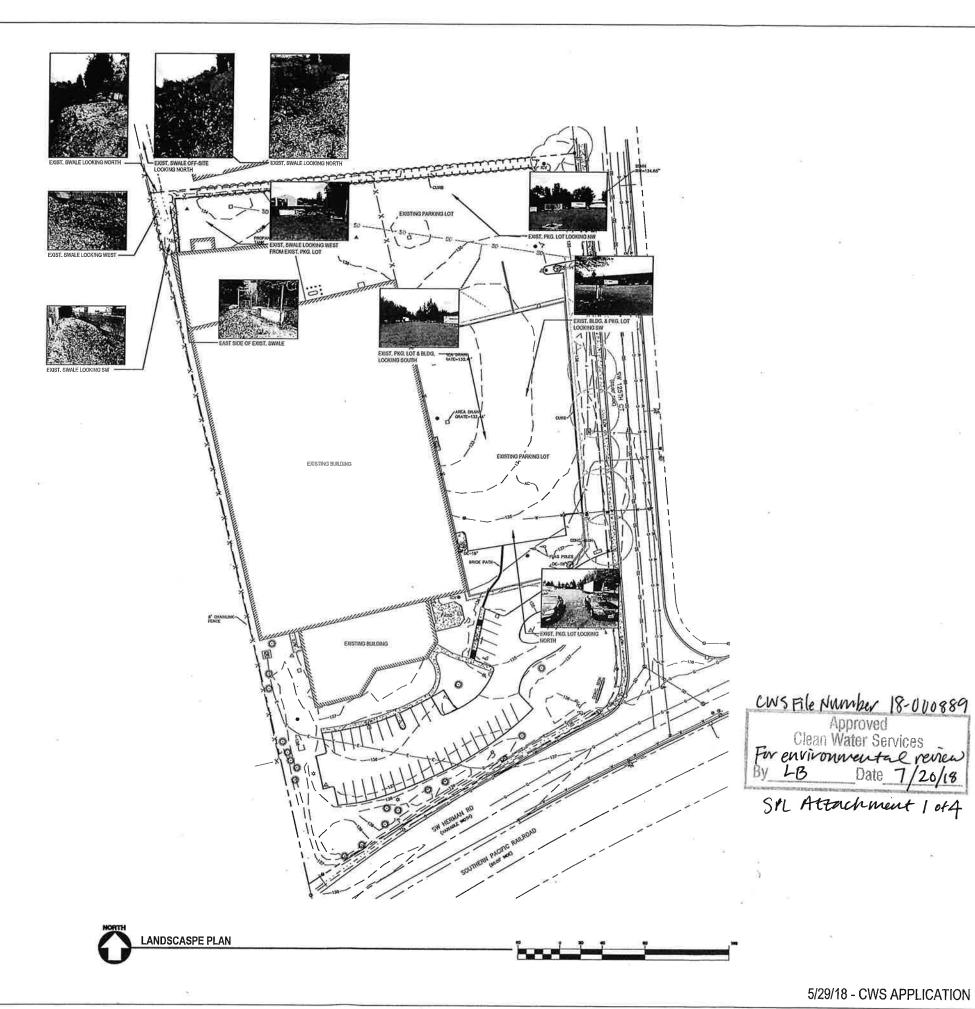



API INTERNATIONAL
12505 SW HERMAN ROAD
TUALATIN OREGON


EXISTING CONDITIONS

PLAN
DATE: 04/16/18

CHECKED:

L0.0 JOB NUMBER: A17116.20

5/29/18 - CWS APPLICATION

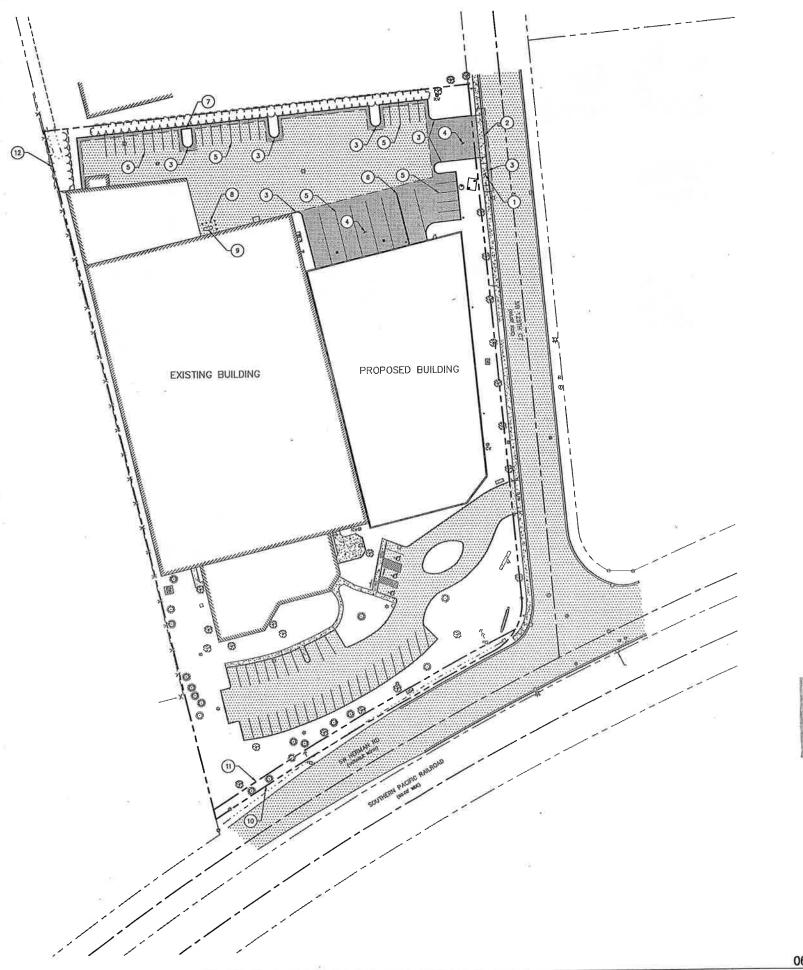

SHEET NOT

- SEE ARCHITECTURAL PLANS FOR ADDITIONAL INFORMATION.
- 2. THE CONTRACTOR SHALL HAVE A FULL SET OF THE CURRENT APPROVED CONSTRUCTION DOCUMENTS INCLUDING ADDENDA ON THE PROJECT SITE AT ALL TIME
- 3. THE CONTRACTOR SHALL KEEP THE ENGINEER AND JURISDICTION INFORMED OF CONSTRUCTION PROGRESS TO FACILITATE SITE OBSERVATIONS AT REQUIRED INTERVALS. 24-HOUR NOTICE IS REQUIRED.

LEGENDS

PROPERTY LINE

PROPOSED CURB

CONCRETE SIDEWALK SURFACING

ETE SIDEWALK CING

ASPHALT SURFACING


X CONSTRUCTION NOTES

- 1 INSTALL SIDEWALK PER DETAIL 2/C4.
- 2 INSTALL DRIVEWAY PER CITY OF TUALATIN DETAI 441/C4.0
- 3 INSTALL CURB PER DETAIL 1/C4.
- 4 INCTALL ACCUALT 3 /CAD
- 5 INSTALL STRIPING
- INSTALL WA
- INSTALL 12" CURB FLOW THROUGH
- 8 INSTALL PIPE BOLLARD PER DETAIL 5/C4.0
- 9 RELOCATE EXISTING PROPANE TANK
- 10 EXISTING RIGHT-OF-WAY
- 11 PROPOSED RIGHT-OF-WAY
- 12 AREA OF "FLOOD PLAIN" ON-SITE

CWS File NO 18-000889

Approved
Clean Water Services
For environmental review
By LB Date 7/20/18

SPL Attachment 2014

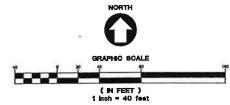

ENGINEERING

FING IN EERING

FIND PAY SAIS 300 Benevator, OR 1 87005

State | 503.520.5539 fax | www.assieng.com

EXPIRES: 8/30/2019



1885 SW 72MD AVE SUITE 200
PORTLAND, OREGON S7224
FEL: 803.226.1285
FAX: 803.226.1970
WWW.CIDAINO.COM

INTERNATIONAL
12505 SW HERMAN ROAD
TUALATIN OREGON

01777 01 4

SITE PLAN

DATE: 04/16/18
DRAWN: NJD
CHECKED: NWS


REVISIONS:

AT MANNER, EXCEPT WITH THE PR PRITER PERMERSION OF AM KINGERSKA INC.

C1.0

JOB NUMBER: A17116.11

06/11/2018 - DESIGN REVIEW RESUBMITTAL

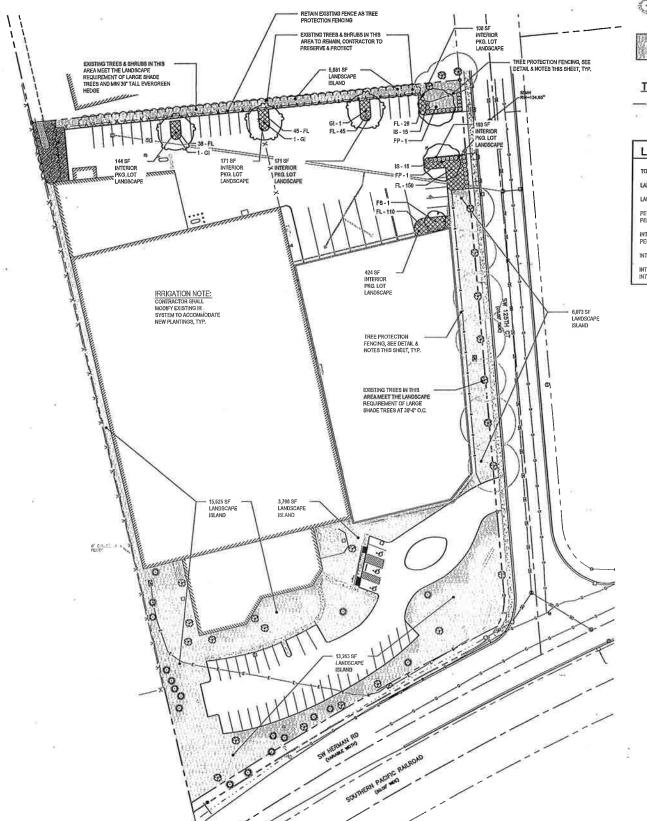

LANDSCASPE PLAN

Ö



TREE PROTECTION FENCE

LEGEND

LANDSCAPE REQUIREM	ENTS
TOTAL SITE AREA	= 210,562 SF
LANDSCAPE AREA REQUIRED 15% OF SITE	= 31,584 SF
LANDSCAPE ARE PROPOSED 21.6% OF SITE	= 45,549 SF
PERIMETER PKG, LOT LANDSCAPING REQ. PERIMETER PKG, LOT LANDSCAPING PROPOSI	= 5'-0" MIN LANDSCAPE STRIP ED = 9'-6" LANDSCAPE STRIP
INTERIOR PKG, LOT ISLAND REQ = 25 SF PER PKG, STALL = 25 x 26 STALL	= 650 SF
INTERIOR PKG, LOT LANDSCAPE PROPOSED	= 1,211 SF
INTERIOR PKG, LOT TREES REQUIRED INTERIOR PKG, LOT TREES PROPOSED	=6 >6

PLANTING NOTES

- VERIFY THE LOCATION OF ALL UNDERGROUND UTILITIES, LINES, PIPES, VAULTS, OR BOXES PRIOR TO EXCAVATION. 2. AND PROTECT ALL UTILITIES, SITE FEATURES AND VEGETATION TO REMAIN IN PLACE. ANY DAMAGE TO ANY KNOWN EXISTING UTILITY ELEMENTS SHALL BE REPAIRED PROPERLY AND IMMEDIATELY.
- MAINTAIN ALL ROADWAYS AND PAVED PATHWAYS CLEAN AND FREE OF CONSTRUCTION MATERIALS AND DEBRIS, PROVIDING NECESSARY DUST CONTROL WHERE REQUIRED.
- 8. U COORDINATE AND SCHEDULE ALL WORK WITH THE OWNER'S REPRESENTATIVE

- 11. CONTRACTOR SHALL SUBMIT CERTIFIED TOPSOIL ANALYSIS REPORT FOR OWNERS APPROVAL PRIOR TO PLANT INSTALLATION.
- CONTRACTOR IS RESPONSIBLE FOR ANY AMENDMENTS TO SOIL PH FERTILITY AND/OR DRAINAGE CONDITIONS NECESSARY TO ENSURE PROPER GROWING CONDITIONS FOR PROPOSED PLANTINGS.

- 16. CONTRACTOR SHALL RE-DESIGN THE IRRIGATION SYSTEM AND PROVIDE OWNER WITH SHOP DRAWINGS FOR APPROVAL. SEE SPECS
- 17. PRIOR TO FINAL ACCEPTANCE, CONTRACTOR SHALL PROVIDE OWNER WITH AS-BUILT PLANS OF THE INSTALLATION, COPIES OF ALL OPERATION MANUALS AND WARRANTY DOCUMENTS.
- 18. ALL NEW PLANTS IN LANDSCAPE AREAS SHALL BE WARRANTED FOR A PERIOD OF ONE YEAR FROM THE DATE OF FINAL ACCEPTANCE

TREES	CODE	QTY	BOTANICAL NAME	COMMON NAME	SIZE	
$\overline{(\cdot)}$	FP	2	FRAXINUS PENNSYLVANICA "PATMORE" WELL BRANCHED AND LIMBED TO 8'-0"	"PATMORE" ASH	1,5° CAL.	
$\overset{\smile}{\odot}$	FS	1	FRAXINUS PENNSYLVANICA "SUMMIT" WELL BRANCHED AND LIMBED TO 8'-0"	SUMMIT ASH	1,5° CAL	
$\widetilde{\overline{(\cdot)}}$	GI	3	GLEDITSIA TRIACANTHOS INERMIS 'TRUESHADE' WELL BRANCHED AND LIMBED TO 6'-0"	THORNLESS HONEY LOCUST	1.5" CAL	
SHRUBS	CODE	QTY	BOTANICAL NAME	COMMON NAME	SIZE	
0	is	31	ILEX GLABRA "SHAMROCK" MAINTAIN HEIGHT AT 30"	INXBERRY	1 GAL	
GROUND COVERS	CODE	QTY	BOTANICAL NAME	COMMON NAME	SIZE	SPACING
	FL.	417	FRAGARIA CHILOENSIS "LIPSTICK"	BEACH STRAWBERRY	4" POT	24° o.c.

EXISTING VEGETATION IN SWALE TO REMAIN, DO NOT

VEGETATIVE CORRIDOR TREES REQUIRED SHRUBS REQUIRED

TREES - 2 GAL ACER CIRCINATUM / VINE MAPLE

SHRUBS - 1 GAL CORNUS SERICEA / RED-OSIER DOGWOOD PYSOCARPUS CAPITATUS / NINEBARK HOLODISCUS DISCOLOR / OCEANSPRAY SPIRAEA DOUGLASII / DOUGLAS SPIRAEA SYMPHORICARPUS ALBUS / SNOWBERRY

CWS File No. 18.000889 Approved Clean Water Services For environmental review By LB Date 7/20/18

SPL Attachment 3 of4

VEGETATIVE CORRIDOR PLANTING PLAN SCALE: 1:10

06/11/2018 - DESIGN REVIEW RESUBMITTAL



ENGINEERING
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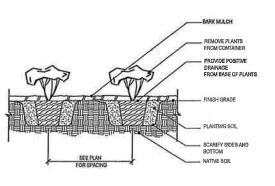
INTERNATIONAL HERMAN ROAD 12505 SW I API


DATE: 04/16/18 DRAWN: CHECKED:


O AM ENGINEETING INC. 2018, ALL RUGHTE RESERVES


SHEET LANDSCAPE PLAN

JOB NUMBER: A17116.20



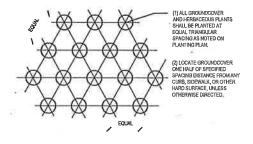

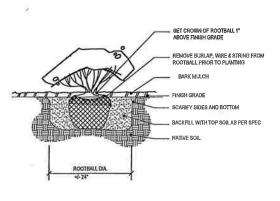

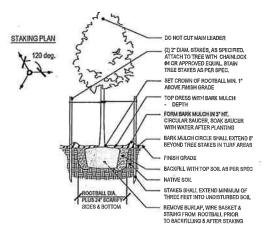



L2.0 SCALE: NTS

GROUNDCOVER & HERBACEOUS \PLANT PLANTING PLAN


3 SHRUB PLANTING L2.0 SCALE: NTS


4 DECIDUOUS TREE PLANTING DETAIL


L2.0 SCALE: NTS



<u>GPM</u>	PIPE SIZE
0-9	3/4*
9-18	1.
18-26	1-1/4"
26-35	1-1/2*
35-55	2"

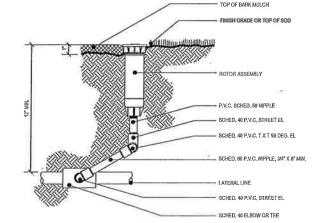

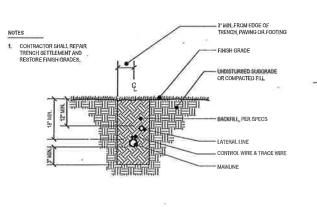

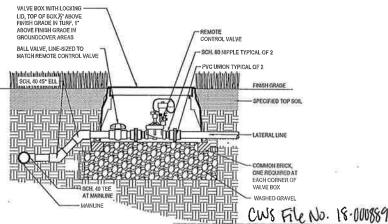



L2.0 SCALE: NTS


6 \SPRAY HEAD ASSEMBLY W/ SWING JOINT 12.0 SCALE: NTS


7 IR TRENCHING DETAIL L2.0 SCALE: NTS

8 REMOTE CONTROL VALVE 12.0 SCALE: NTS

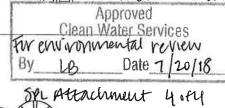

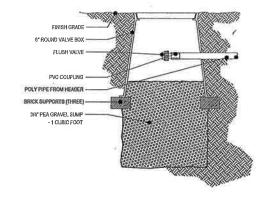

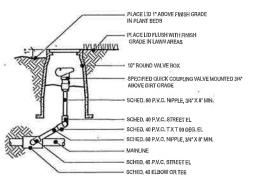

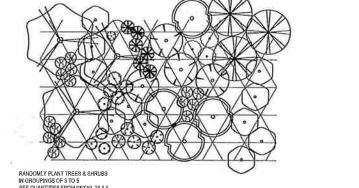

9 FLUSH VALVE L2.0 SCALE: NTS

QUICK COUPLER VALVE DETAIL
12.0 SCALE: NTS

11 VEGETATIVE CORRIDOR PLANTING DETAIL L1.1 N.T.S.

06/11/2018 - DESIGN REVIEW RESUBMITTAL

PERMIN OREGON CAPE ARCHIT

ERING

Serverten, OR 197005 ENGINE BEING 4 ₹

ENGINEERIN PLANNING INTERIORS

SSSS SW 72NG AVE SUITE 20 GRTLAND, GREGON 972 AX: 503.228.187

INTERNATIONAL HERMAN ROAD TIN OREGON TUALATIN NS. API

DATE: 04/16/18 DRAWN: TKL HECKED: TKL

AAI ENGINEERING INC.

LANDSCAPE **DETAILS**

L2.0

JOB NUMBER: A17116.20